# LIBERTY PROPERTY TRUST

180 SOUTH WARNER ROAD

APPROVED BY THE BOARD OF SUPERVISORS OF UPPER MERION TOWNSHIP ON THE \_\_ DAY OF \_\_\_\_\_, 20\_\_.

## FINAL LAND DEVELOPMENT PLAN

# UPPER MERION TOWNSHIP MONTGOMERY COUNTY, PA

#### REVIEWED BY TOWNSHIP ENGINEER

RECORDED IN THE OFFICE OF RECORDER OF DEEDS IN NORRISTOWN, PA IN PLAN BOOK NO. \_\_\_\_ PAGE NO. \_\_\_\_ ON THE \_\_ DAY OF \_\_\_\_\_\_, 20\_\_\_.

IHEREBY CERTIFY THAT LIBERTY PROPERTY TRUST IS THE REGISTERED OWNER OF THE LAND HEREIN DEVELOPED, AND THAT WE DO HEREBY ADOPT THIS PLAN AND DESIRE THE SAME TO BE RECORDED.

#### CORPORATE ACKNOWLEDGEMENT

ON THE \_\_ DAY OF \_\_\_\_\_ A.D. 2009 BEFORE ME THE SUBSCRIBER, A NOTARY PUBLIC OF THE COMMONWEALTH OF PENNSYLVANIA, RESIDING IN \_\_\_\_\_ PERSONALLY APPEARED MR. ROBERT SEKOLA, WHO ACKNOWLEDGED HIMSELF TO BE THE VICE PRESIDENT OF LIBERTY PROPERTY TRUST, A CORPORATION, AND THAT AS SUCH VICE PRESIDENT BEING AUTHORIZED TO DO SO, HE EXECUTED THE FOREGOING PLAN BY SIGNING THE NAME OF THE SAID CORPORATION BY HIMSELF AS VICE PRESIDENT, THAT THE SAID CORPORATION IS THE OWNER OF THE DESIGNATED LAND, THAT ALL NECESSARY APPROVALS OF THE PLAN HAVE BEEN OBTAINED AND IS ENDORSED THEREON, AND THAT THEY DESIRE THE FOREGOING PLAN TO BE DULY RECORDED.

SECRETARY



SCALE IN FEET

#### ITEMS EXCLUDED FROM TOWNSHIP CODE:

• SECTION 165-193 -- EACH PARKING SPACE RESERVED FOR THE PHYSICALLY HANDICAPPED SHALL BE IDENTIFIED BY A PERMANENTLY AFFIXED REFLECTORIZED SIGN DISPLAYING THE INTERNATIONAL SIGN OF ACCESSIBILITY. IN ACCORDANCE WITH A.D.A. REGULATIONS, 1 IN EVERY 8 ACCESSIBLE SPACES, BUT NOT LESS THAN 1, SHALL BE SERVED BY AN ACCESS AISLE 96 INCHES WIDE MINIMUM AND SHALL BE DESIGNATED WITH A "VAN ACCESSIBLE" SIGN MOUNTED BELOW THE SIGN SHOWING THE SYMBOL OF ACCESSIBILITY.

- SECTION 165-10 -- THE PROPOSED PARKING IN THE NORTHWEST CORNER OF THE PROPERTY IS WITHIN AN AG DISTRICT. (GRANTED 7/17/02)
- SECTION 165-139 -- THE PROPOSED PARKING IN THE NORTHWEST CORNER OF THE PROPERTY IS CLOSER THAN 40 FEET TO AN AG DISTRICT (GRANTED 7/17/02)
- SECTION 165-140 -- THE PROPOSED PARKING IN THE NORTHWEST CORNER OF THE PROPERTY DOES NOT HAVE THE REQUIRED 40 FOOT BUFFER TO AN AG DISTRICT (GRANTED 7/17/02)

#### WAIVERS:

- SECTION 140.7.C(1)(b) -- TO REDUCE STORMWATER FLOWS FROM THE 10-YEAR POST DEVELOPMENT TO THE 2-YEAR PRE-DEVELOPMENT, FOR DRAINAGE AREA 3 ONLY (GRANTED 12/10/02)
- SECTION 140.8.B(2)(d) -- TO PERMIT A MINIMUM PIPE SLOPE LESS THAN 0.005 FT/FT (GRANTED 12/10/02)
- SECTION 145-24.1 -- TO PERMIT LESS THAN THE REQUIRED NUMBER OF PARKING LOT PLANTINGS (GRANTED 12/10/02)
- SECTION 145-29.A.18 & 21 -- THE LOCATION OF ALL NATURAL AND MANMADE FEATURES WITHIN 200 FEET OF THE SITE ARE TO BE PROVIDED (GRANTED 12/10/02)

#### TABLE OF CONTENTS

TITLE SHEET LOT CONSOLIDATION PLAN EXISTING FEATURES PLAN SITE LAYOUT PLAN GRADING AND UTILITY PLAN MISCELLANEOUS DETAILS STORMWATER MANAGEMENT BASIN DETAILS DRAINAGE DETAILS PIPE PROFILES 24-27 EROSION & SEDIMENT POLLUTION CONTROL PLANS 28-30 EROSION & SEDIMENT POLLUTION CONTROL NOTES 31-33 EROSION & SEDIMENT POLLUTION CONTROL DETAILS 34-35 LANDSCAPING PLAN

DAVID A. LINDSAY

P.L.S. SU-42007-E

#### SURVEYORS CERTIFICATION


HEREBY CERTIFY THAT THIS PLAN REPRESENTS A FIELD SURVEY MADE BY ME, THAT THE MONUMENTS SHOWN HEREON EXIST AS LOCATED, AND THAT ALL DIMENSIONAL DETAILS ARE CORRECT.

36-38 LIGHTING PLAN

DATE

PREPARED BY: URS CORPORATION 335 COMMERCE DRIVE, SUITE 300 FT. WASHINGTON, PA 19034-2623

URS PROJECT NUMBER: 21386989

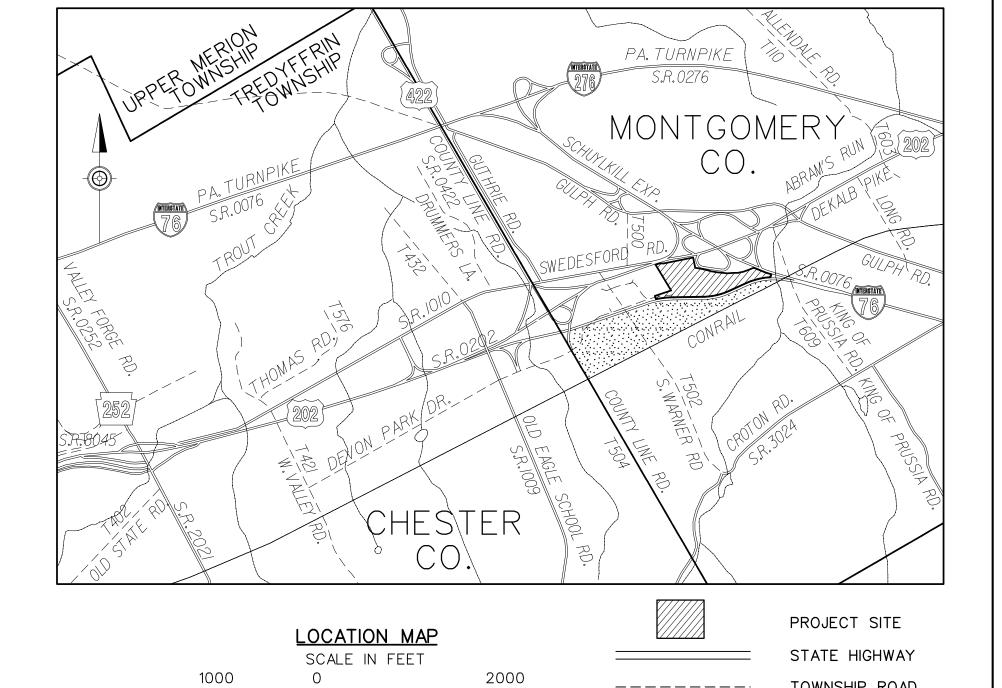

RECORD OWNER:

LIBERTY PROPERTIES, L.P. C/O LIBERTY PROPERTY TRUST 500 CHESTERFIELD PARKWAY MALVERN, PA 19355

## GENERAL SITE DATA

LIBERTY PROPERTIES, L.P. 170 S WARNER RD TAX MAP BLOCK #008, UNIT 025 TAX MAP BLOCK #008, UNIT 026

AGRICULTURAL ZONING

VERTICAL DATUM: THE VERTICAL DATUM FOR THESE PLANS IS NGVD 1929.

THE OWNER WILL PAY FEE IN LIEU OF PARK LAND.

#### **ZONING DATA**

MULTI-TENANT OFFICE BUILDING-APPROX. 000 OCCUPANTS SM-1 SUBURBAN METROPOLITAN

REGULATION		REQUIRED	PROPOSED
MINIMUM LOT MINIMUM FROM MINIMUM SIDE MINIMUM REAF	NT YARD YARD	1 AC 40 FT. 15 FT./40 FT. 20 FT.	19.452 AC (INCLUDES 9.641 AC LEASED AREA 40 FT. 15 FT./40 FT. 20 FT.
MINIMUM AGRI	CULTURAL BUFFER	40 FT.	5FT.
MAXIMUM BUIL MINIMUM NUMI SPACES: OFF	DING COVERAGE DING HEIGHT BER OF PARKING FICES - 3 SPACES PER F GROSS FLOOR AREA	50% 50 FT. 534	10.7% (INCLUDES 9.641 AC LEASED AREA 47.25' FT. 1261 (INCLUDES 21 HANDICAPPED - ACCESSIBLE SPACES)
	BER OF HANDICAPPED- PARKING SPACES	21	21 (INCLUDES 3 VAN ACCESSIBLE SPACES)
MINIMUM GREE	EN AREA	25%	38% (INCLUDES 9.641 AC LEASED AREA

89,181 SF 89,016 SF

AS NOTED

#### SITE DATA

EXISTING OFFICE - GROSS FLOOR AREA 170 S. WARNER ROAD 190 S. WARNER ROAD PROPOSED OFFICE - GROSS FLOOR AREA 180 S. WARNER ROAD

TOTAL OFFICE GROSS FLOOR AREA

82,630 SF 260,827 SF

> NO. DATE REVISIONS

PREPARED BY: **URS** FORT WASHINGTON, PA

LIBERTY PROPERTY TRUST 180 SOUTH WARNER ROAD UPPER MERION TOWNSHIP, MONTGOMERY COUNTY, PENNSYLVANIA

URS CORPORATION Consulting Engineers 335 Commerce Drive • Suite 300 • Fort Washington • PA • 19034-2623 (215) 367-2500 • Fax (215) 367-1000 FIELD BOOK

12/15/08


DRAWN BY CHECKED BY


SML


21386989


SHEET NO.


1 OF 38

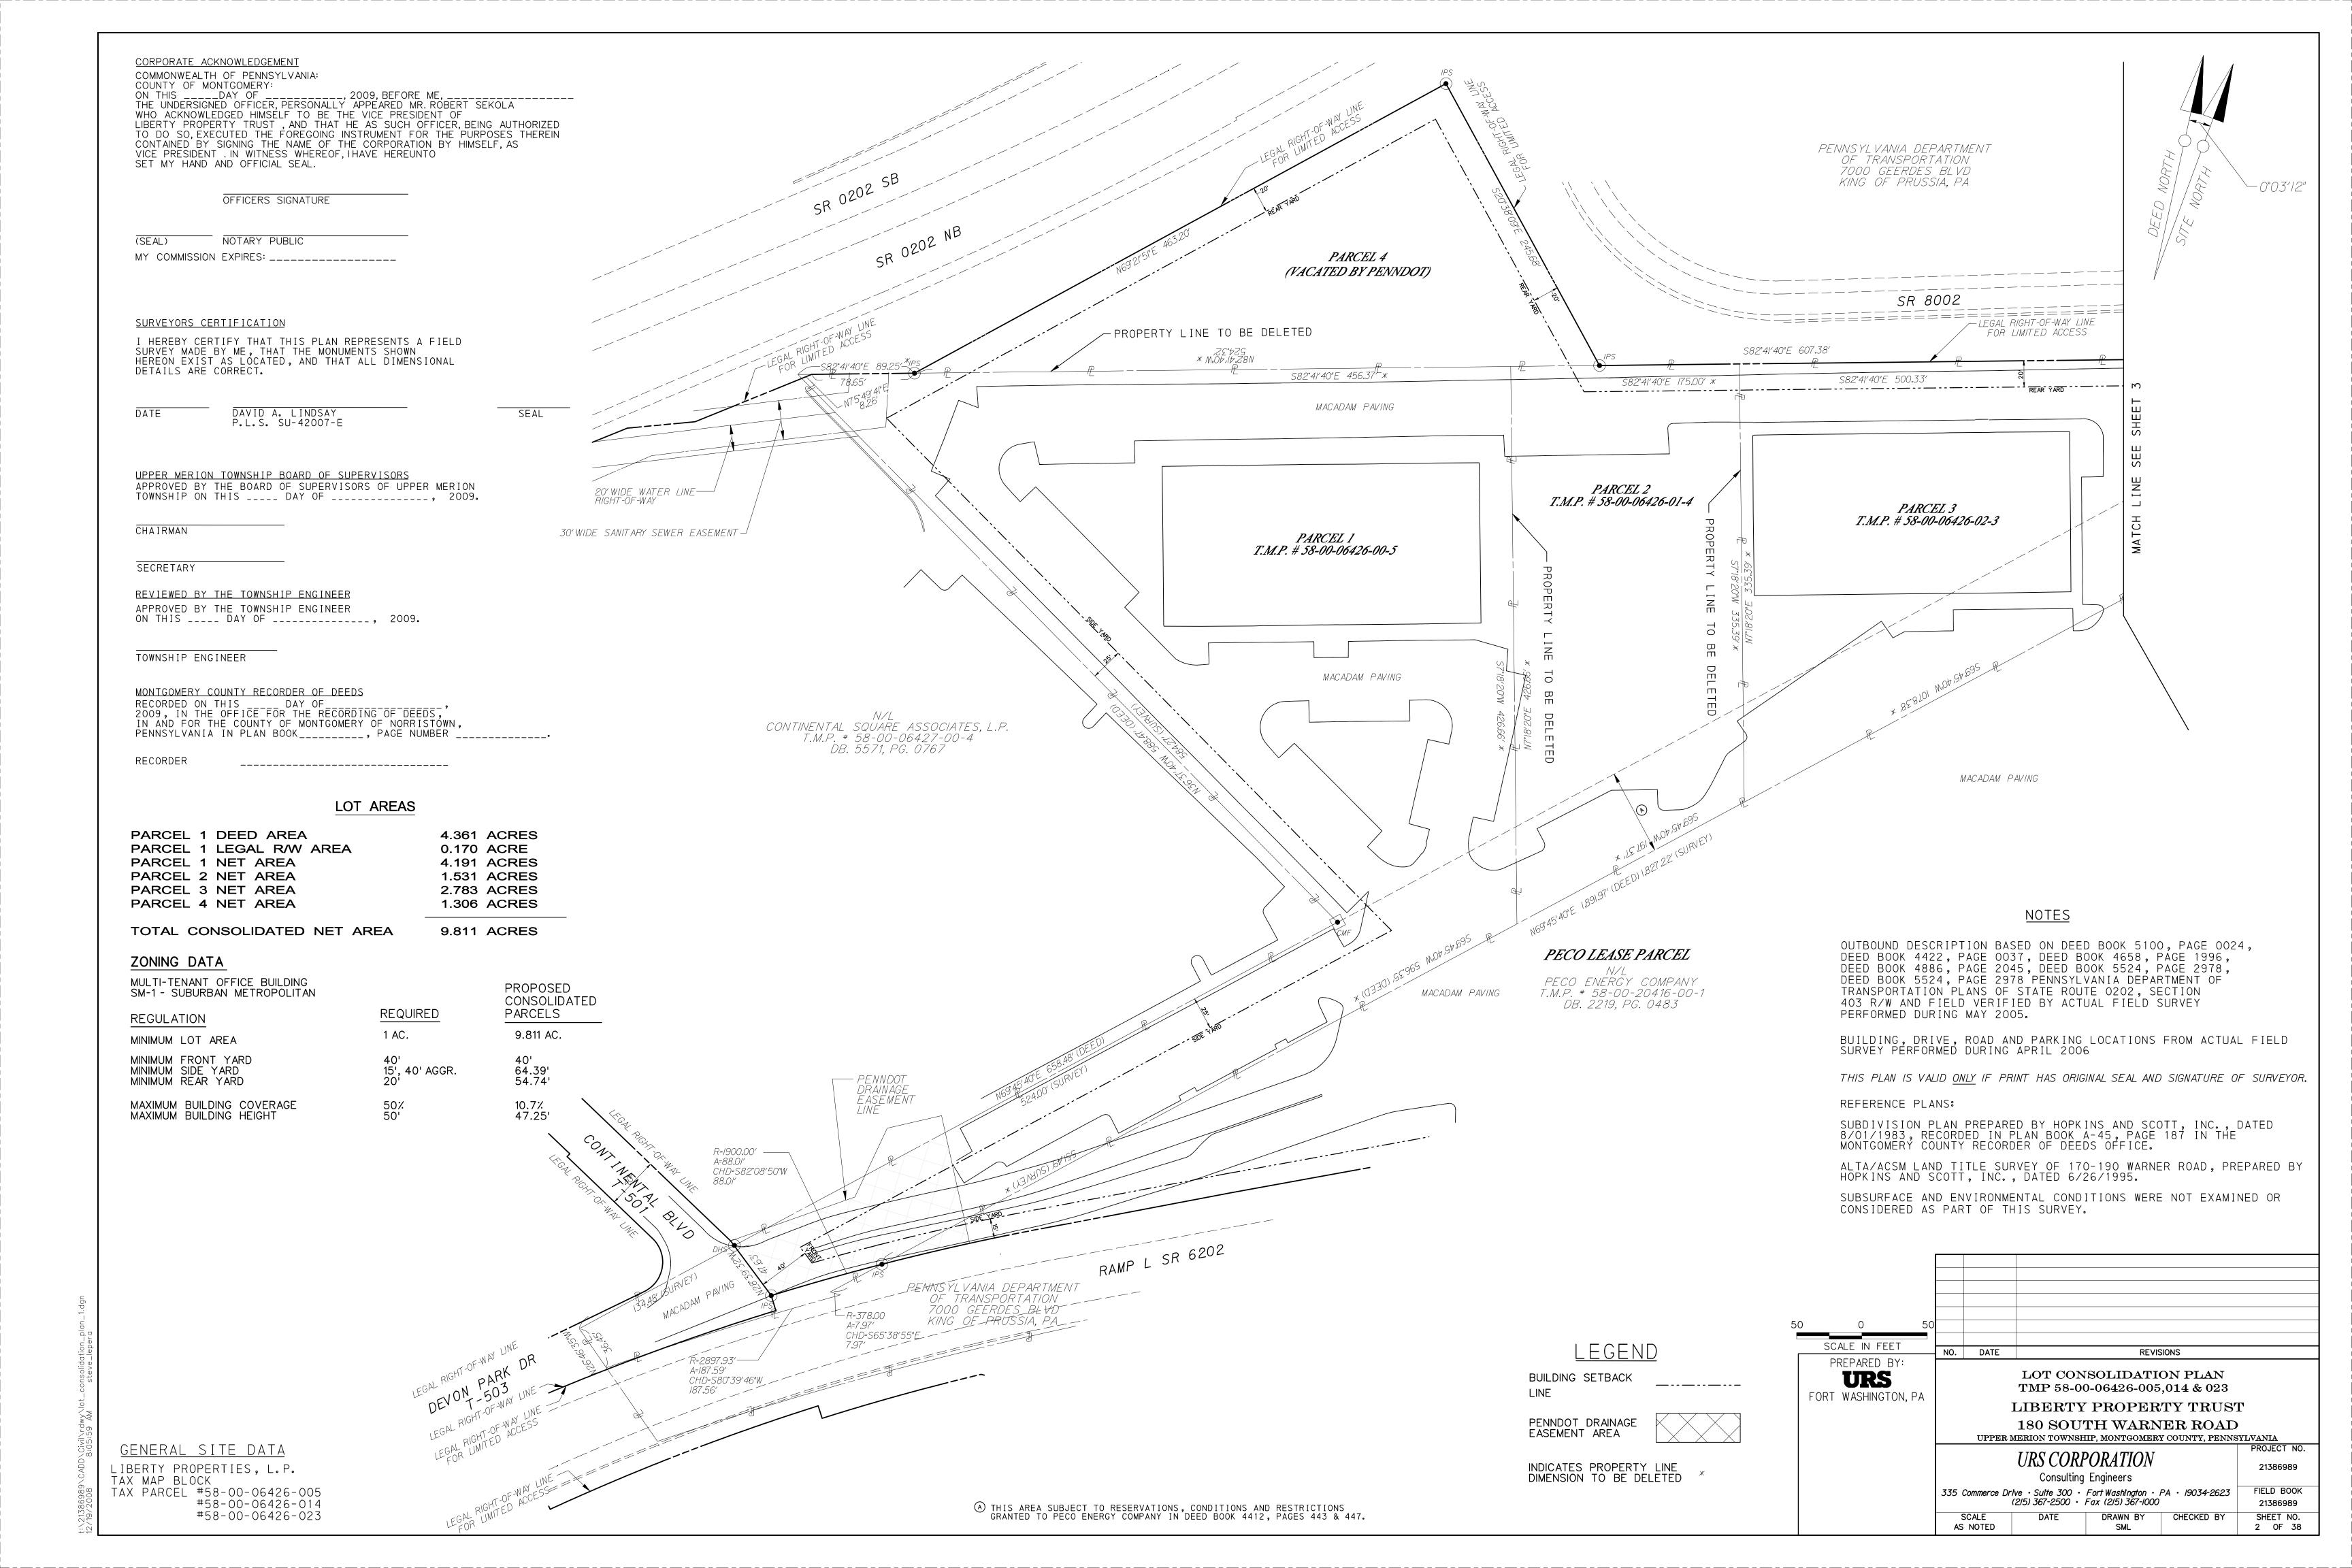


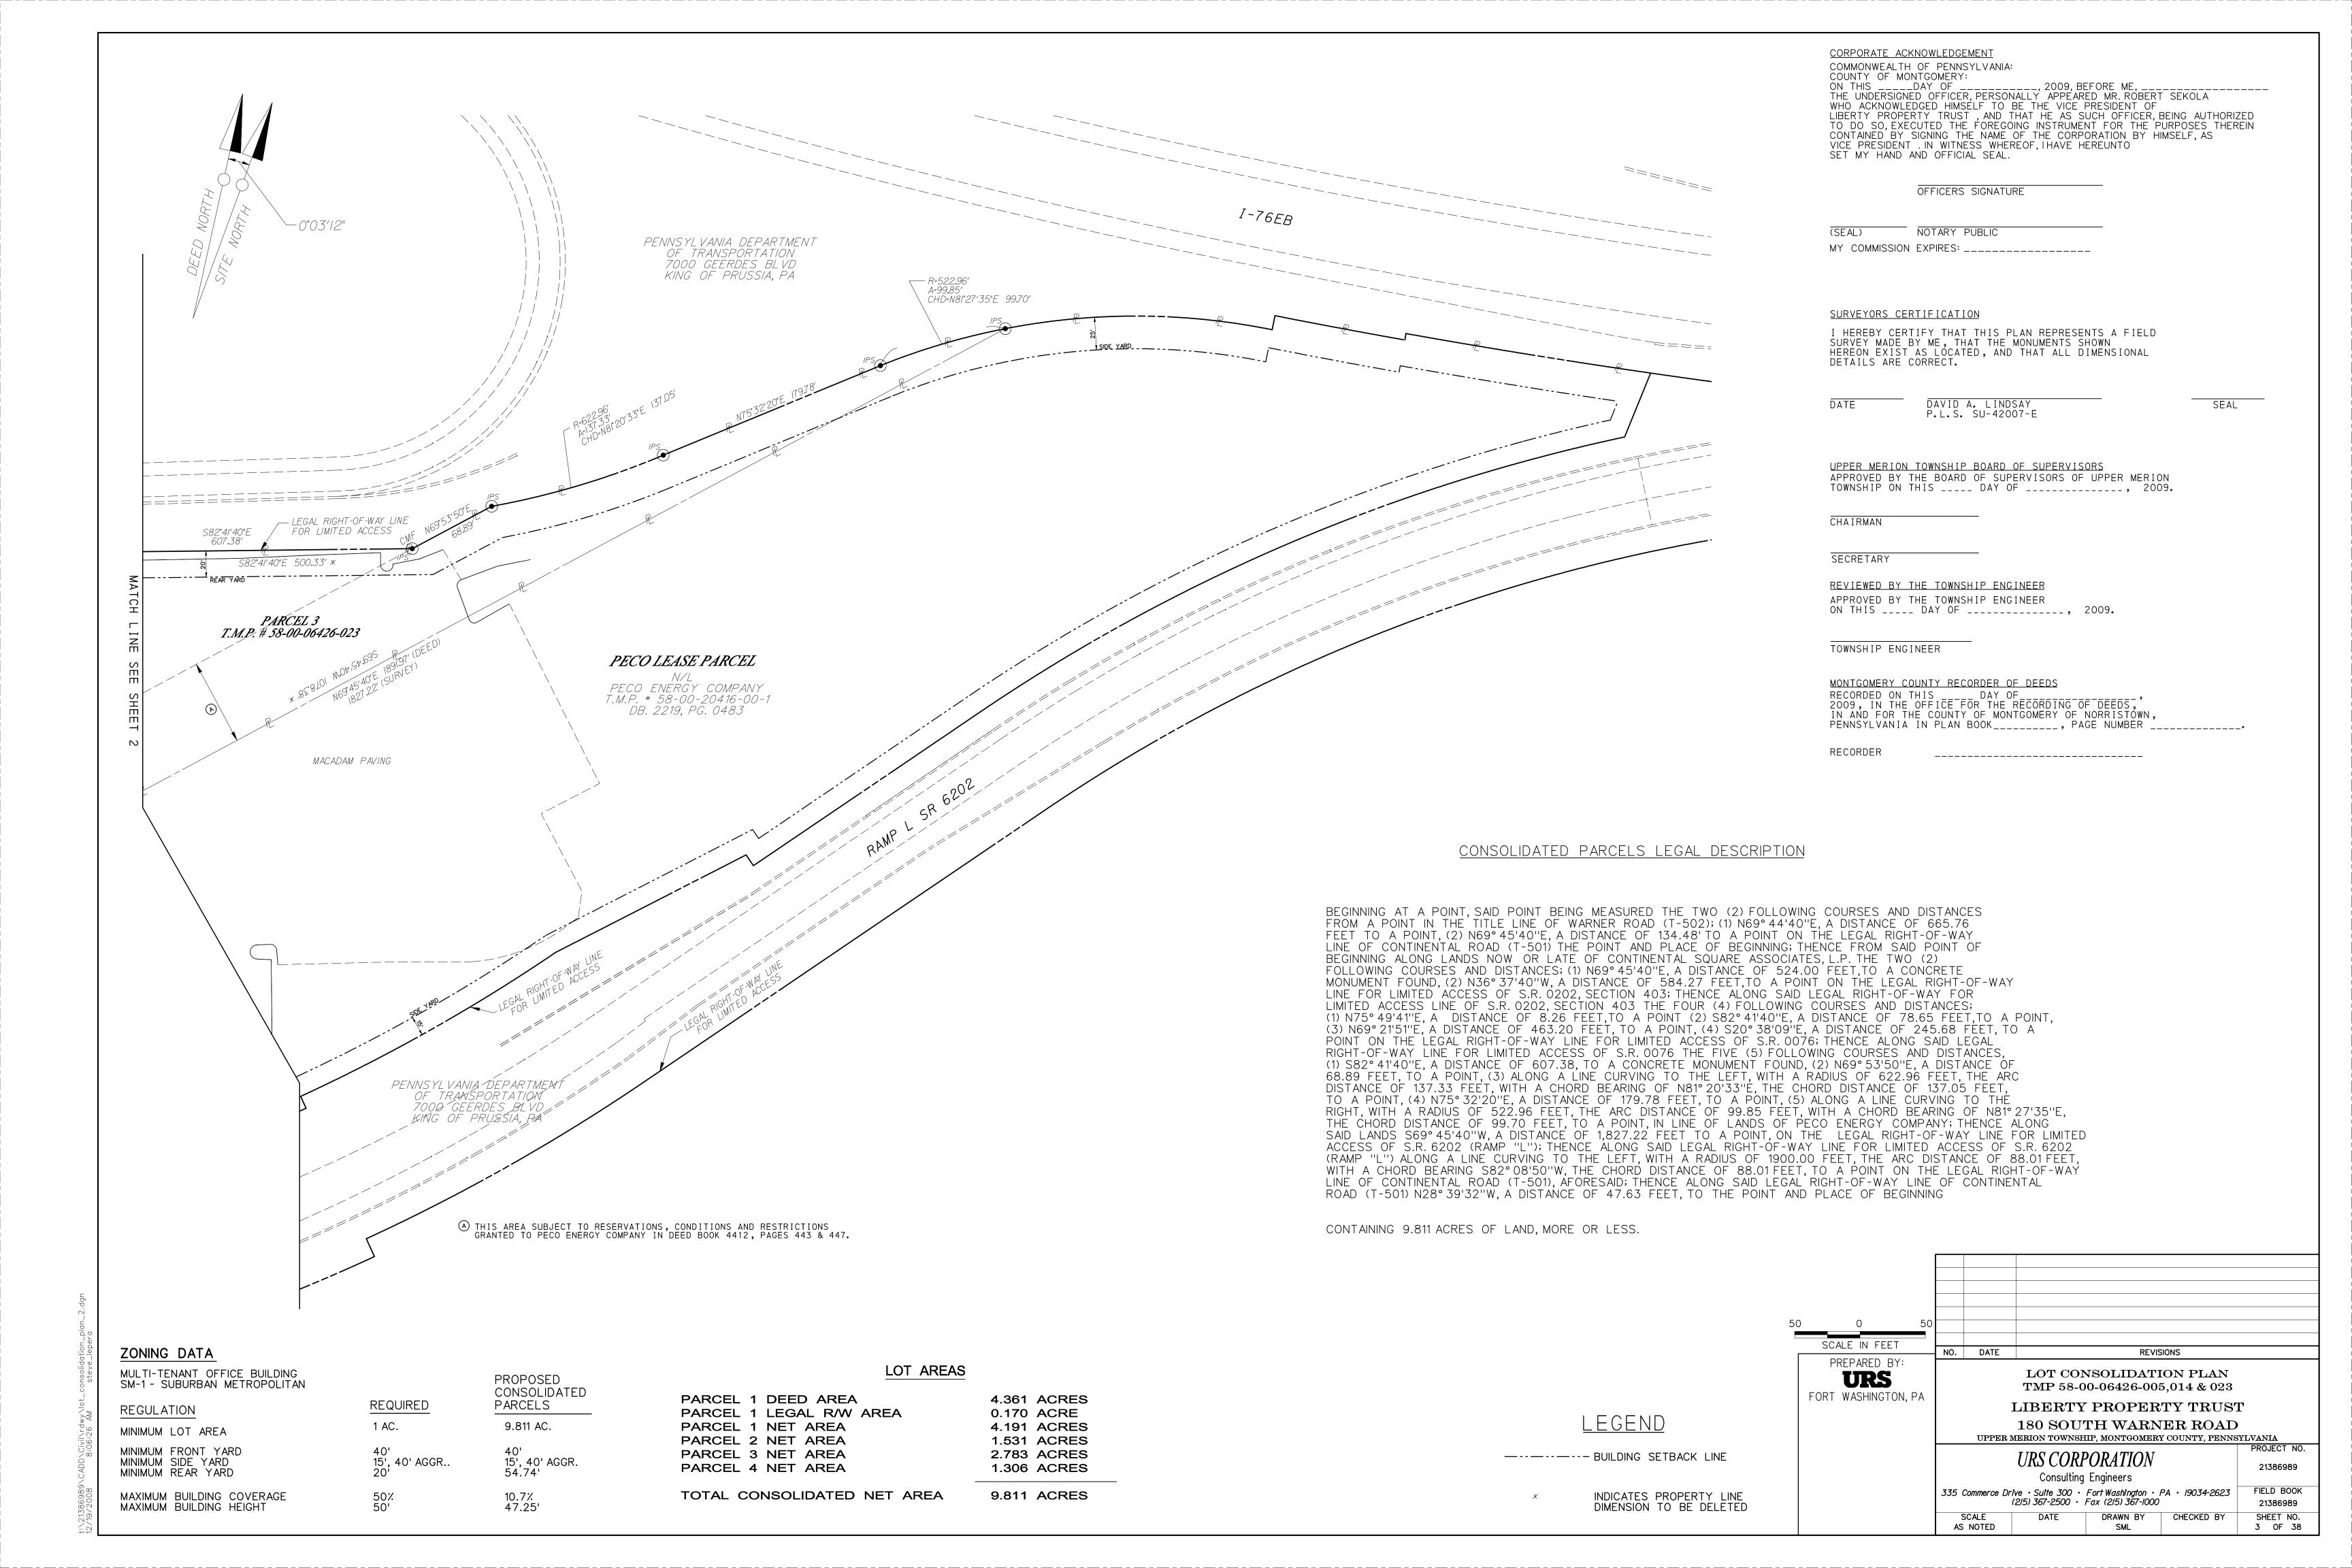


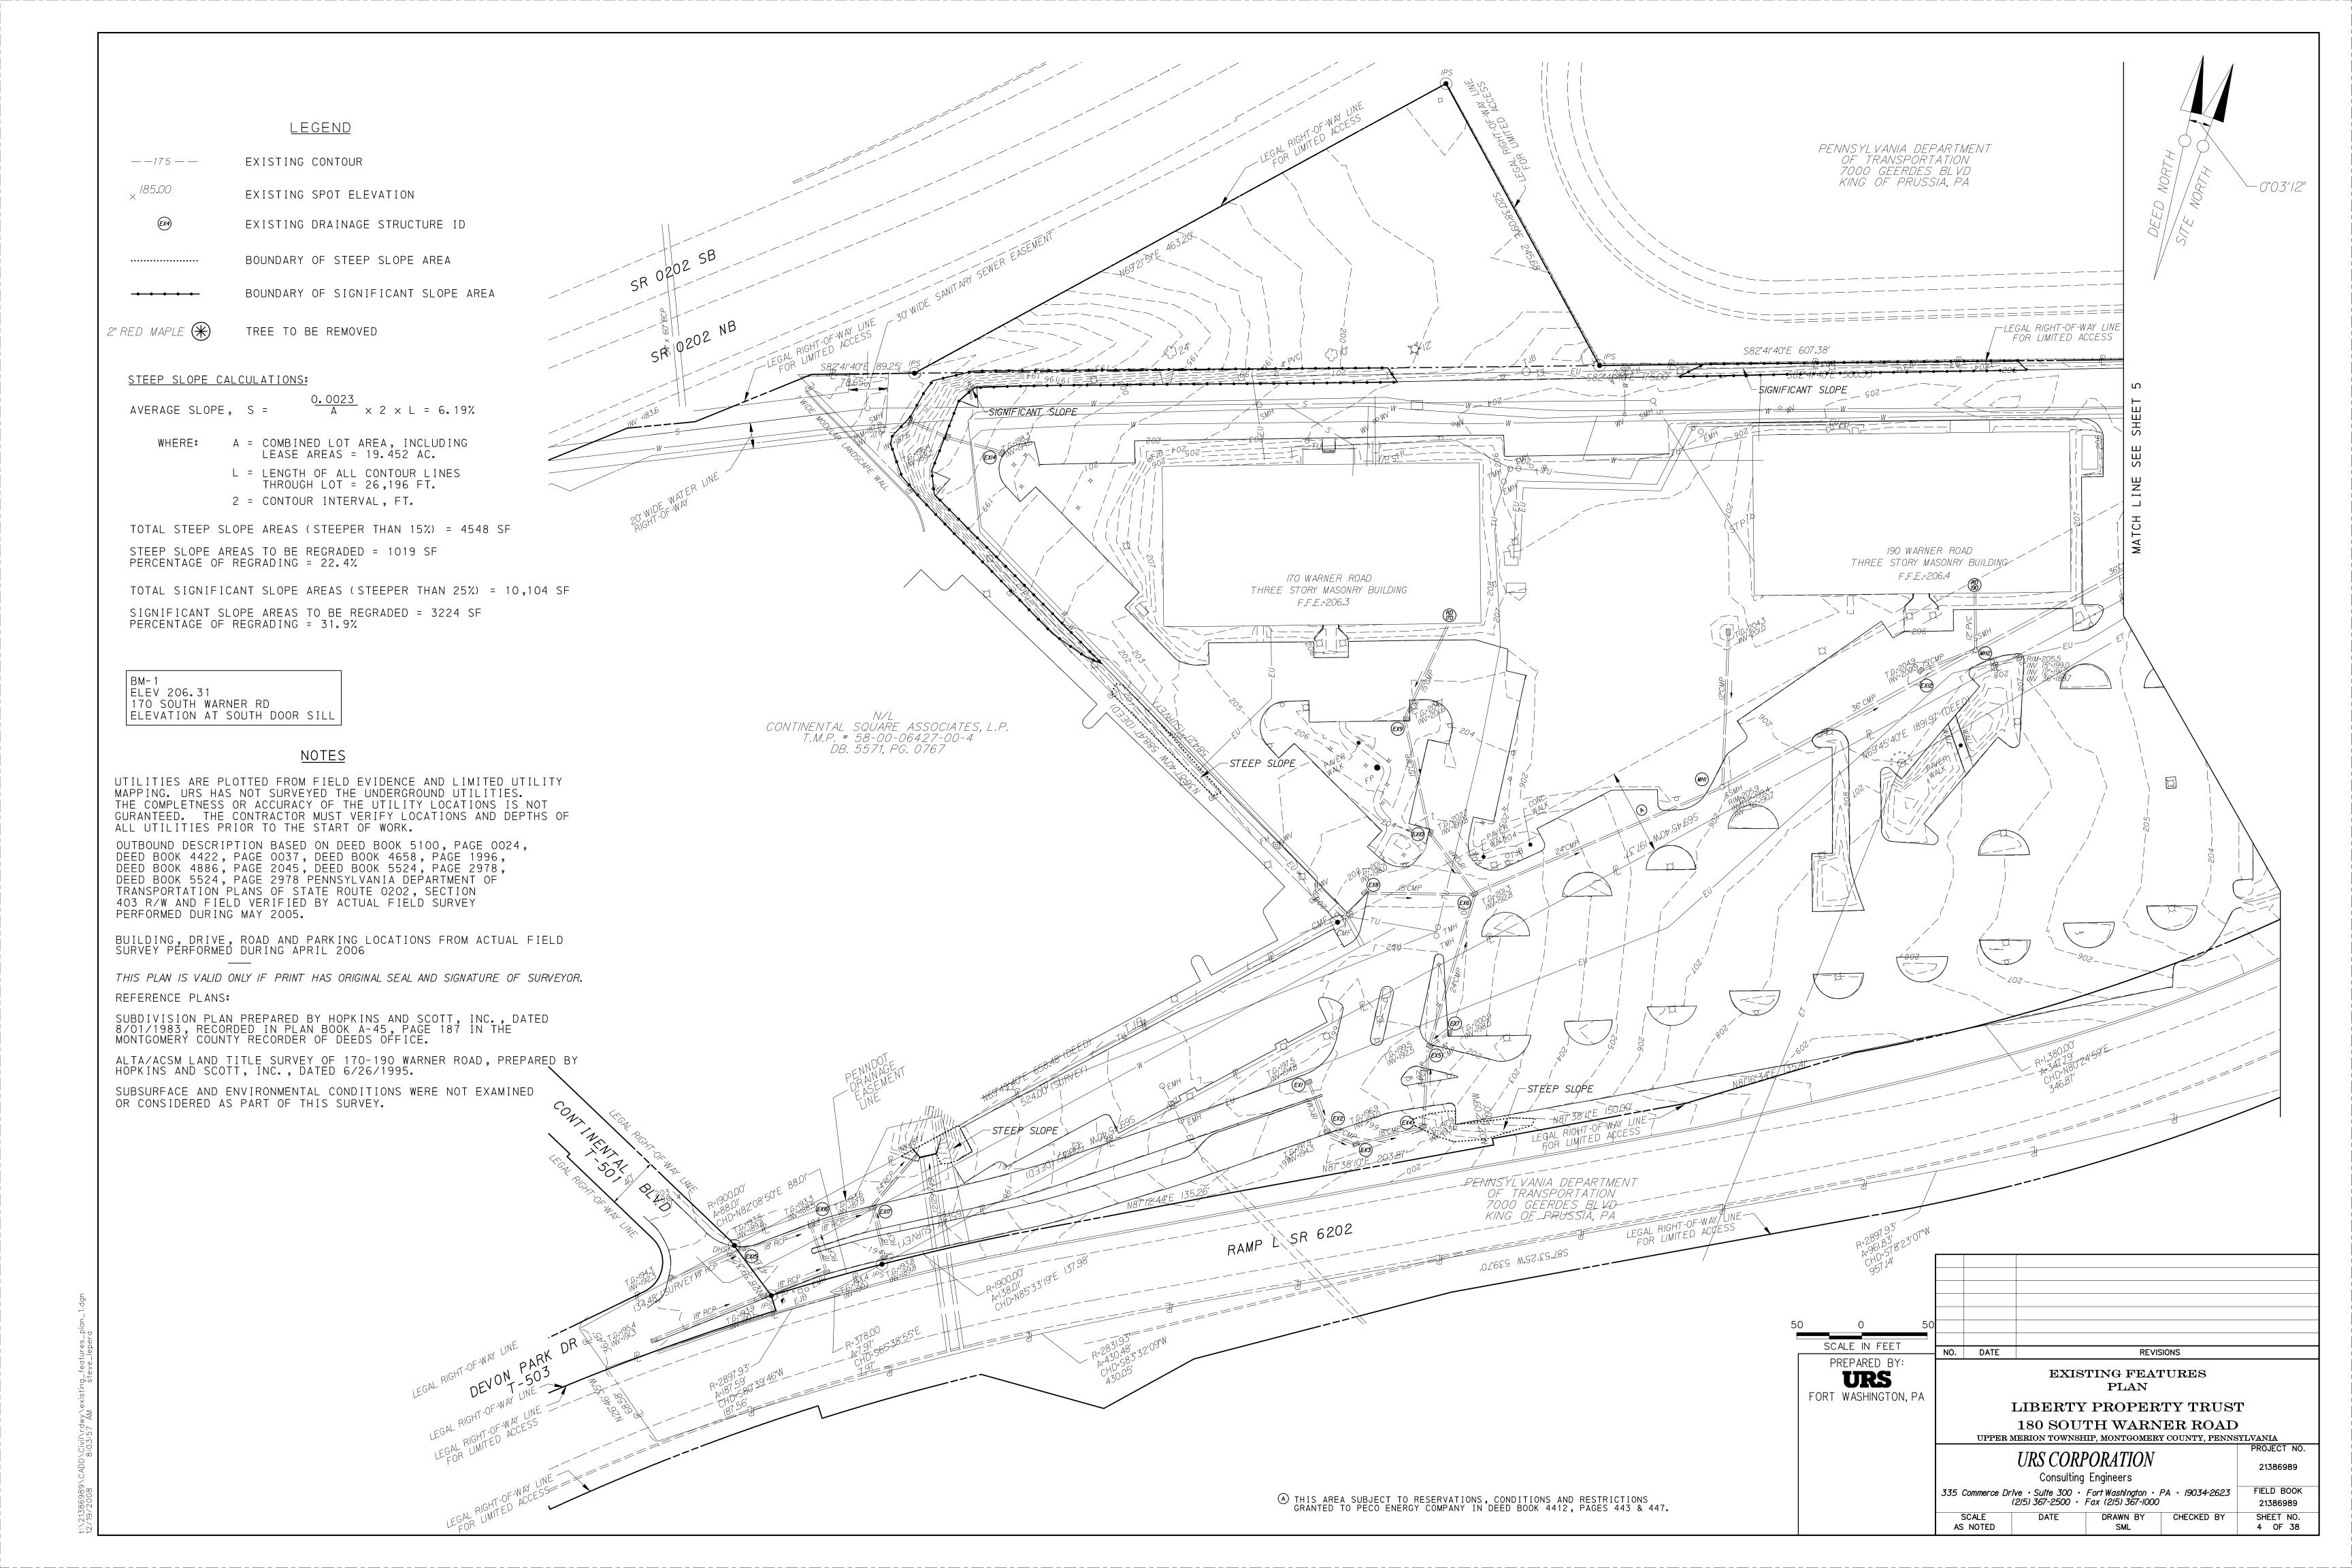


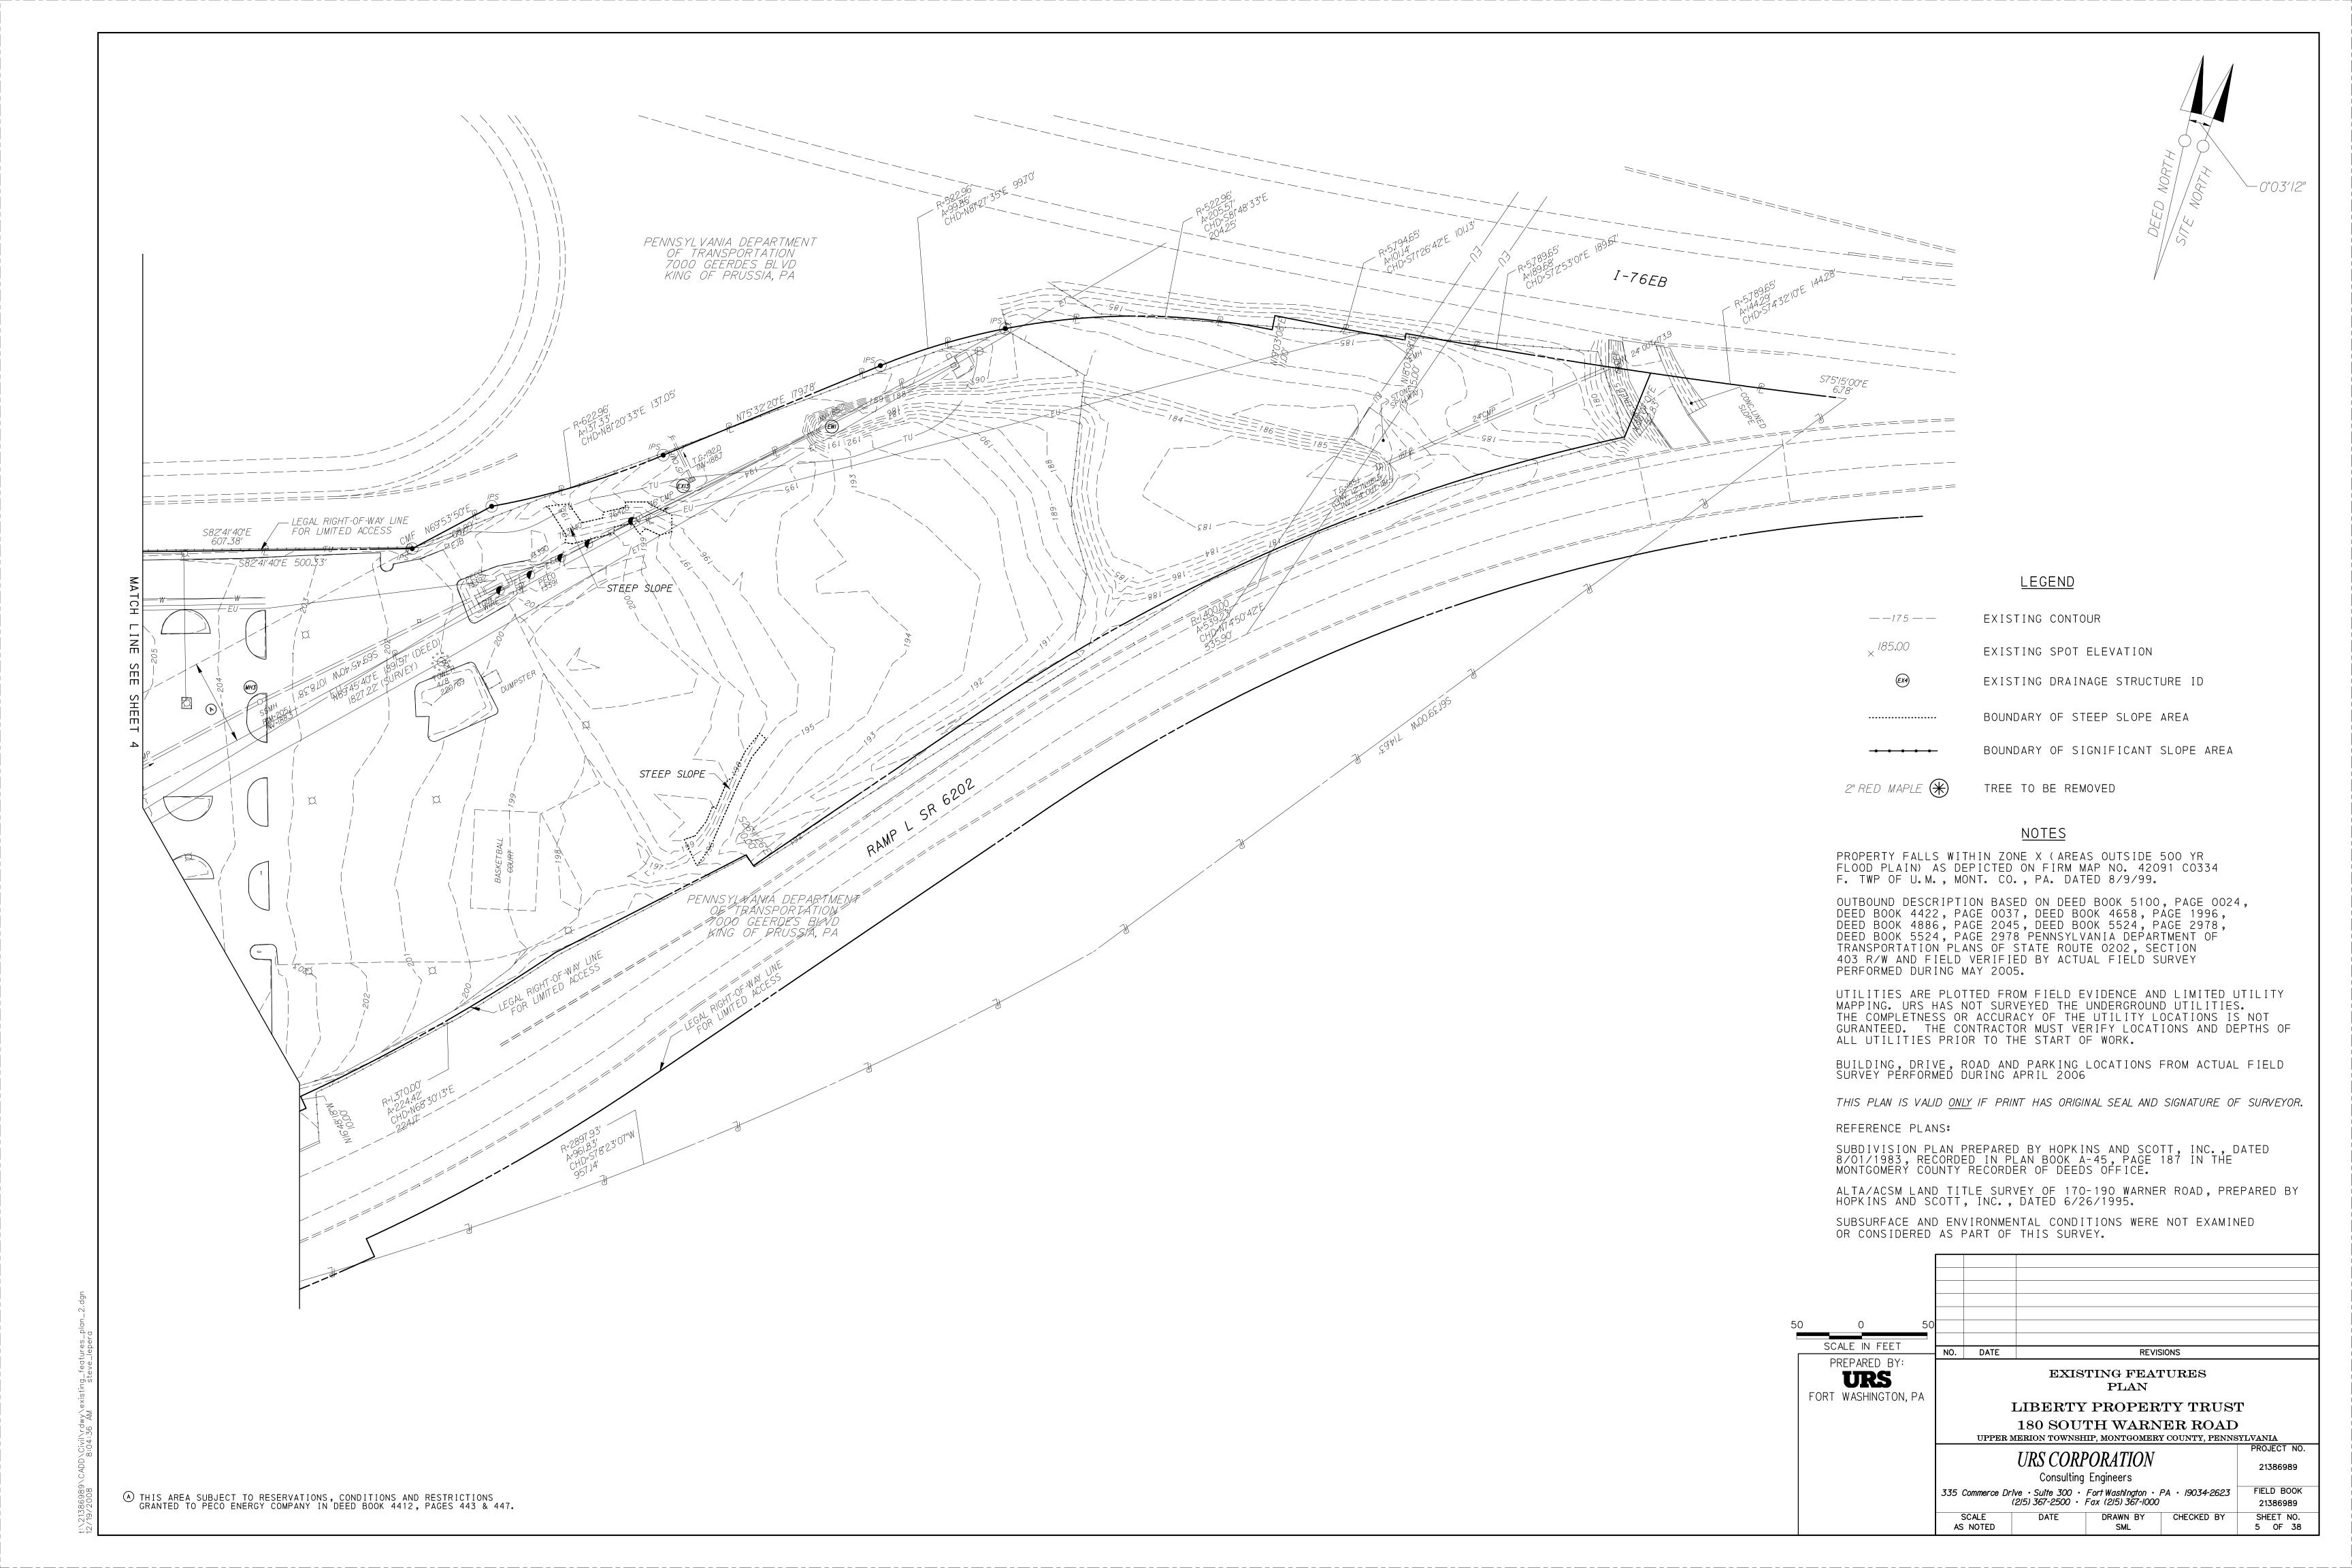


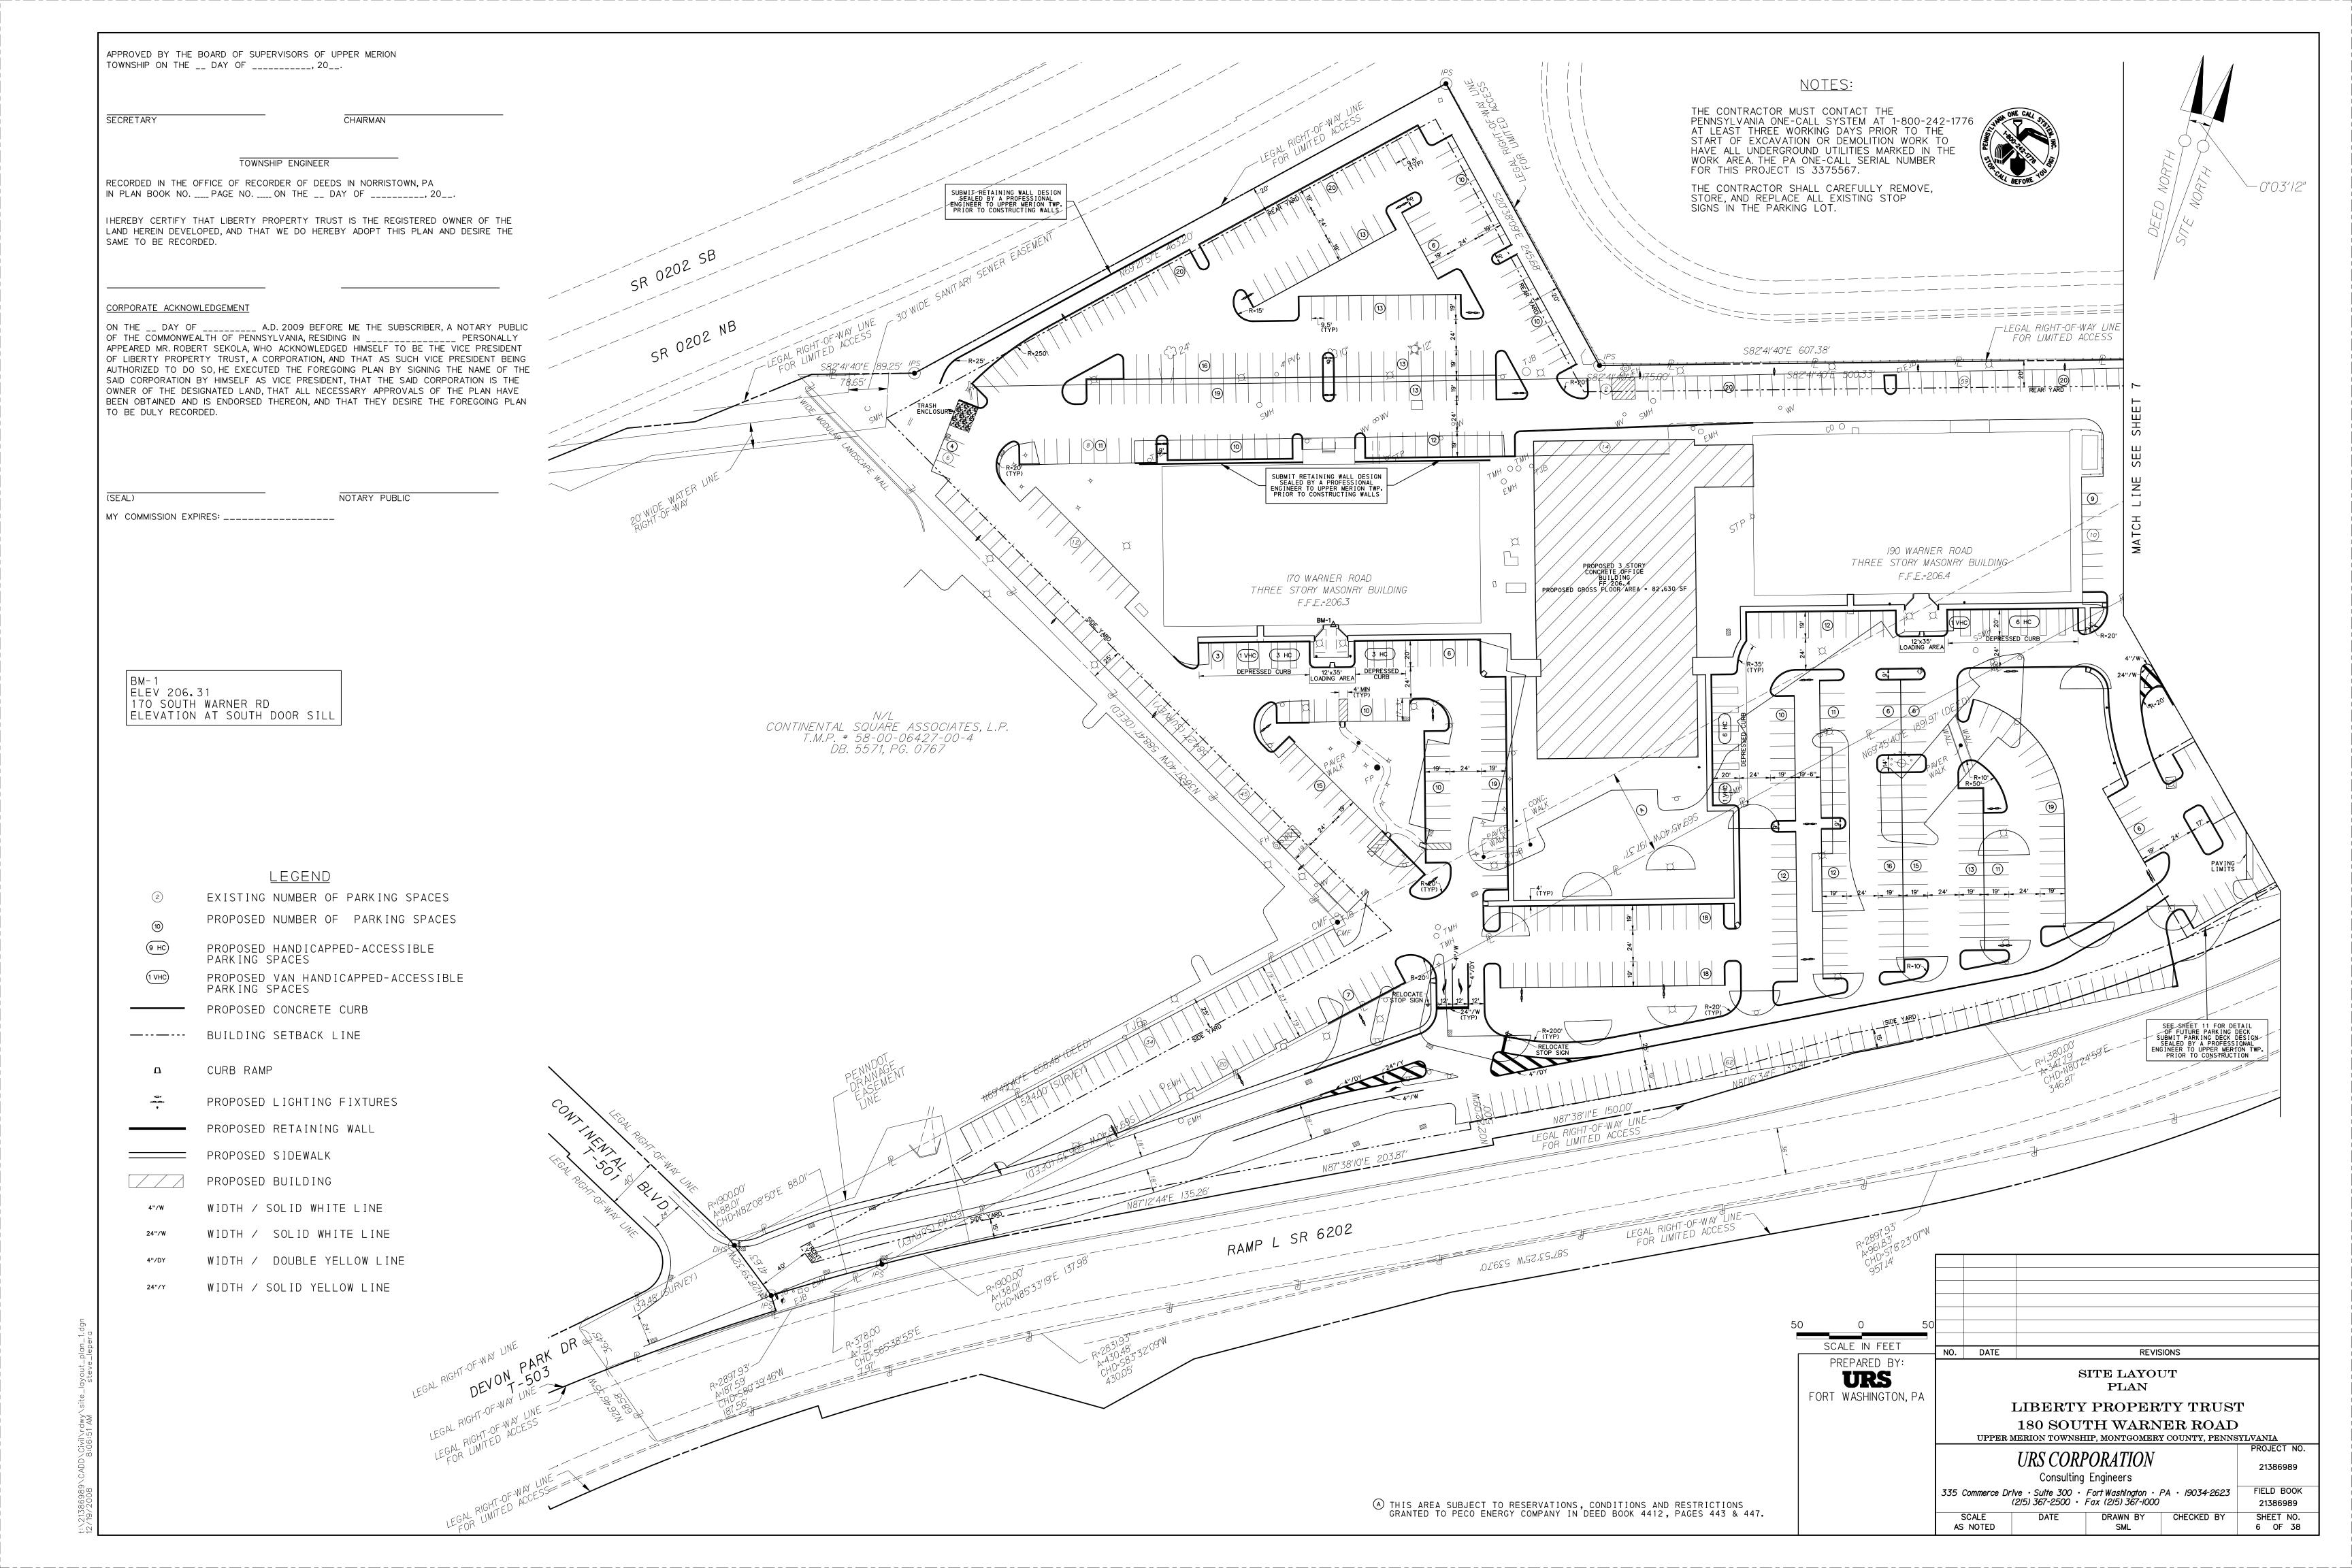


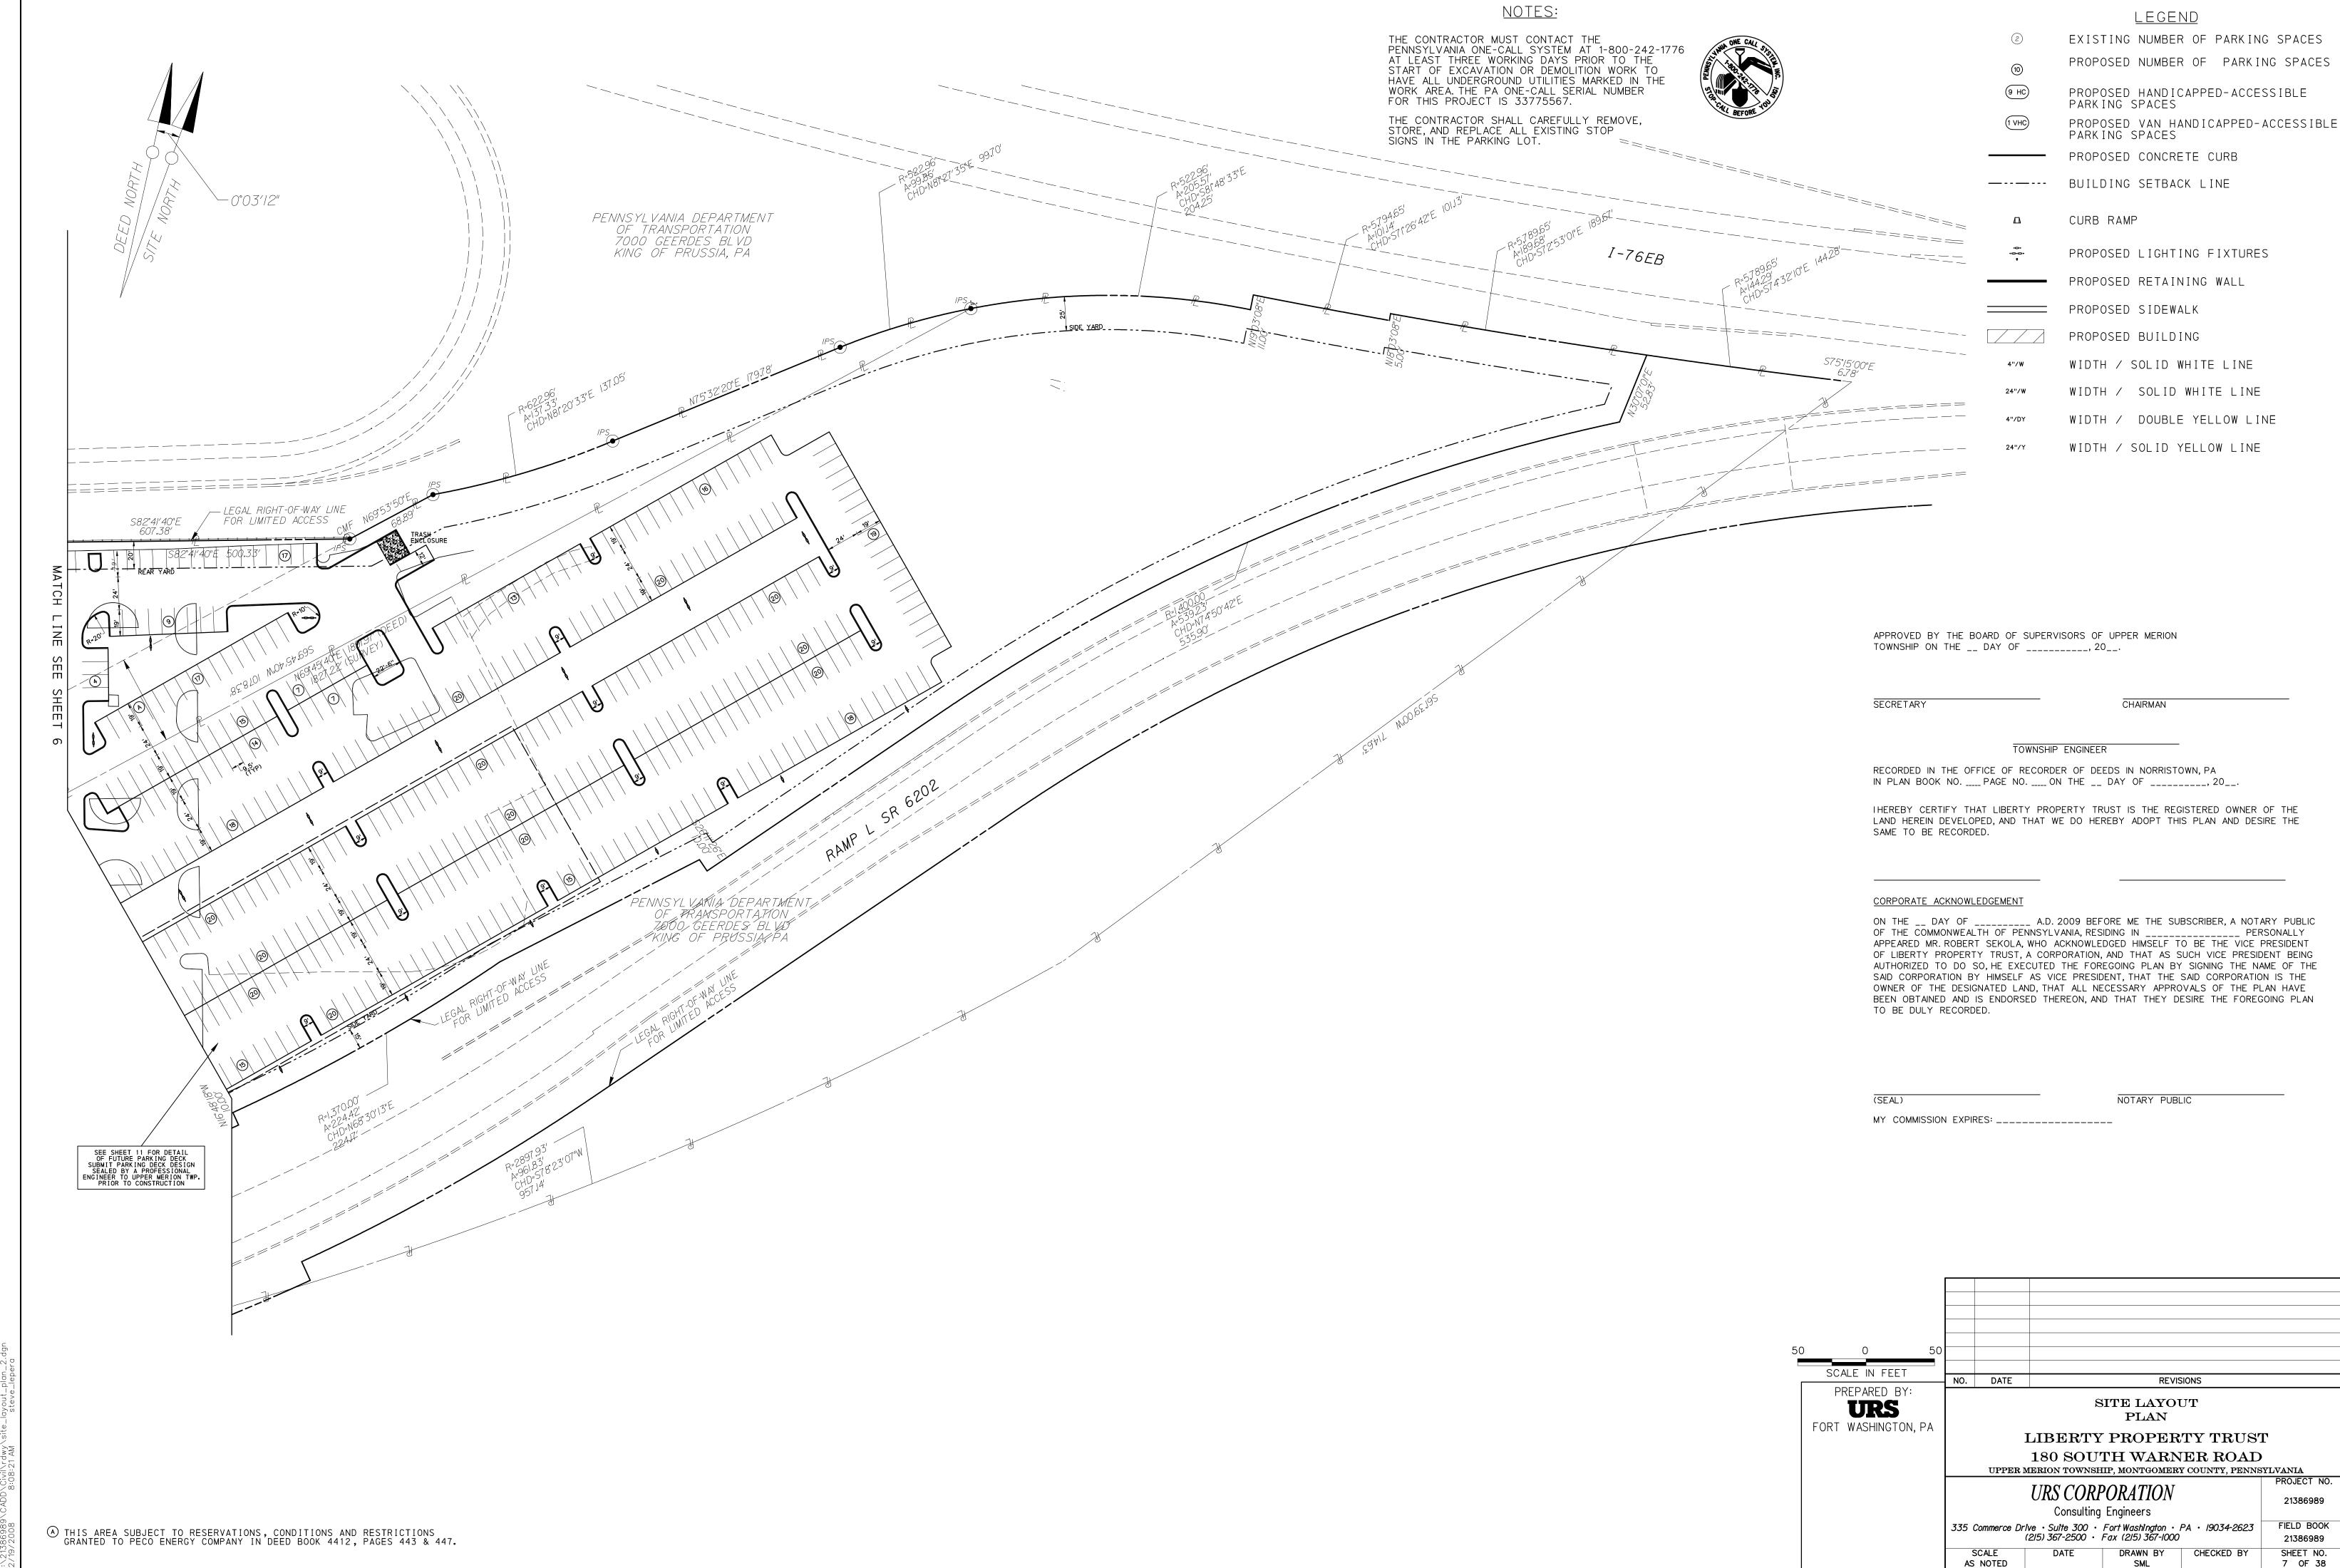


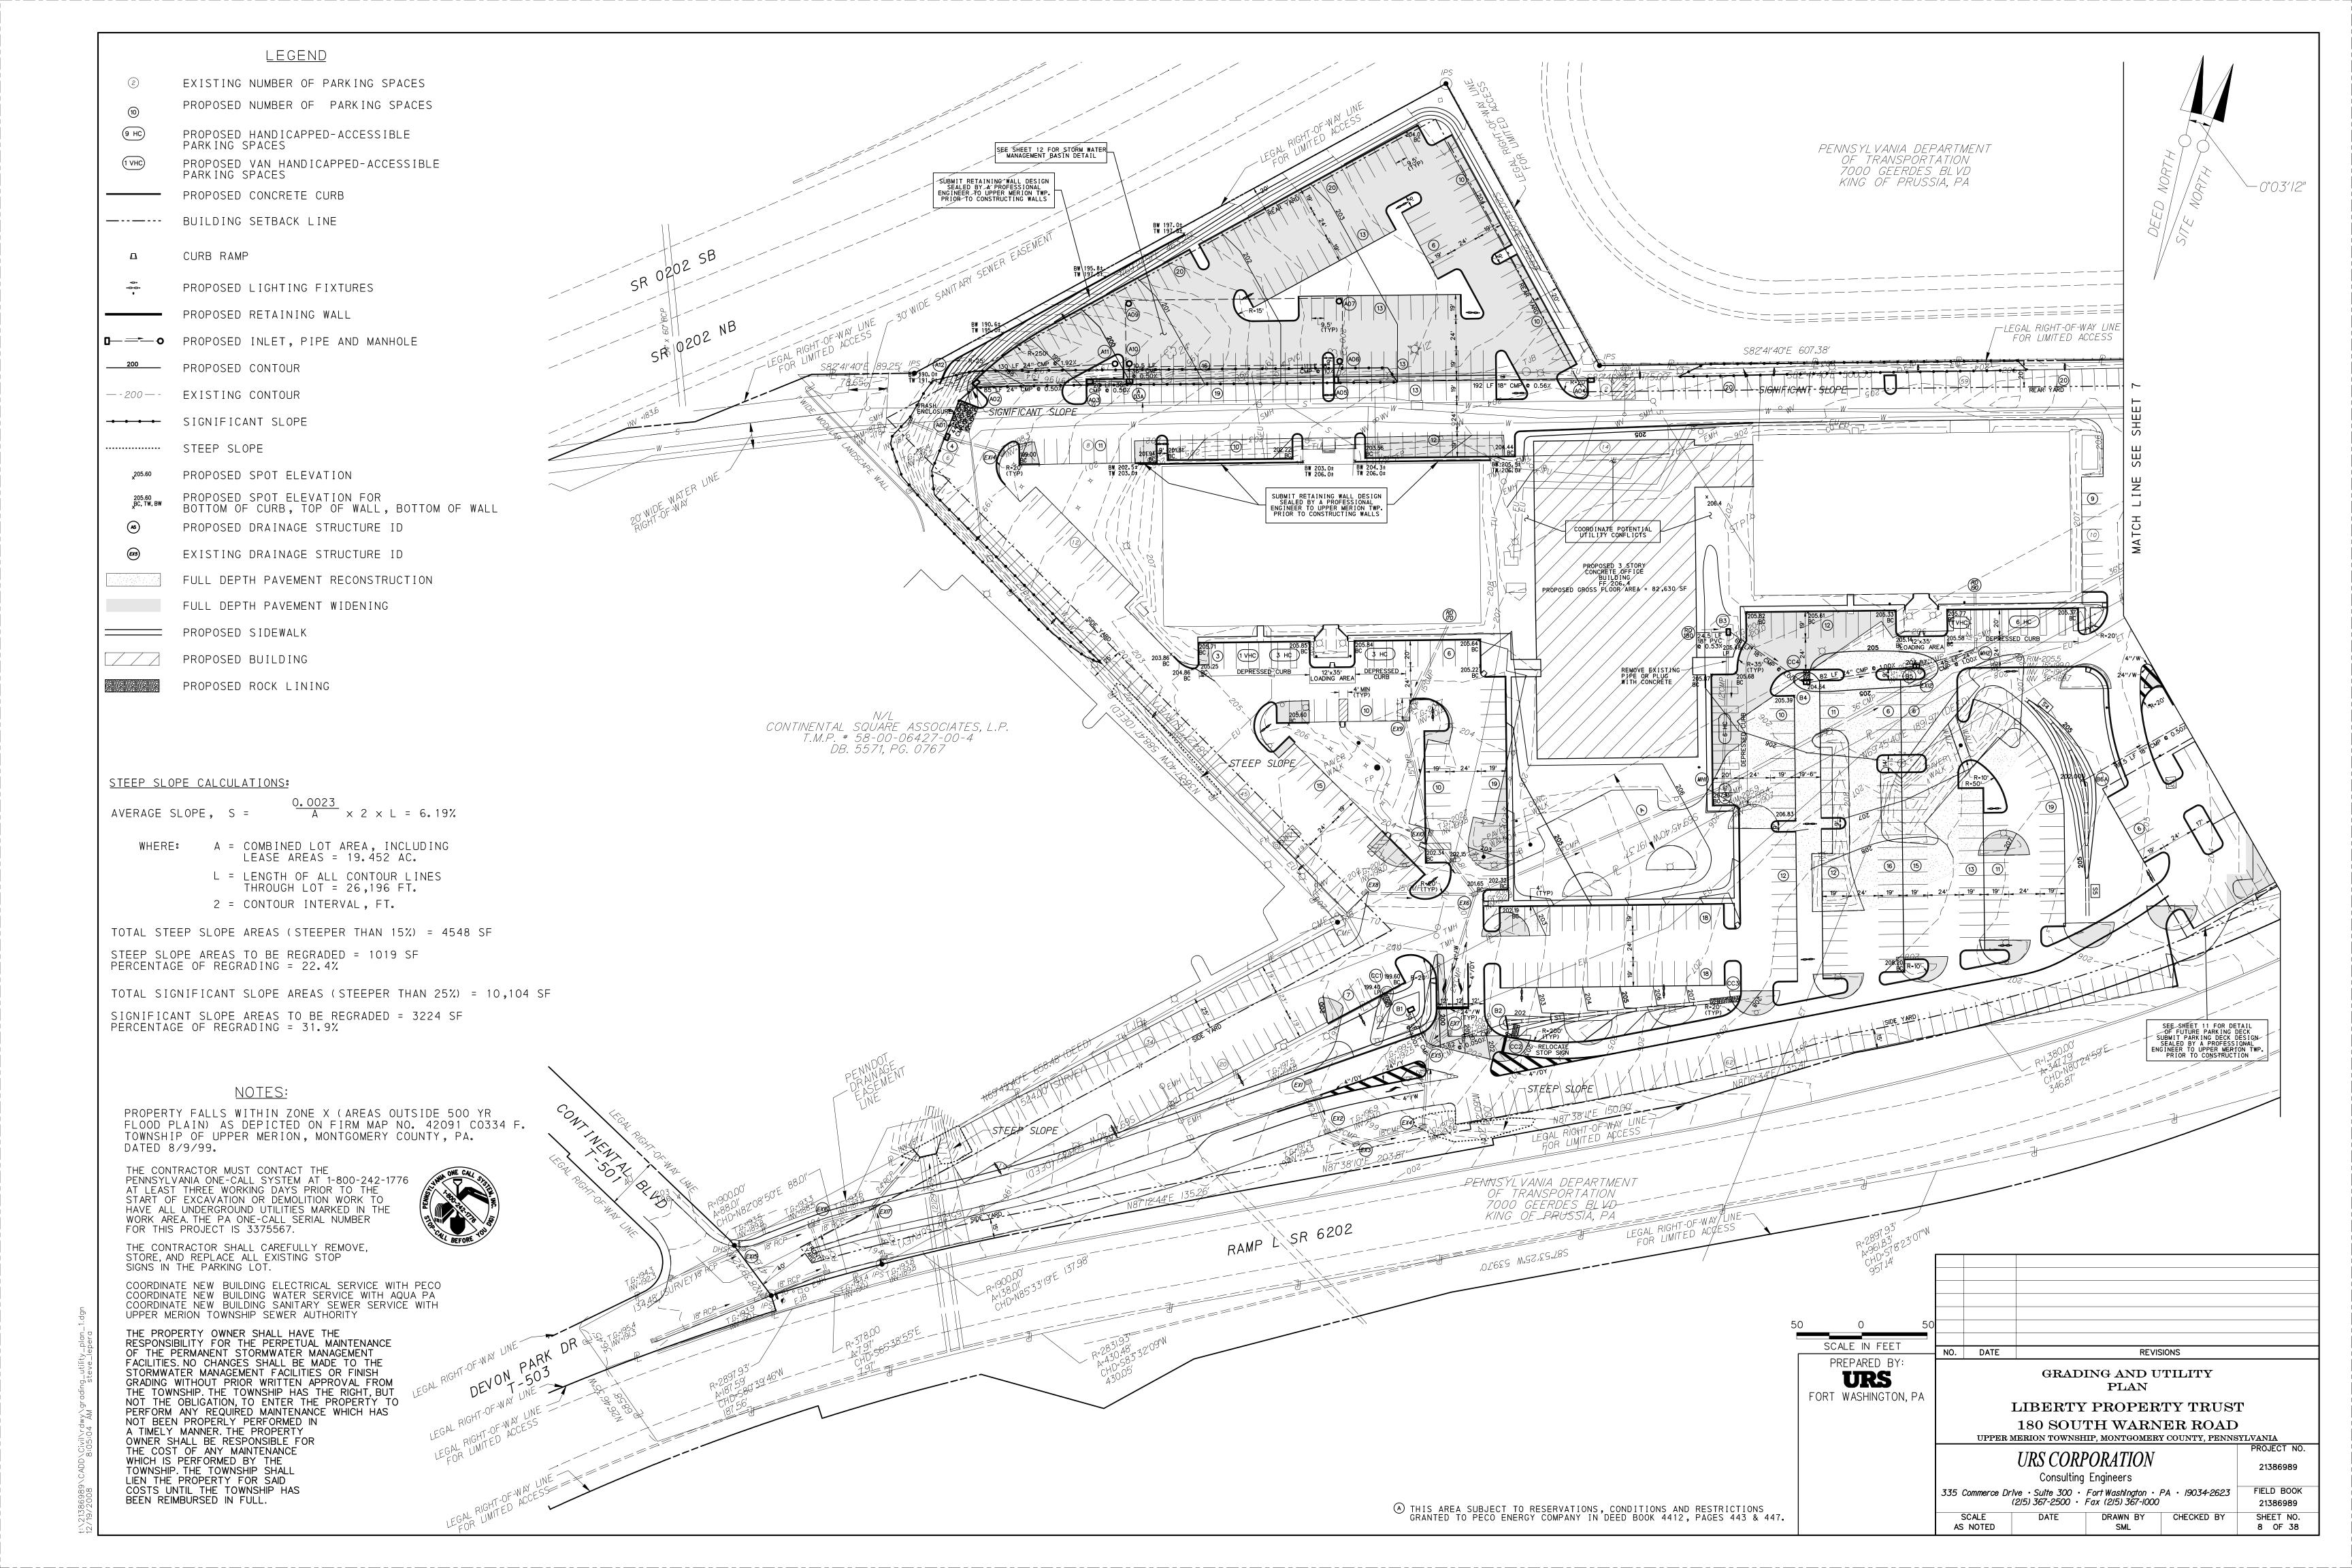

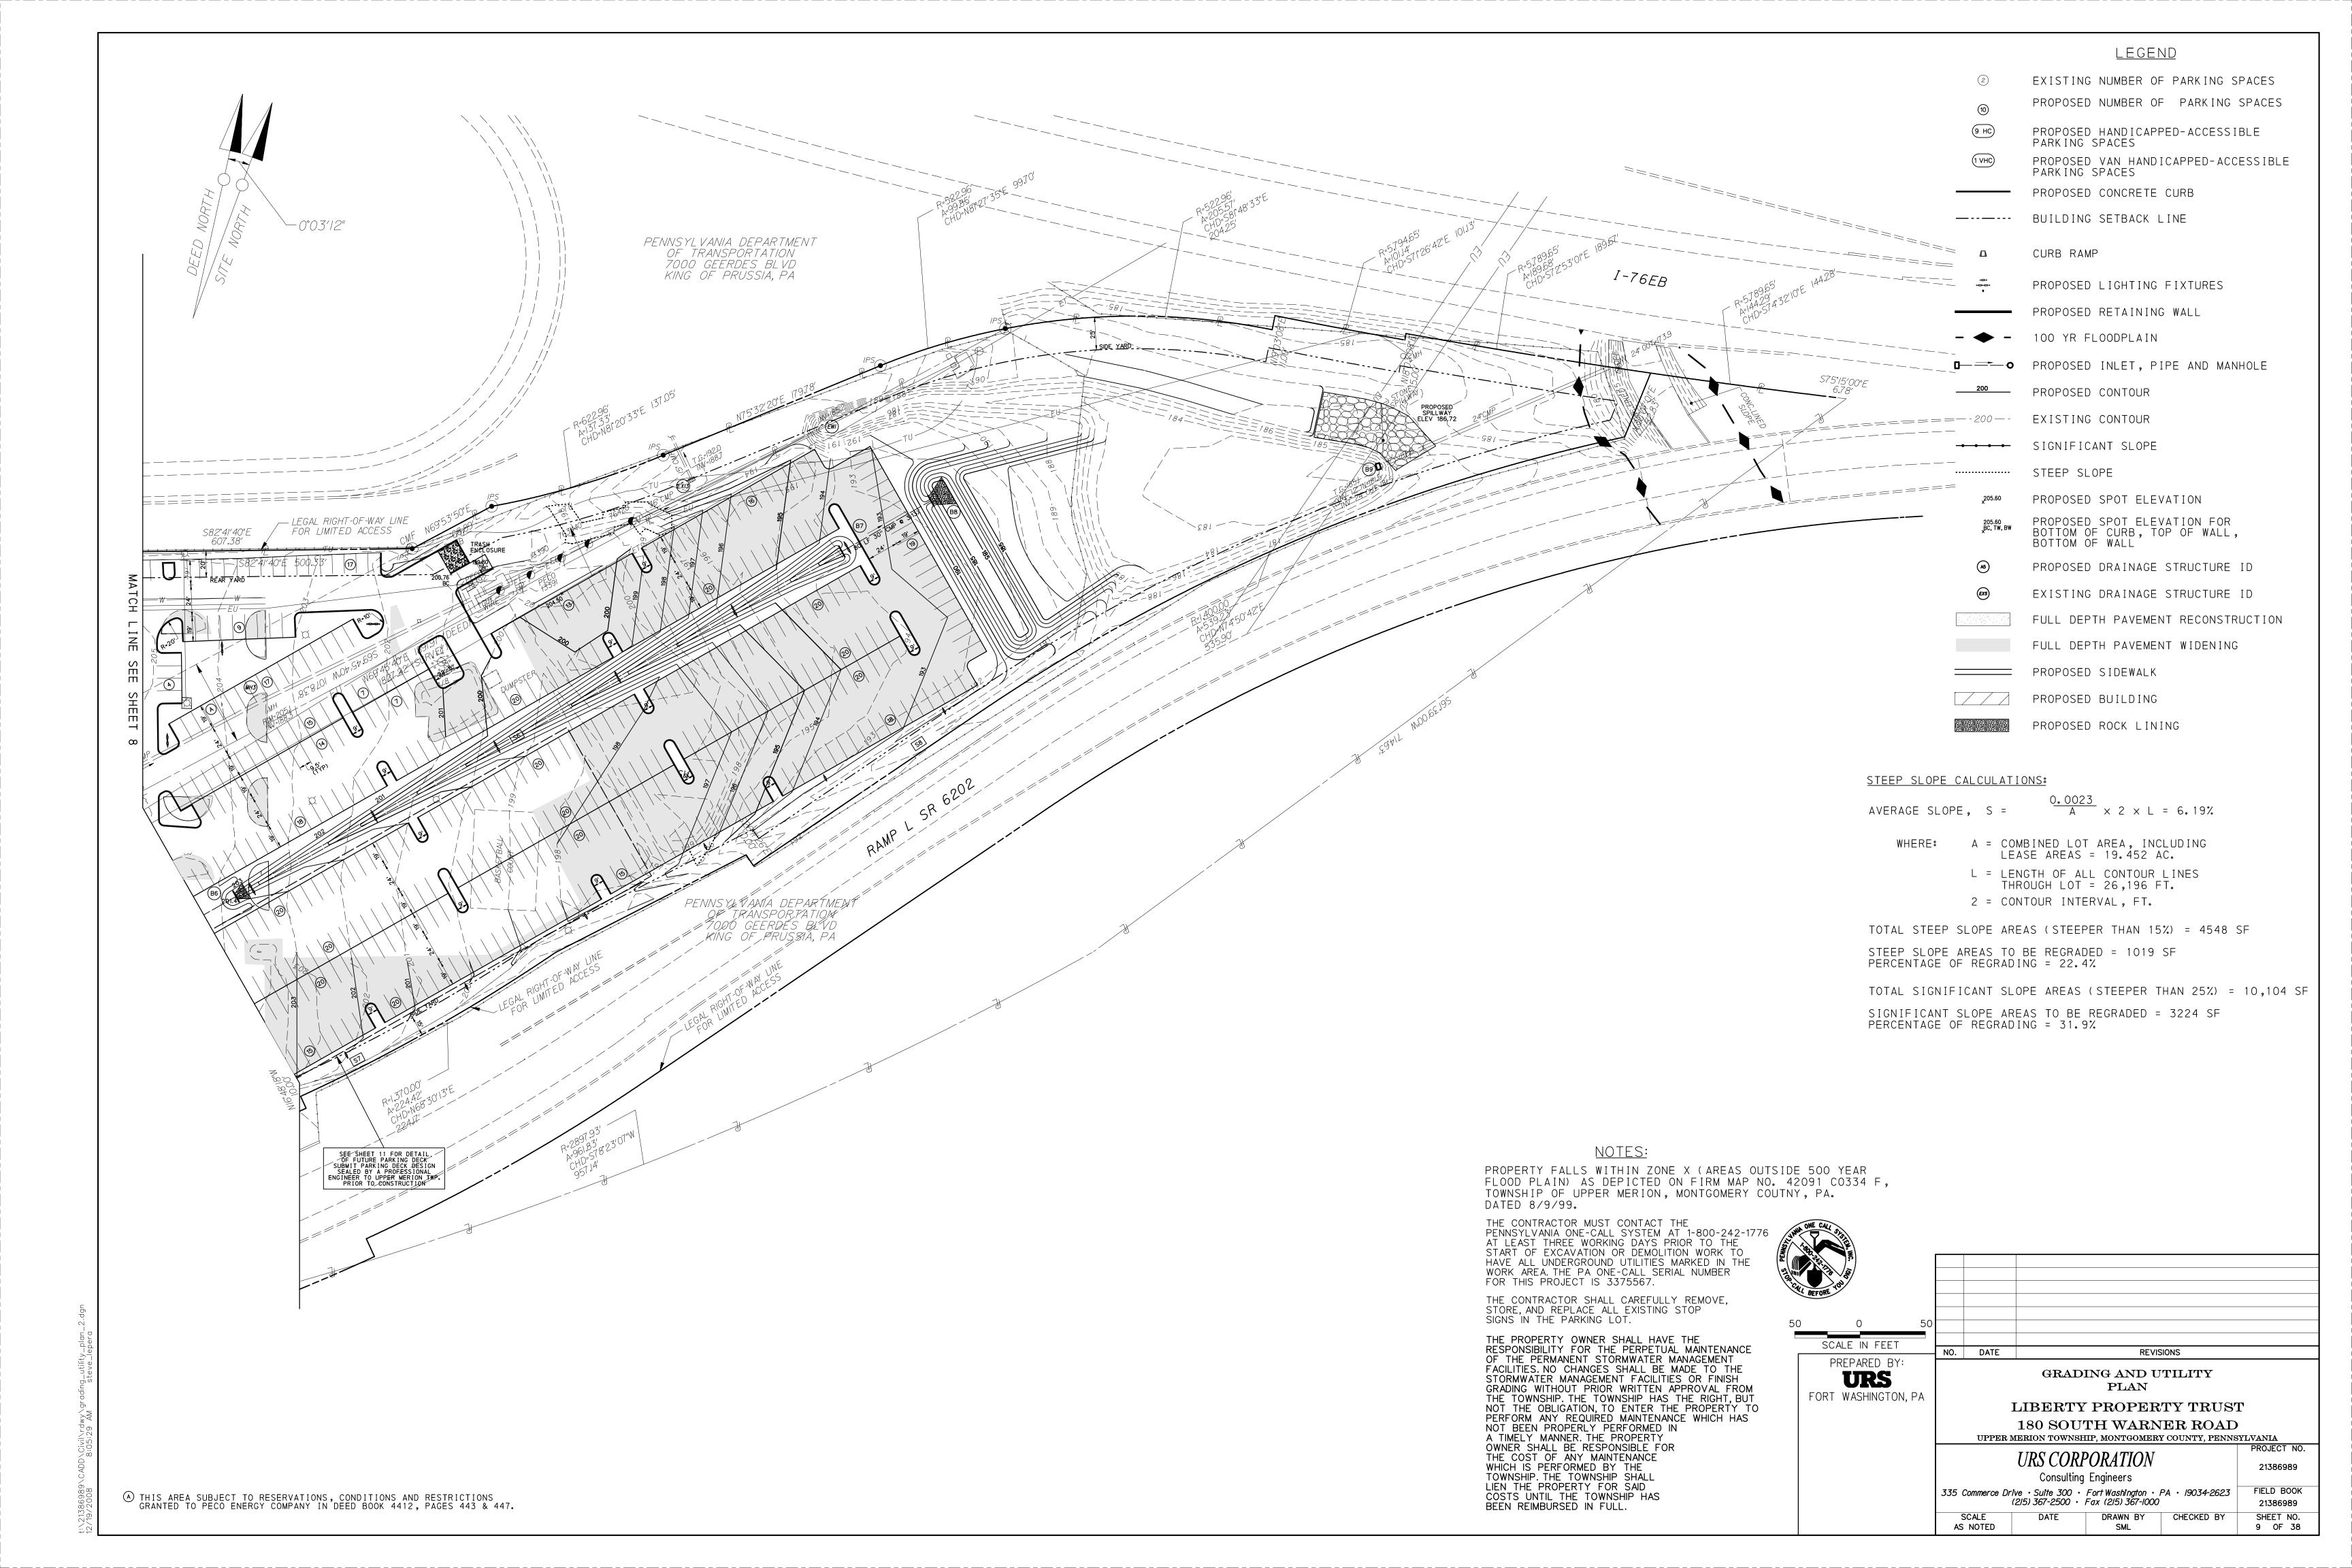

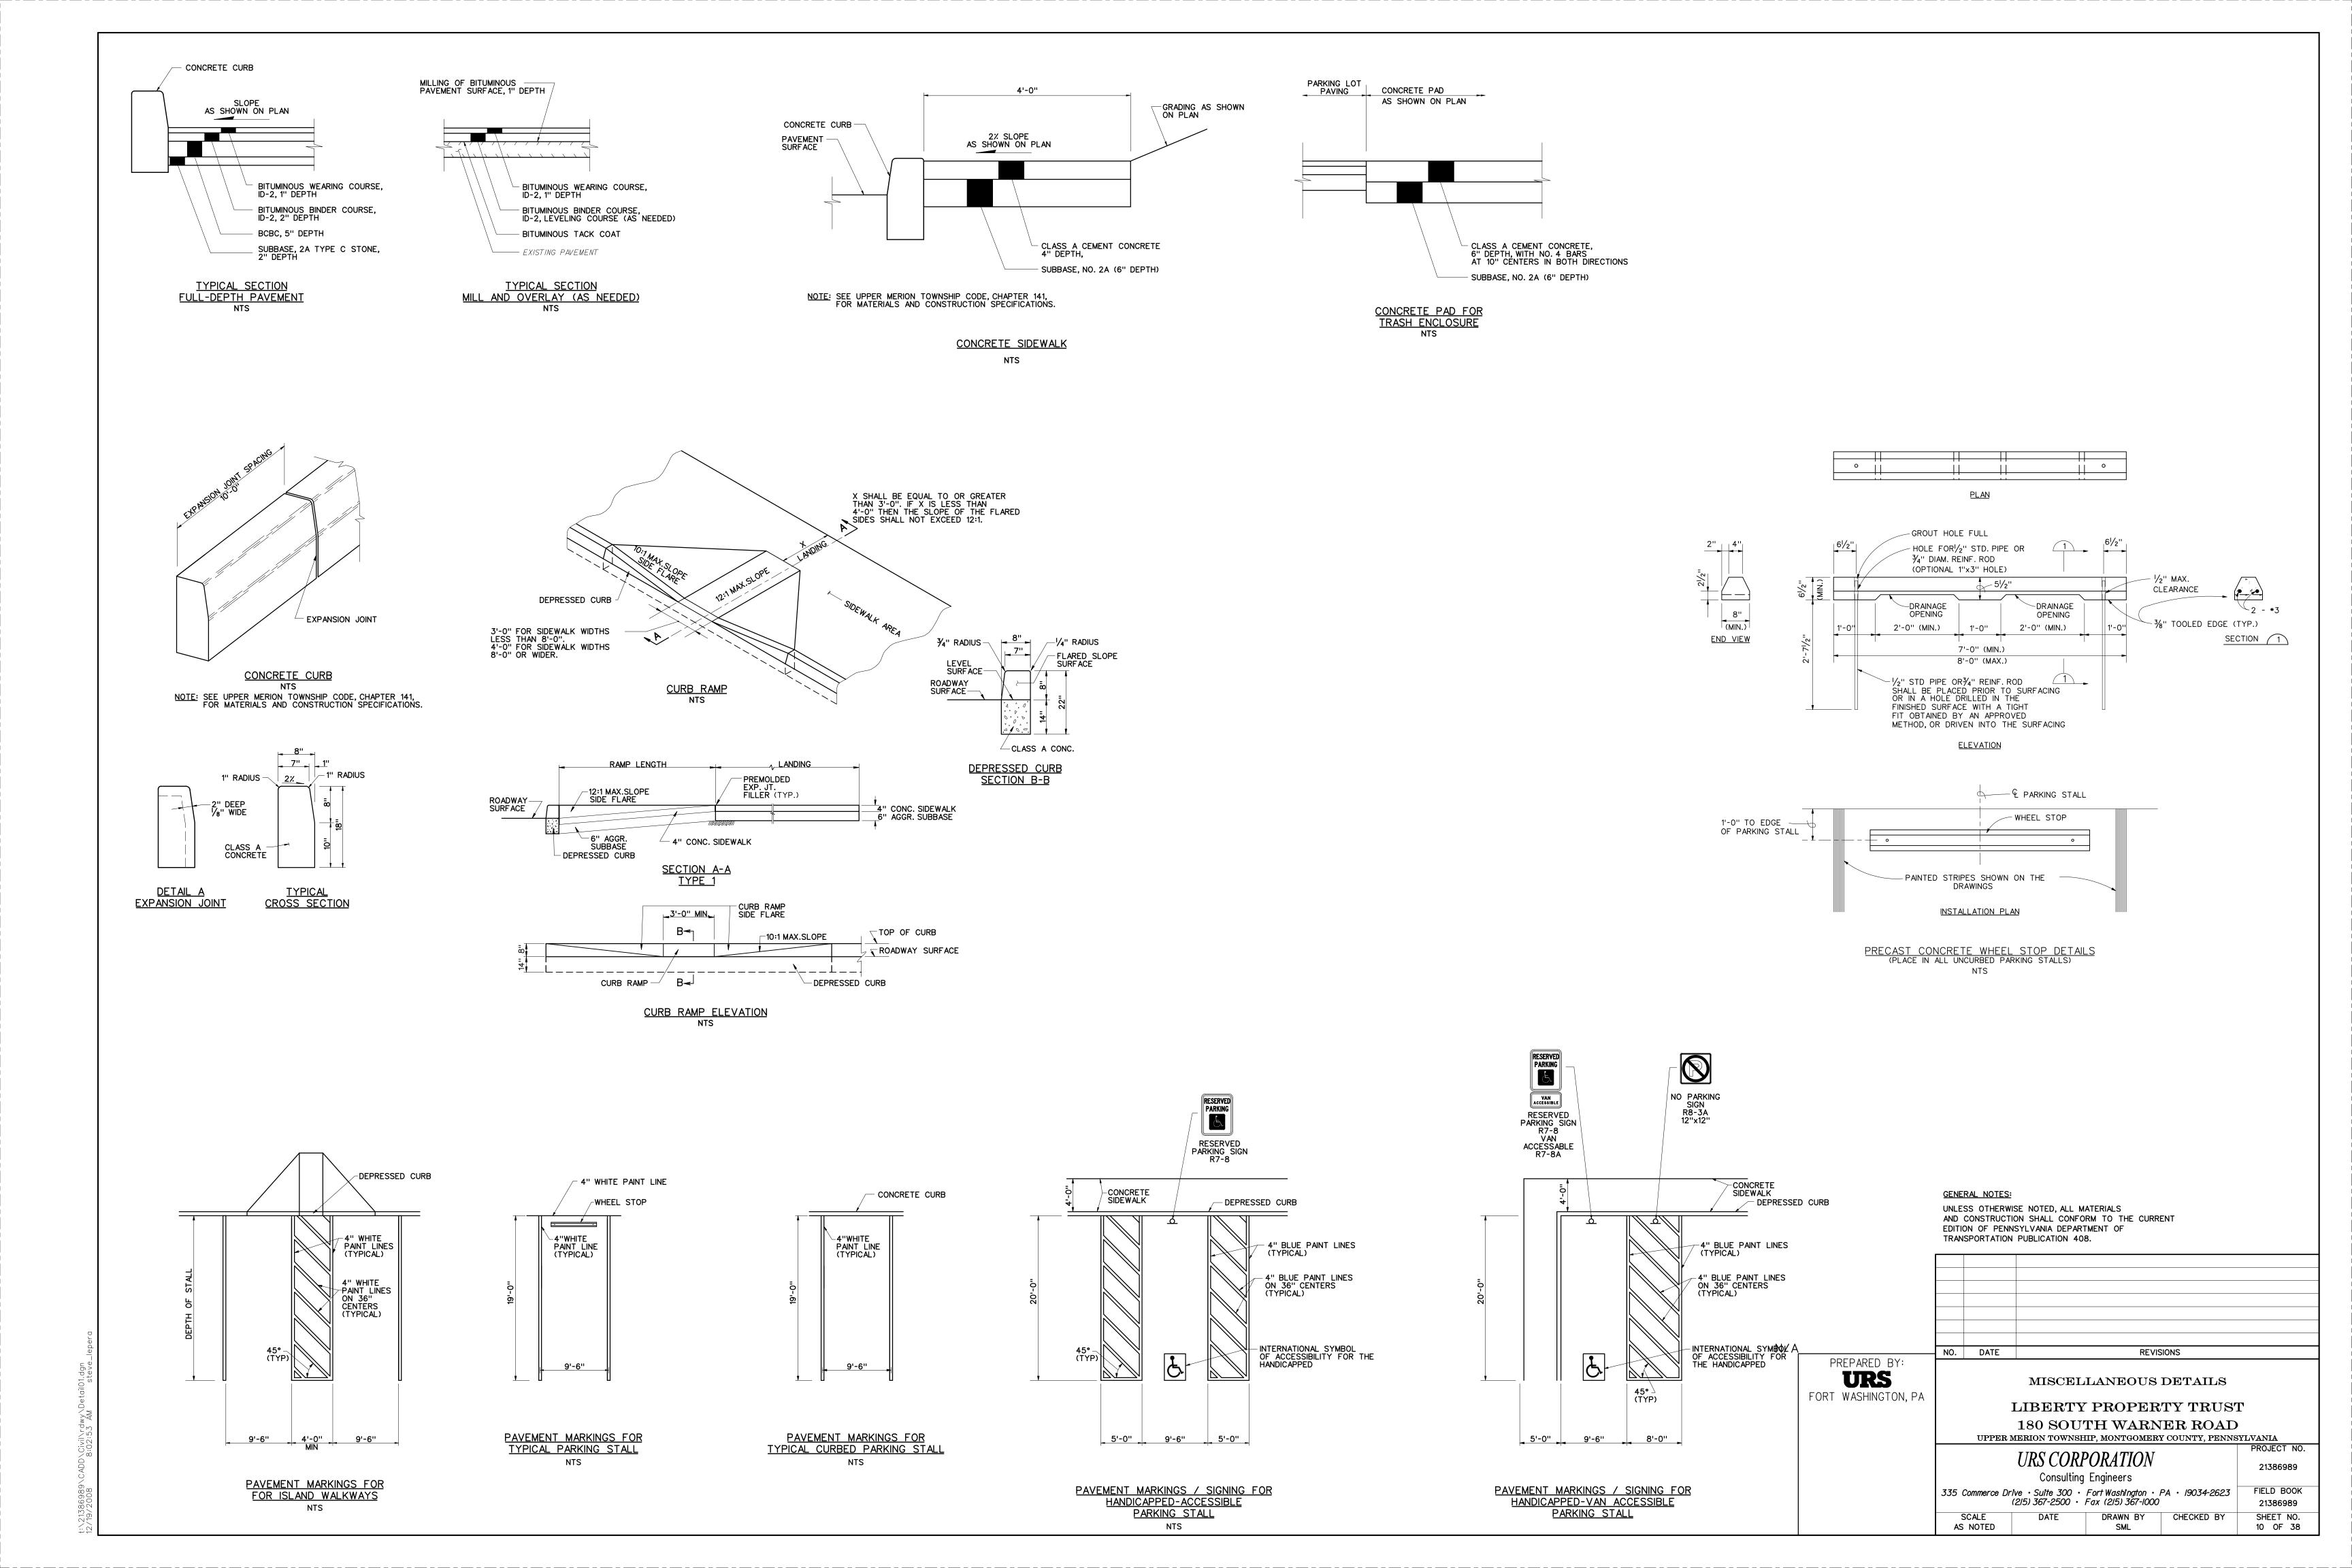

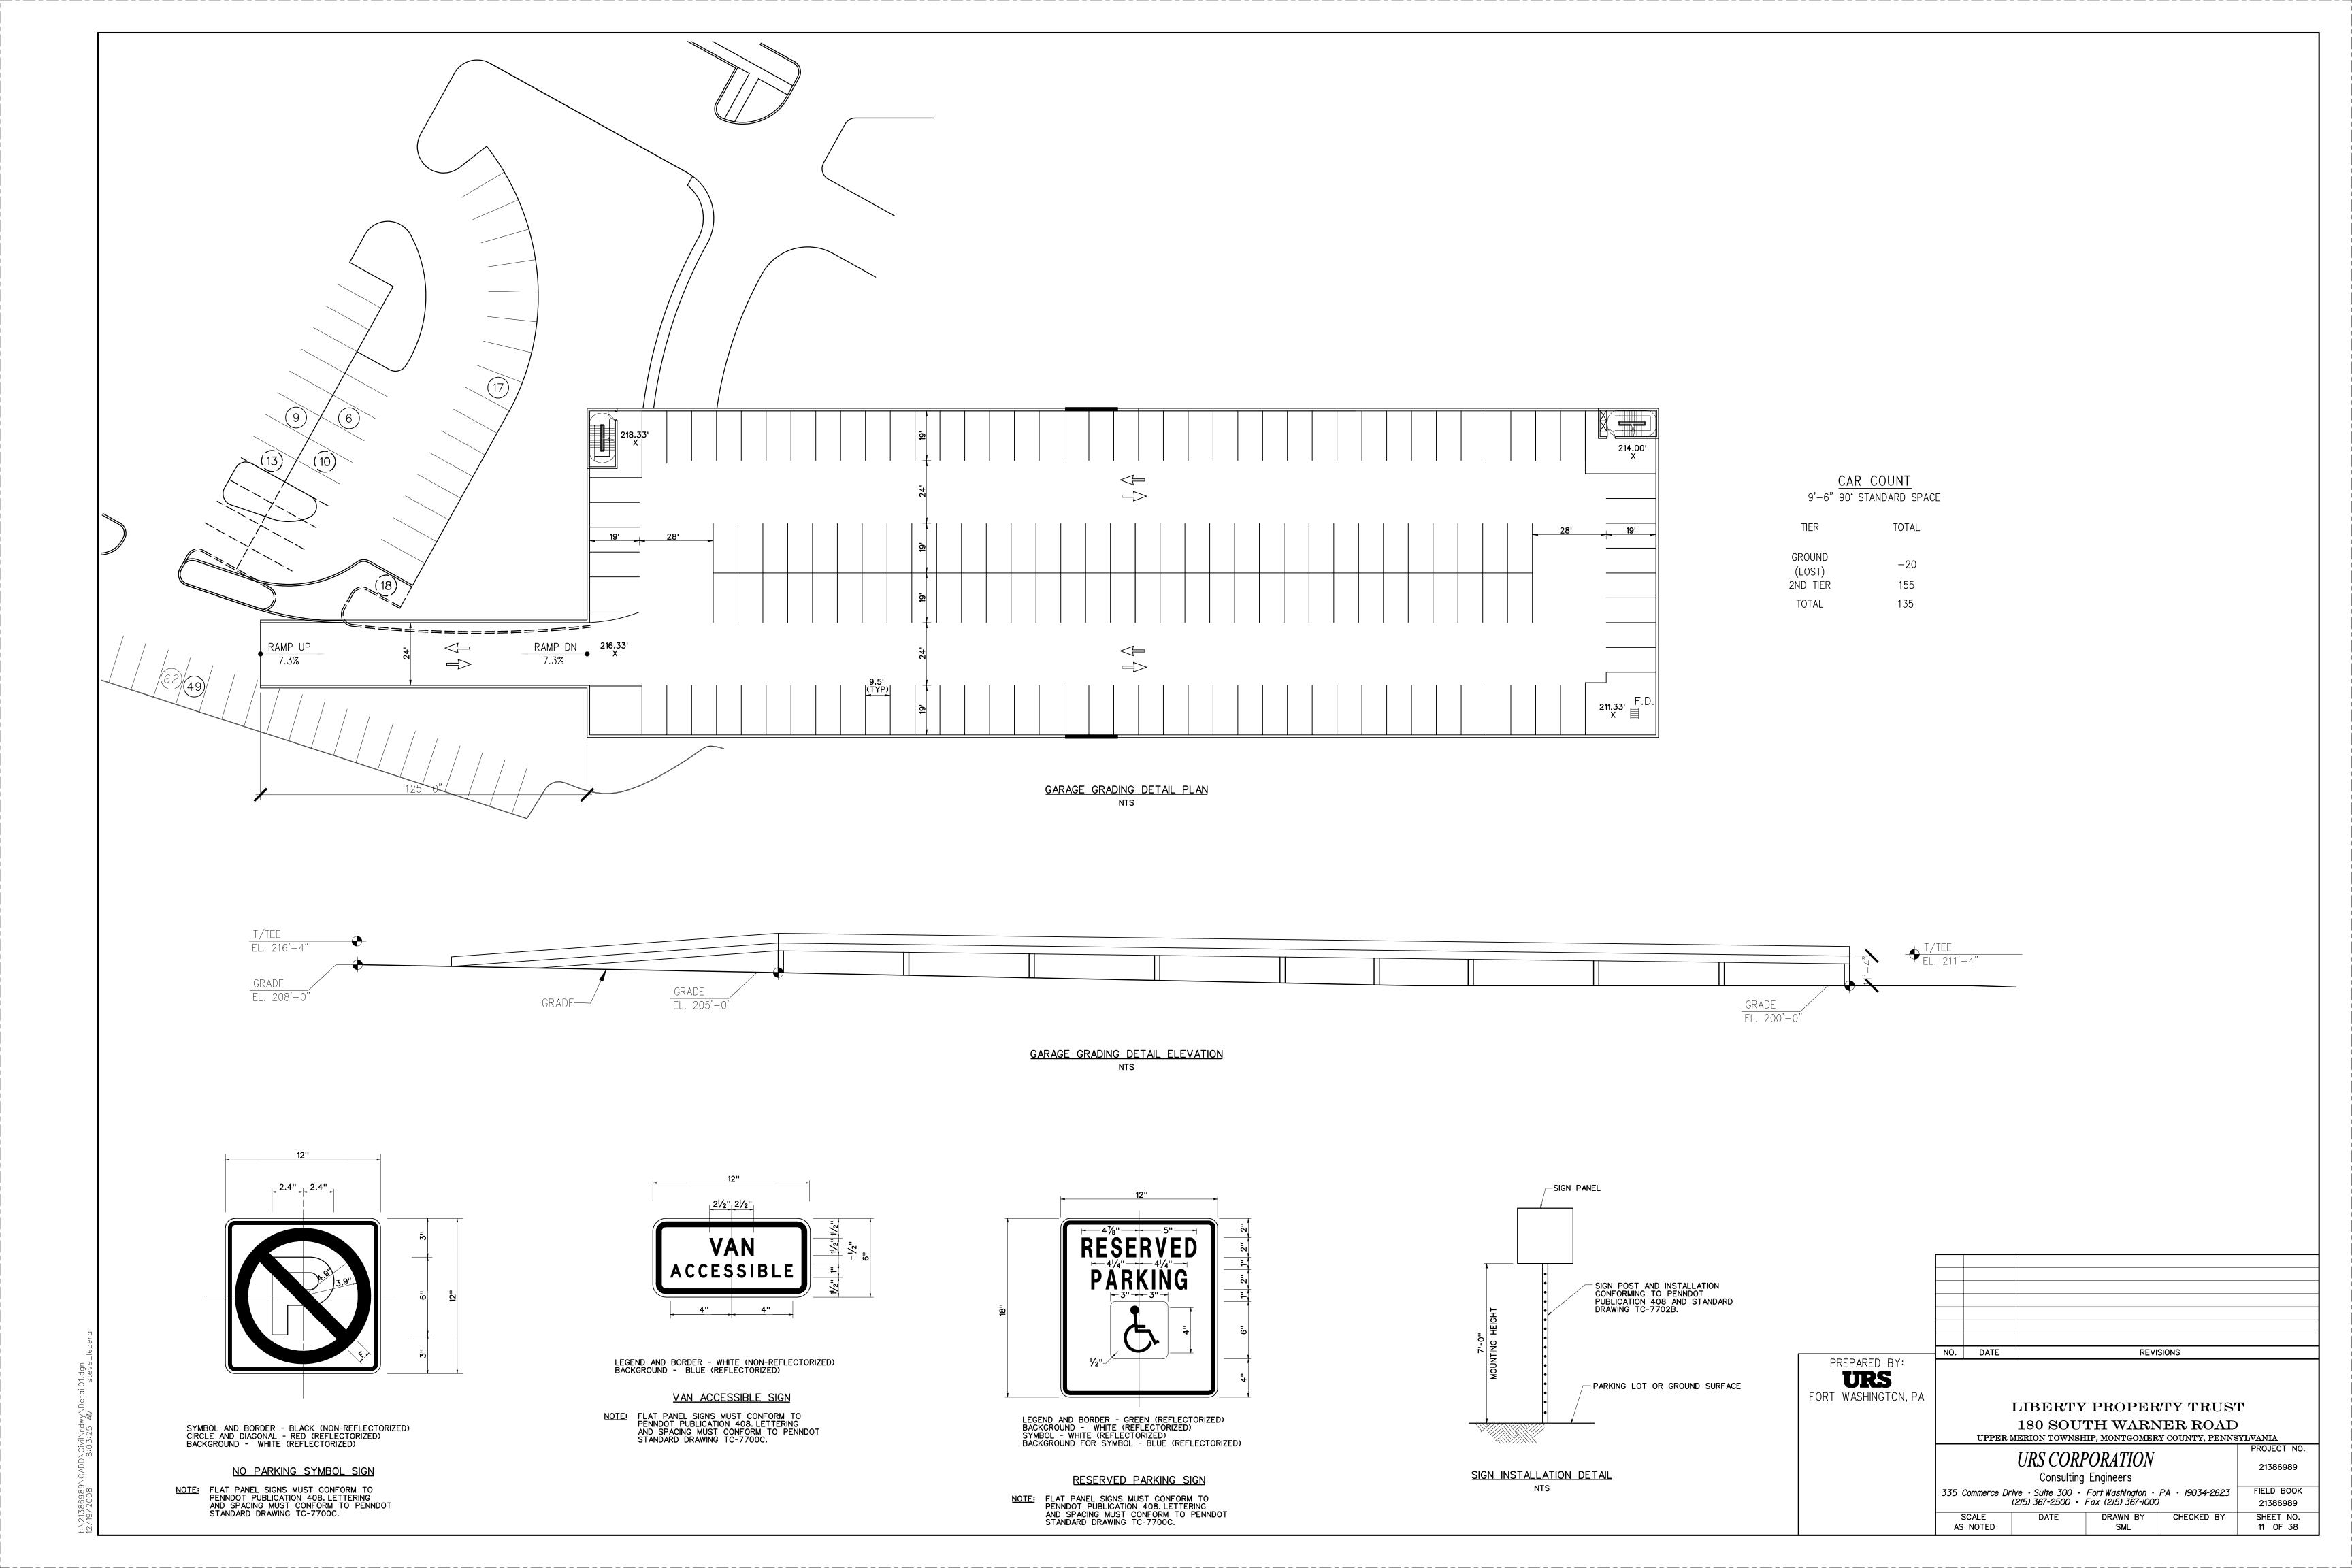

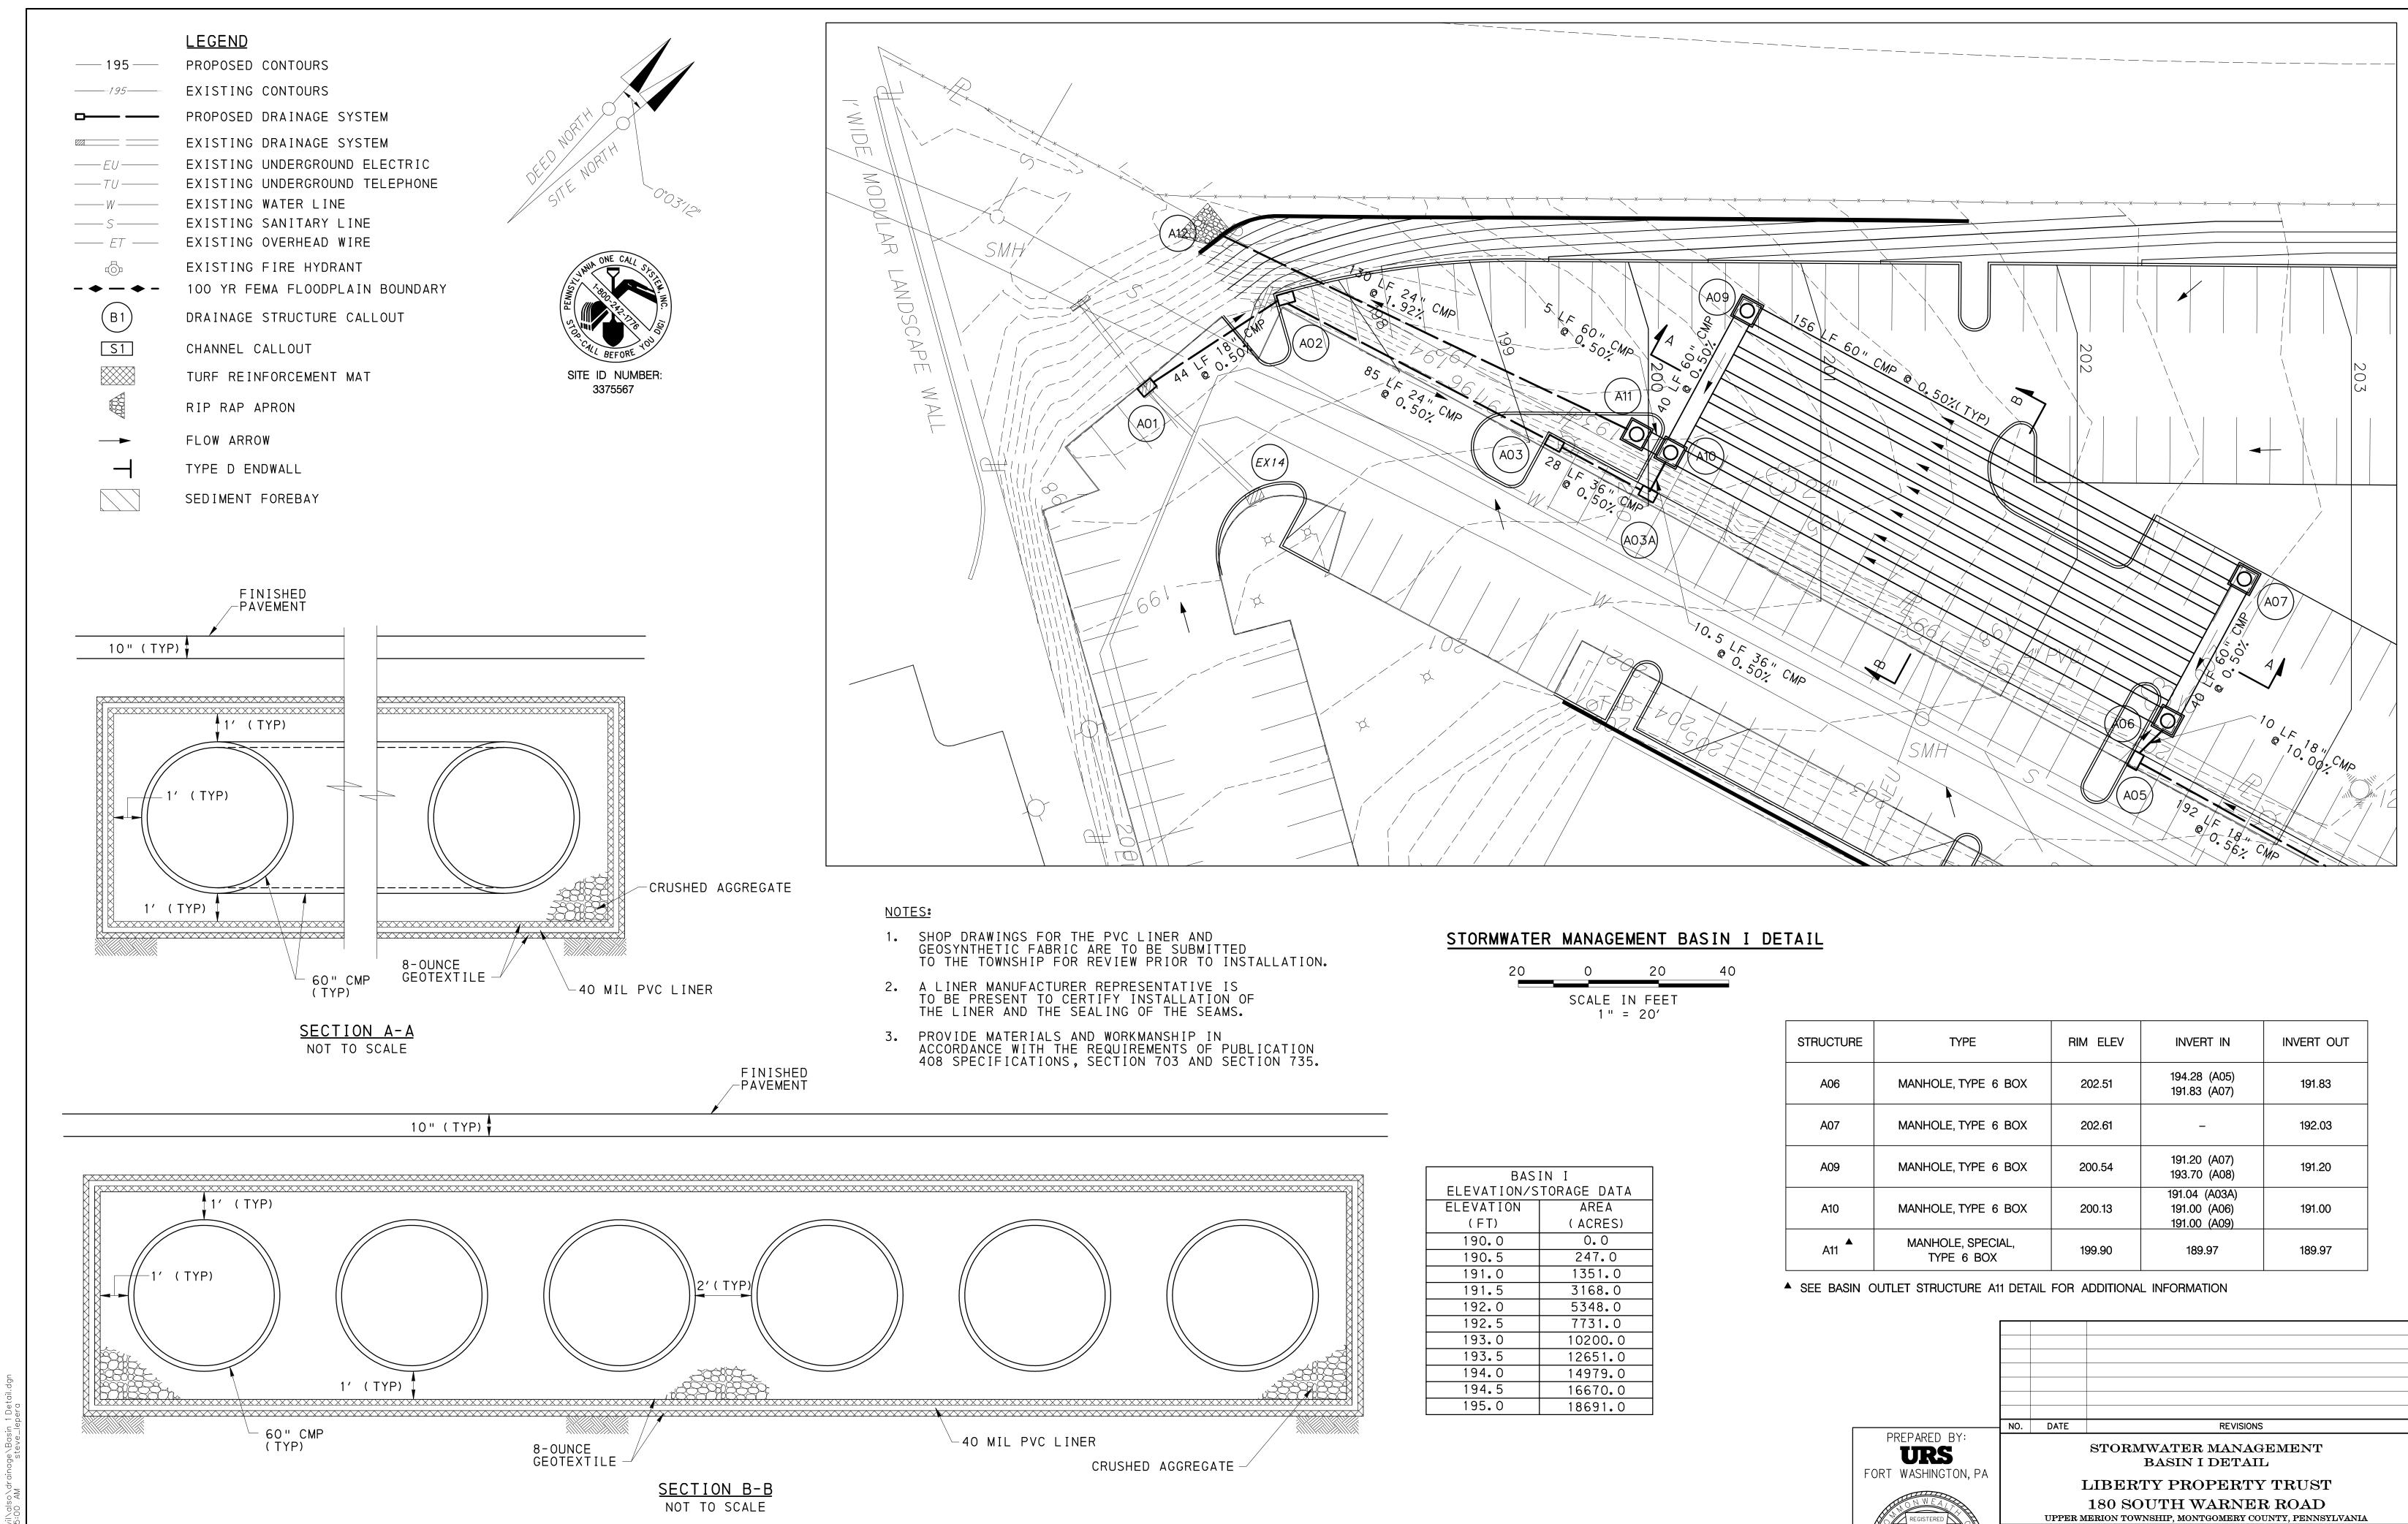

URS CORPORATION

Consulting Engineers

335 Commerce Drive • Suite 300 • Fort Washington • PA • 19034-2623 (215) 367-2500 • Fax (215) 367-1000

AS NOTED

DRAWN BY

SML


YUEN LING EDWINA LAM

21386989


FIELD BOOK 21386989 SHEET NO.


6 OF 17

t:\21386989\CADD\Civil\also\drainage\Basin 1 Detail 12/30/2008 6:05:00 AM steve lenera

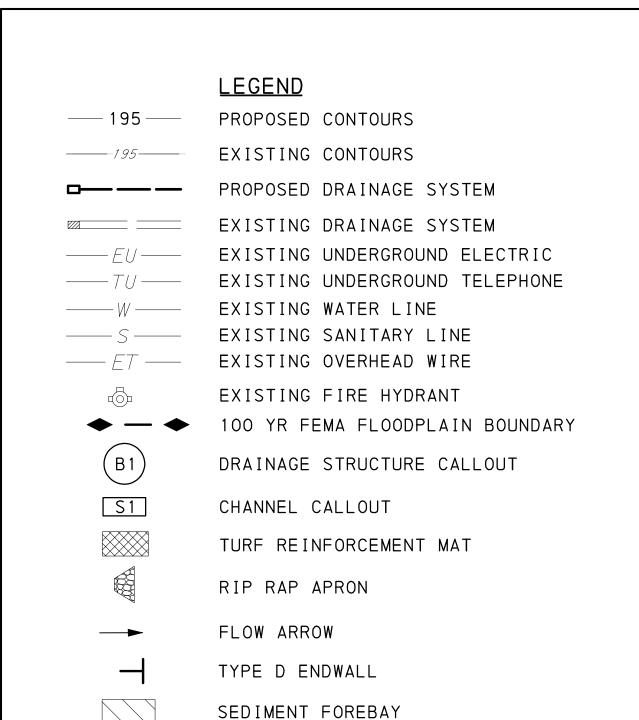



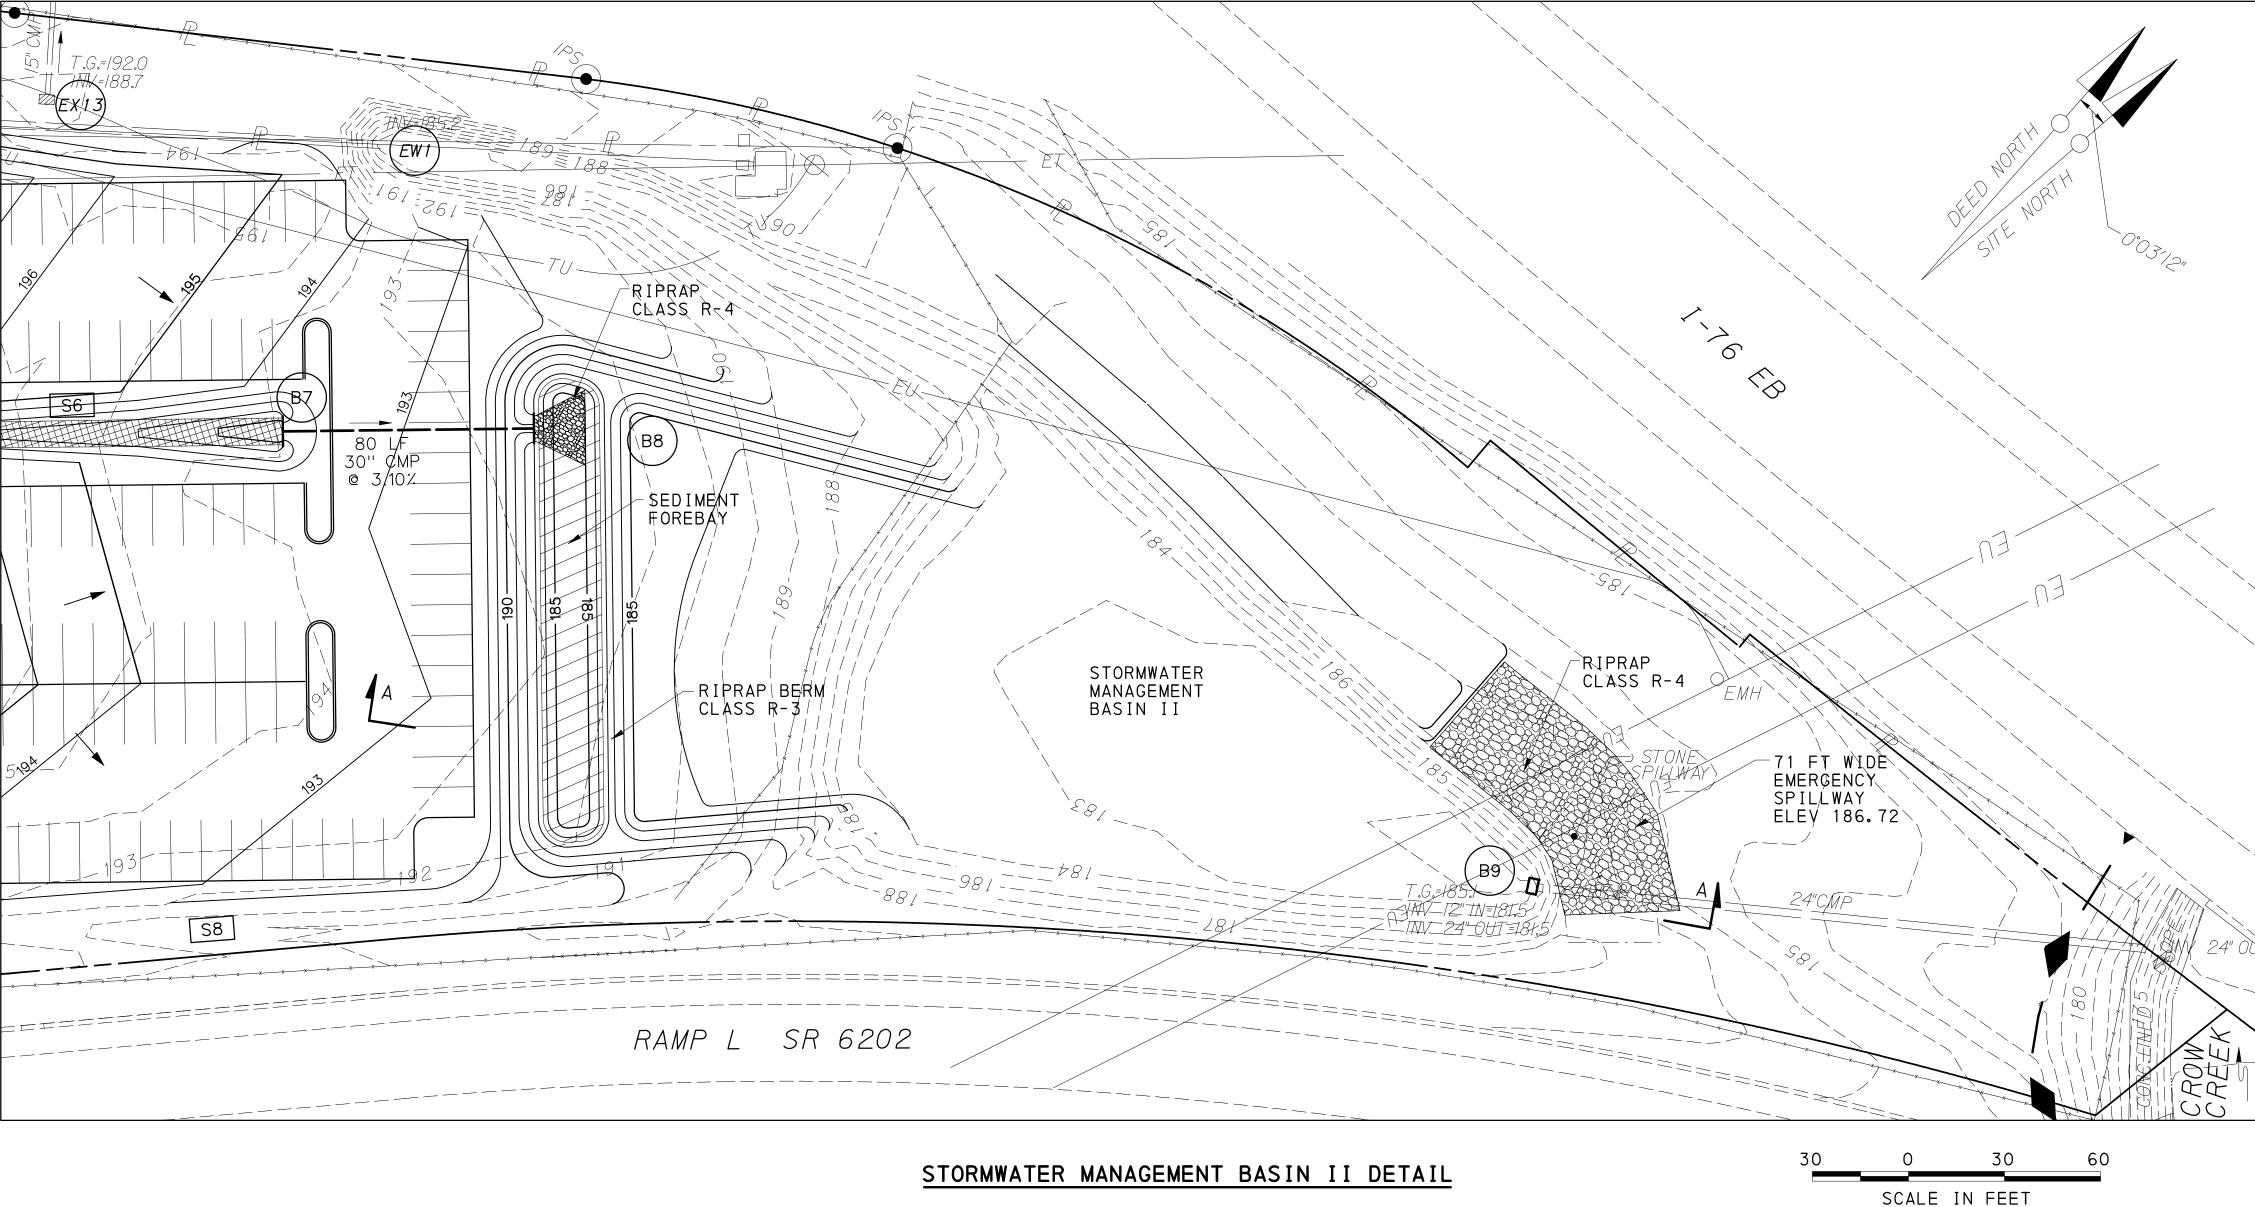

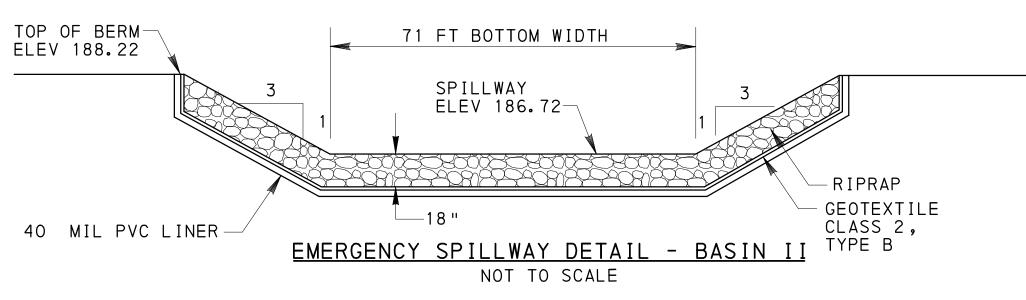

	SEDIMENT FOREBAY DATA								
BASIN	REQUIRED VOL. (CU. FT.)	BERM ELEV.	BERM RIPRAP SIZE	BERM LENGTH (FT)	C. O. E.	BLOCK PAVER AREA (SQ. FT.)			
ΙΙ	3332	187.00	R-3	143.5	186.20	2700			

NOTES:

- 1. INSTALL SEDIMENT FOREBAY AFTER COMPLETION OF ALL CONSTRUCTION ACTIVITIES WITHIN CONTRIBUTING AREA.
- 2. INSTALL 2" WOOD STAKE AT DOWNSLOPE END OF SEDIMENT FOREBAY WITH CLEANOUT ELEVATION (C.O.E.) CLEARLY NOTED.
- 3. INSTALL PERMEABLE BLOCK PAVERS ALONG BOTTOM OF SEDIMENT FOREBAY AND ALONG SIDE SLOPES UP TO C.O.E.

# NOTES:

40 MIL PVC LINER-

1. SHOP DRAWINGS FOR THE PVC LINER AND GEOSYNTHETIC FABRIC ARE TO BE SUBMITTED TO THE TOWNSHIP FOR REVIEW PRIOR TO INSTALLATION.

RIP-RAP BERM

- CLASS R-3

OUTLET STRUCTURE B-9-

1% BOTTOM SLOPE

-EXISTING-LINER \*

-BOTTOM OF BASIN

ELEV 181.50'

100-YR FLOOD STAGE ELEV 186.71

BASIN II CROSS SECTION A-A DETAIL

NOT TO SCALE

2. A LINER MANUFACTURER REPRESENTATIVE IS TO BE PRESENT TO CERTIFY INSTALLATION OF THE LINER AND THE SEALING OF THE SEAMS.


WELD LINERS IN ACCORDANCE WITH ASTM D7408-08

EMBANKMENT

SEDIMENT

-FOREBAY

3. PROVIDE MATERIALS AND WORKMANSHIP IN ACCORDANCE WITH THE REQUIREMENTS OF PUBLICATION 408 SPECIFICATIONS, SECTION 703 AND SECTION 735.

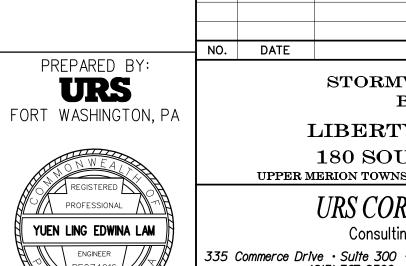

BY THE TOWNSHIP.

10' MIN

STORMWATER MANAGEMENT
BASIN II DETAIL

LIBERTY PROPERTY TRUST

180 SOUTH WARNER ROAD

UPPER MERION TOWNSHIP, MONTGOMERY COUNTY, PENNSYLVANIA

URS CORPORATION

Consulting Engineers

1" = 30'

\* CONTRACTOR IS TO DETERMINE THE EXISTING LINER TYPE. USING\_ALTERNATE LINING WILL NEED TO BE APPROVED

EMERGENCY SPILLWAY
-ELEV 186.72

TOP OF BERM

ELEV 188.22

Consulting Engineers


335 Commerce Drive · Suite 300 · Fort Washington · PA · 19034-2623 FIELD BOOK
(215) 367-2500 · Fax (215) 367-1000 21386989


SCALE DATE DRAWN BY CHECKED BY SHEET NO.
AS NOTED SML 7 OF 17

21386989


BASIN II					
ELEVATION/S	TORAGE DATA				
ELEVATION	AREA				
(FT)	(ACRES)				
181.5	0.0007				
182.0	0.0135				
183.0	0.1935				
184.0	0.5449				
185.0	0.7400				
186.0	0.8469				
187.0	0.9397				
188.22	1.0407				

989\CADD\Civil\also\drainage\Basin 2 Detail.dgn 008 6:06:51 AM steve\_lepera

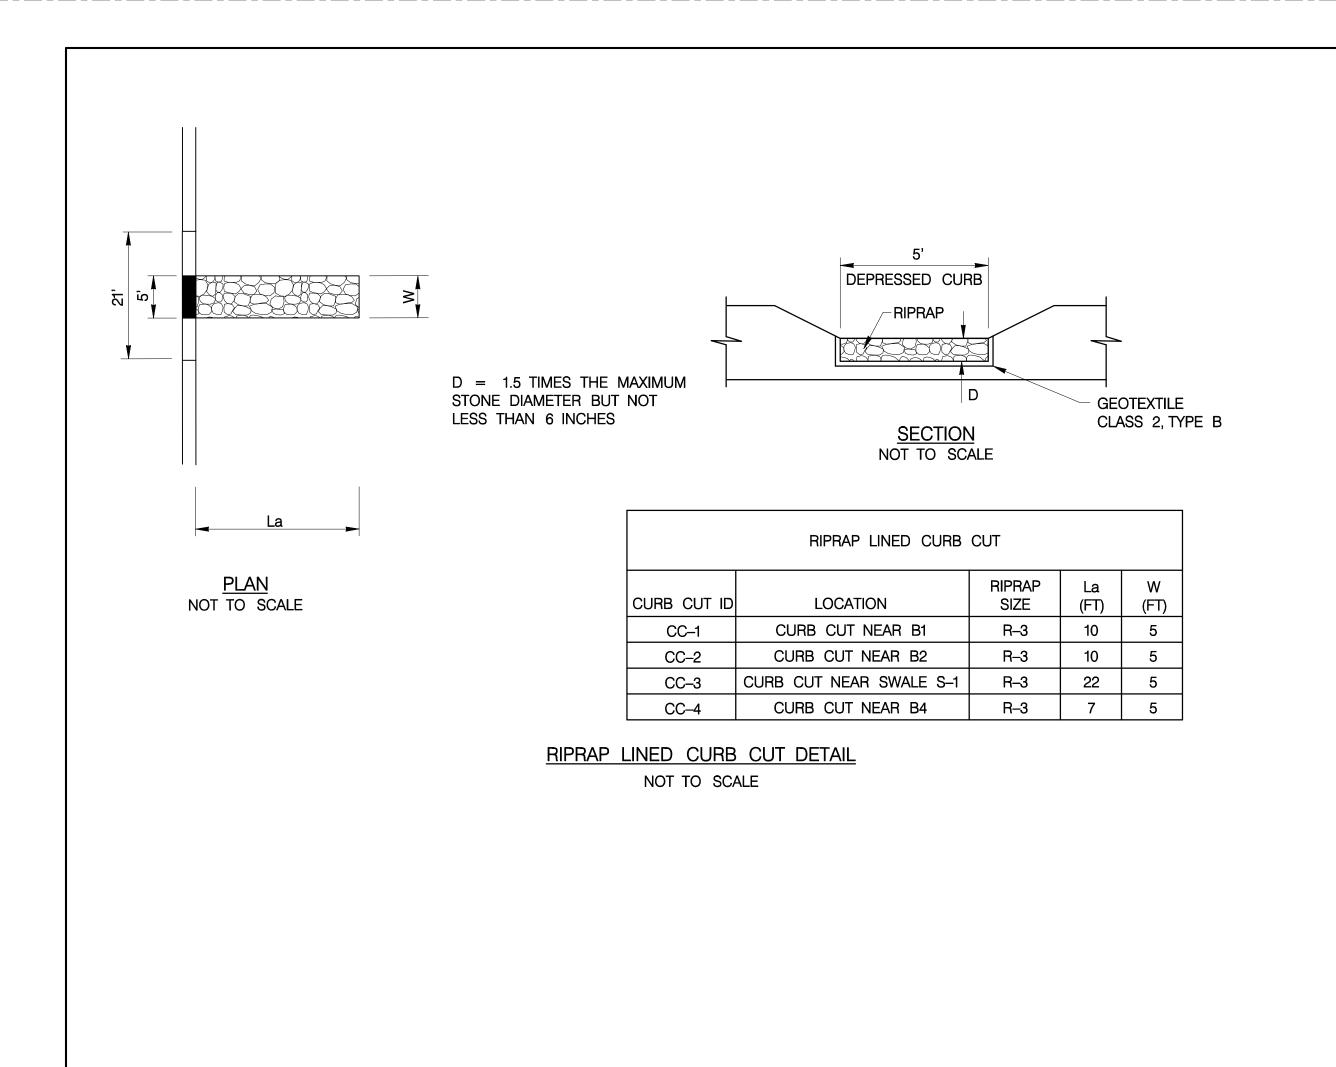


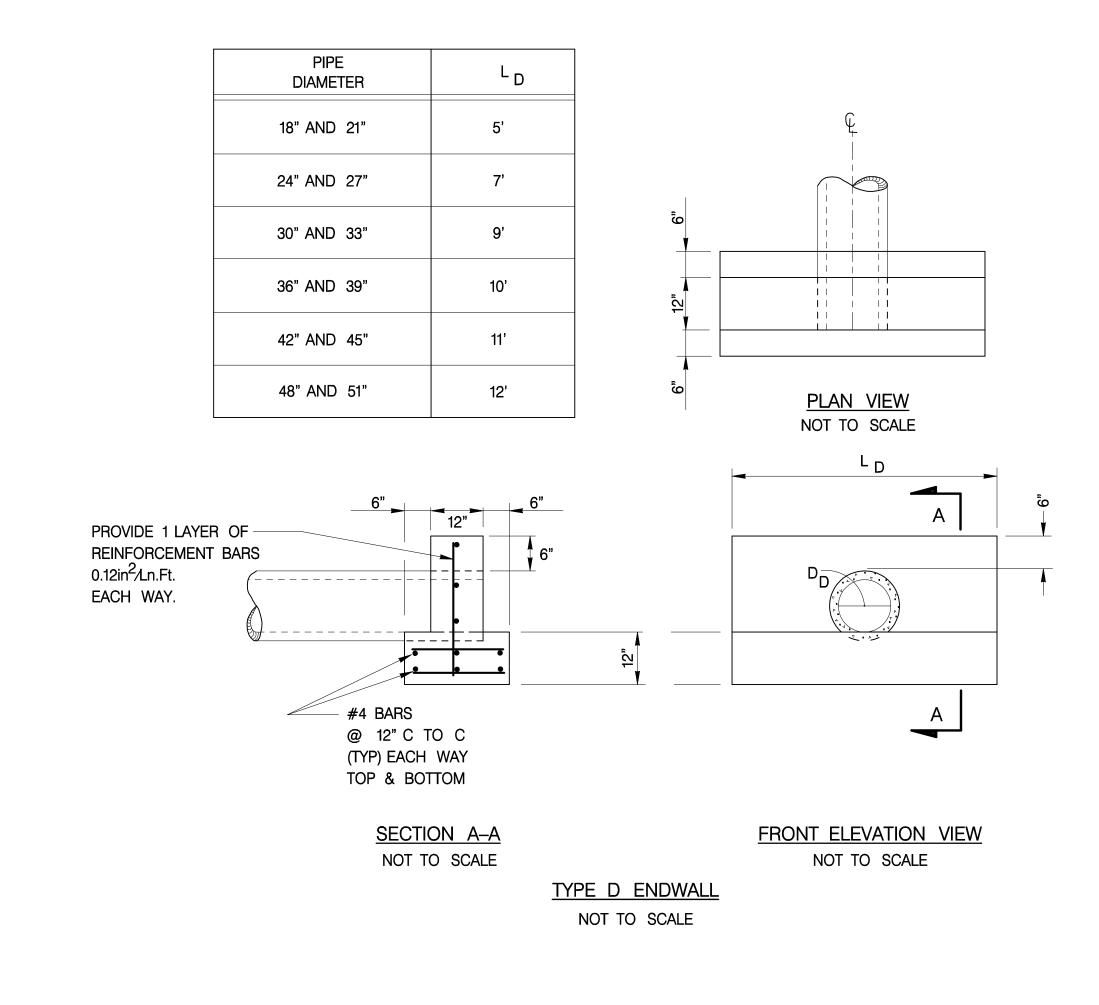

MANHOLE CAP INLET DETAIL NOT TO SCALE

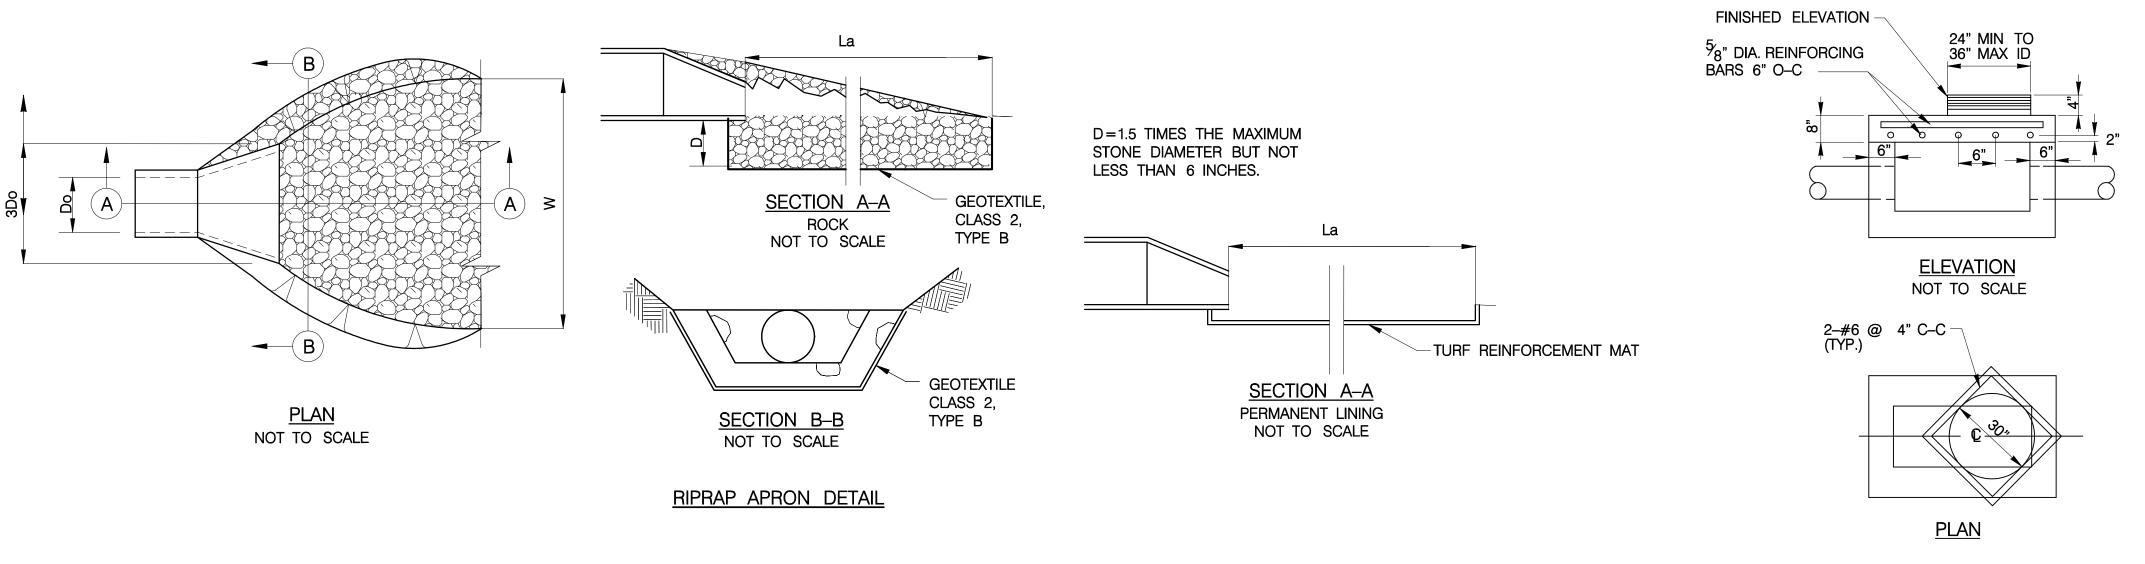

ROCK APRONS FOR DISCHARGE PIPES									
PIPE ID	LOCATION	PIPE DIA (in)	SLOPE (FT/FT)	STONE SIZE	TAILWATER MIN OR MAX	Q (cfs)	V (fps)	La (ft)	W (ft)
A12	BASIN I OUTLET STRUCTURE	24	0.005	R-3	MIN	14.01	4.46	7.00	13.00
B6	SWALE S6 INLET STRUCTURE	18	0.010	R-3	MIN	7.86	4.45	9.00	13.50
B8	BASIN II INLET STRUCTURE	30	0.020	R-4	MIN	21.64	4.41	16.00	23.50

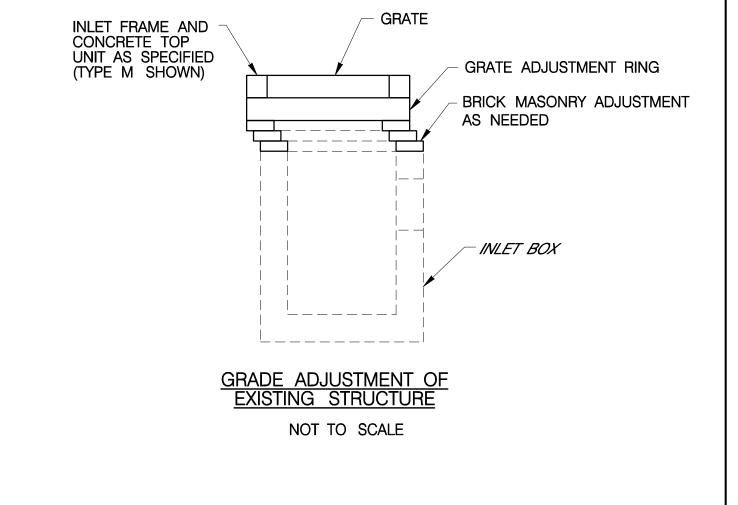




21386989

FIELD BOOK 21386989 SHEET NO.


14 OF 38

DRAWN BY CHECKED BY

SML

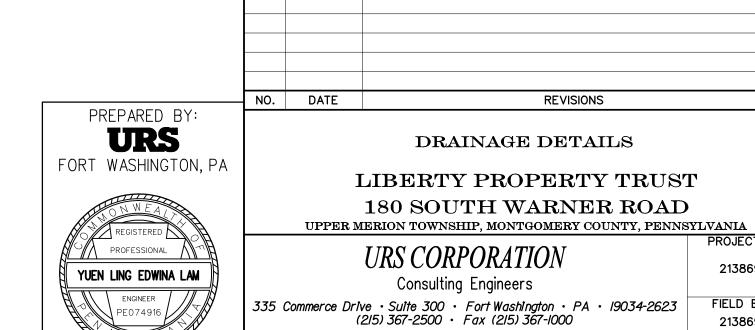

AS NOTED

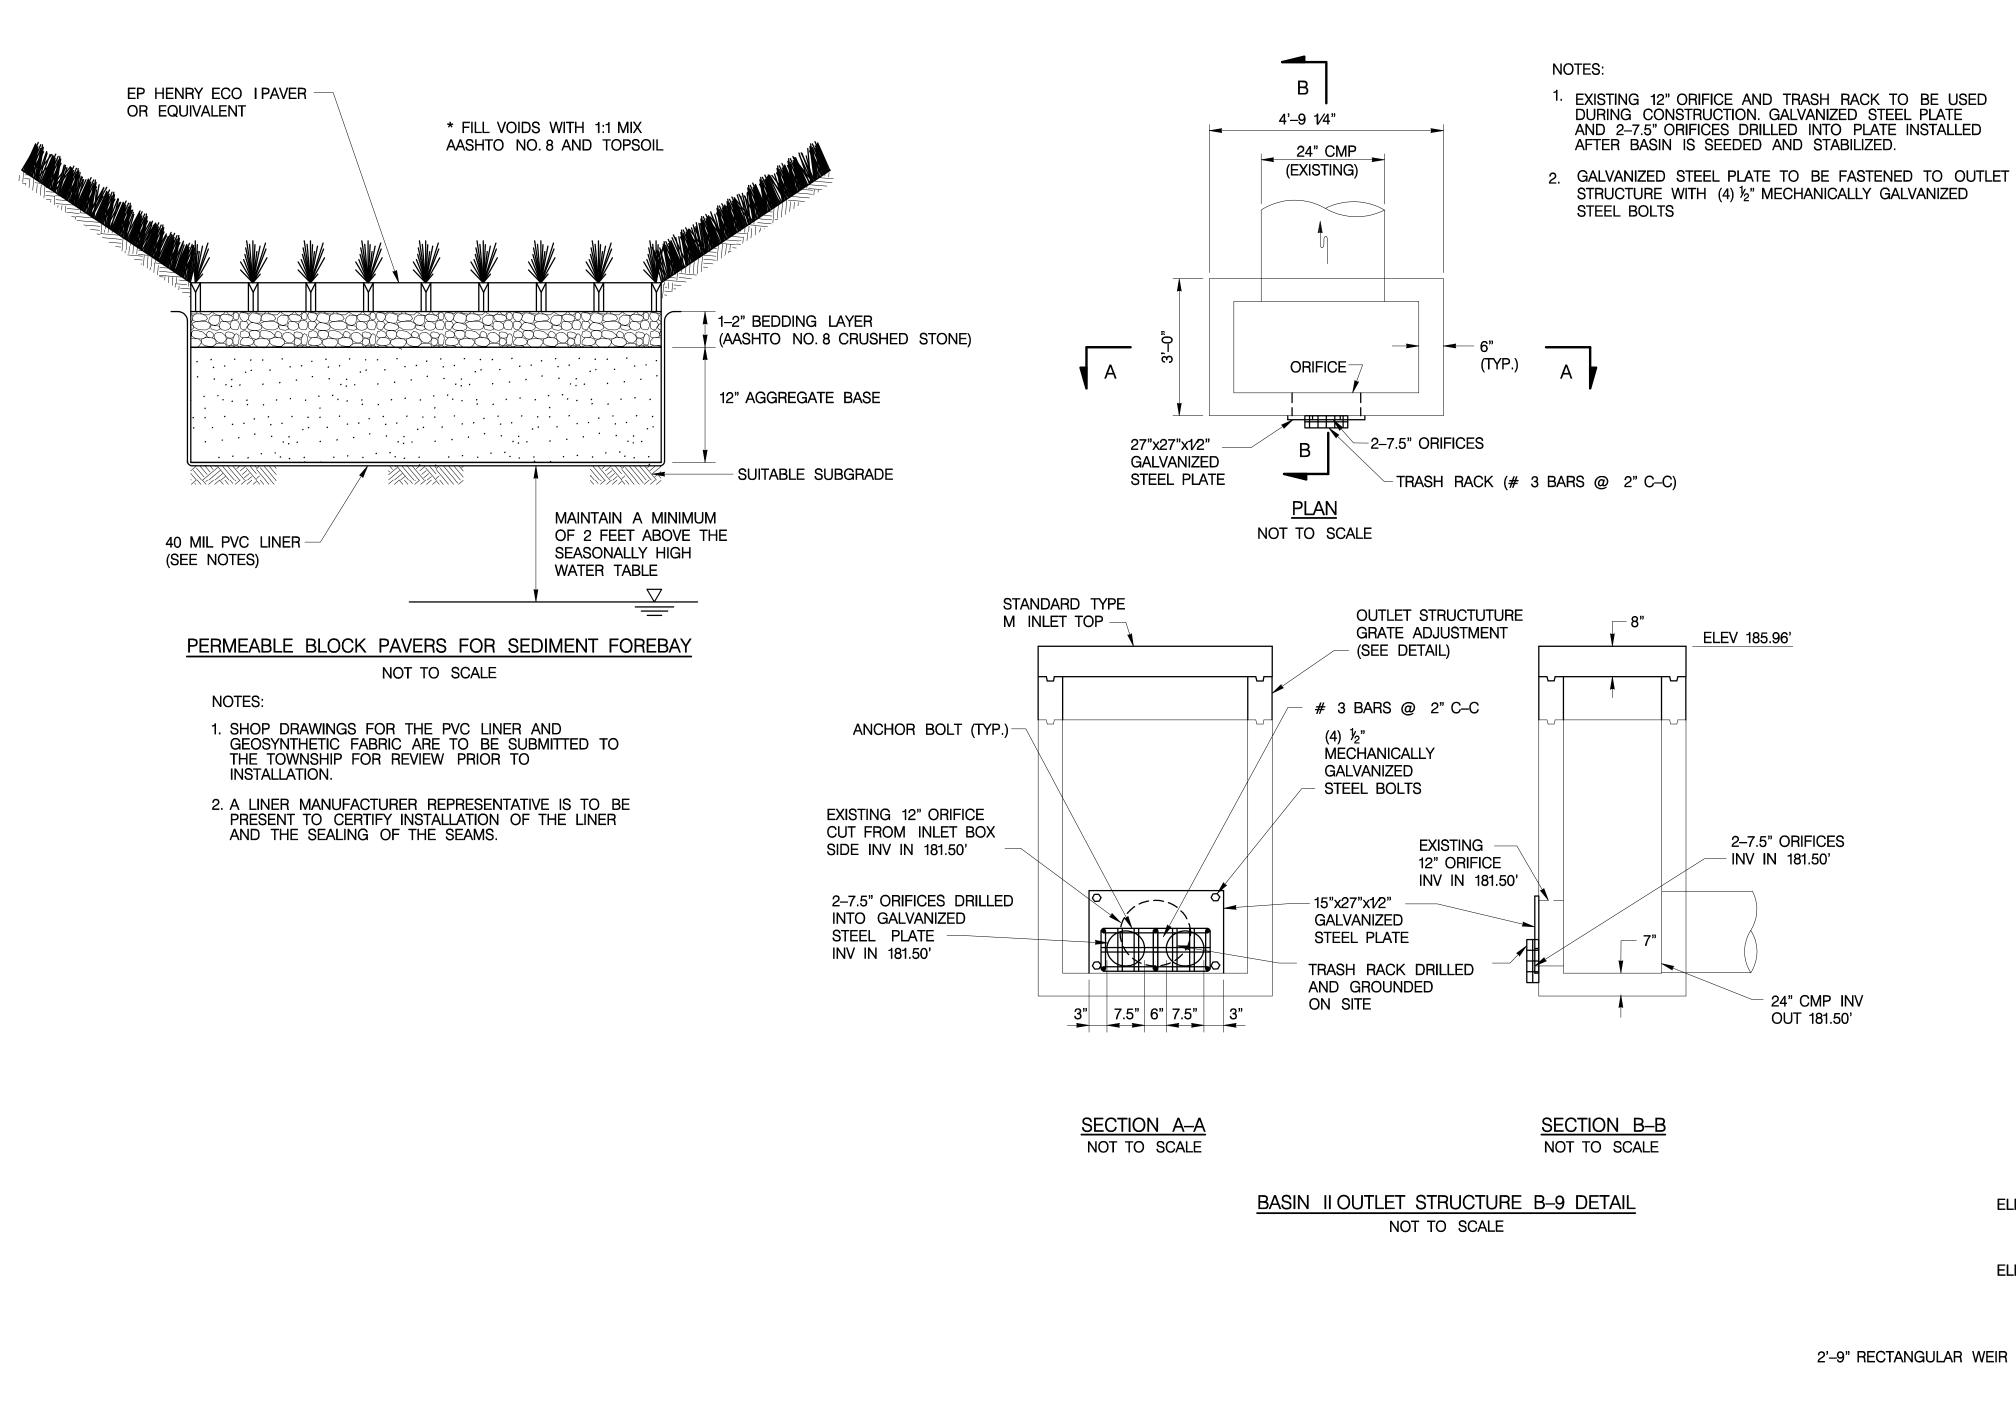

BASIN II OUTLET STRUCTURE B-9 DETAIL


ELEV 185.96'

2-7.5" ORIFICES

- 24" CMP INV

OUT 181.50'

- INV IN 181.50'

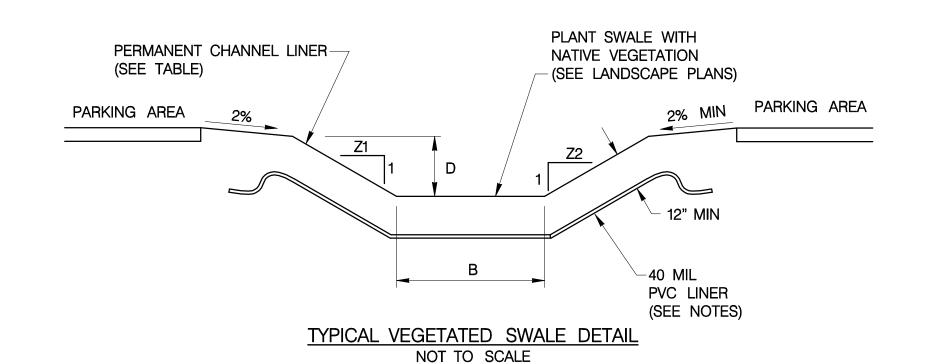


LOCATION ON SITE	BOTTOM WIDTH B (ft)	LT SIDE SLOPE (1:Z1)	RT SIDE SLOPE (1:Z2)	*MAX DEPTH D (ft)	PERMANENT CHANNEL LINING
IN FRONT OF PROPOSED BUILDING	2.00	3	3	0.21	N/A
NORTHERN HALF OF SWALE IN FRONT OF 190 S. WARNER RD	2.00	3	3	0.22	N/A
SOUTHERN HALF OF SWALE IN FRONT OF 190 S. WARNER RD	2.00	3	3	0.37	N/A
SWALE LEADING TO BASIN II	2.00	3	3	0.84	TURF REINFORCEMENT MAT
EXISTING SWALE BEHIND PROPOSED PARKING GARAGE	5.00	4	4	0.50	N/A


\* MAX DEPTH IS BASED ON 100-YEAR STORM IN PERMANENT CONDITION.

EXISTING SWALE FROM SWALE S7 TO BASIN II

## NOTES:

- 1. SHOP DRAWINGS FOR THE PVC LINER AND GEOSYNTHETIC FABRIC ARE TO BE SUBMITTED TO THE TOWNSHIP FOR REVIEW PRIOR TO INSTALLATION.
- 2. A LINER MANUFACTURER REPRESENTATIVE IS TO BE PRESENT TO CERTIFY INSTALLATION OF THE LINER AND THE SEALING OF THE SEAMS.

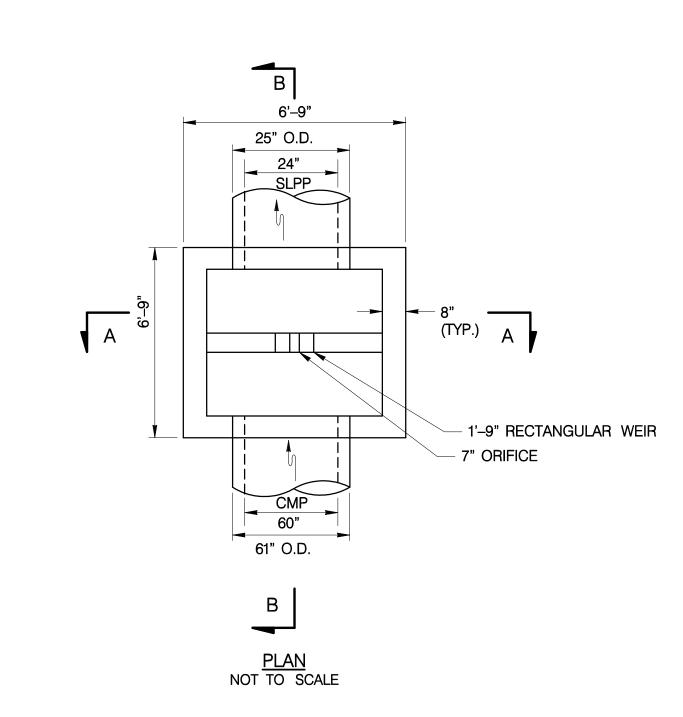


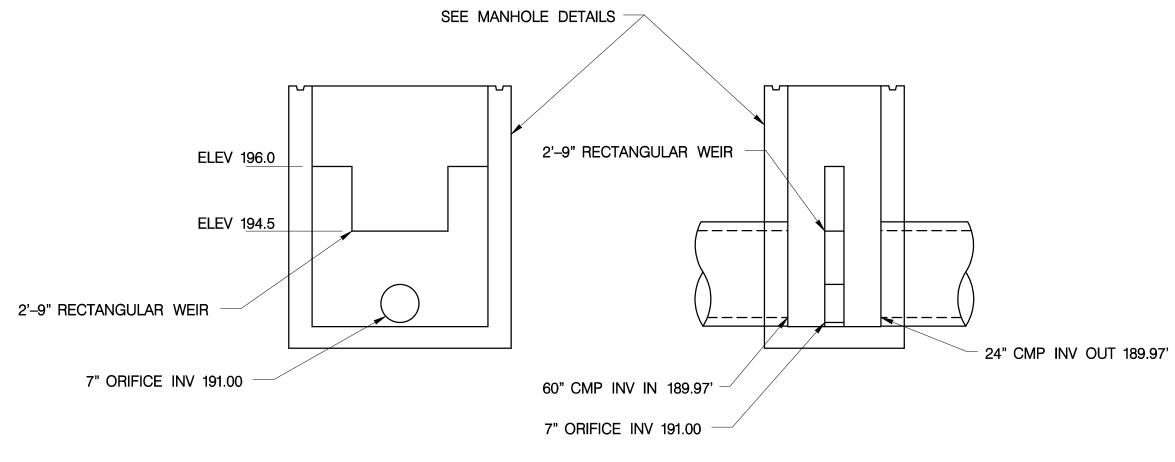

SECTION A-A NOT TO SCALE SECTION B-B NOT TO SCALE

BASIN I OUTLET STRUCTURE A11 DETAIL NOT TO SCALE



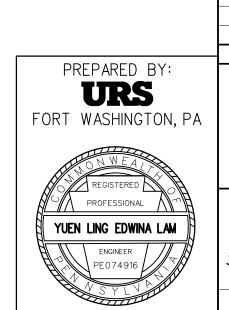

NO.	DATE	REVISIONS	
NO. DATE REVISIONS  DRAINAGE DETAILS			
	I	LIBERTY PROPERTY TRUST	

180 SOUTH WARNER ROAD UPPER MERION TOWNSHIP, MONTGOMERY COUNTY, PENNSYLVANIA

21386989

•
URS CORPORATION
Consulting Engineers
mmerce Drive · Suite 300 · Fort Washington · PA · 19034-2623

FIELD BOOK 335 Com (215) 367-2500 · Fax (215) 367-1000 21386989 SHEET NO. DRAWN BY CHECKED BY AS NOTED SML 15 OF 38


ID

S1

S4

S5

S6

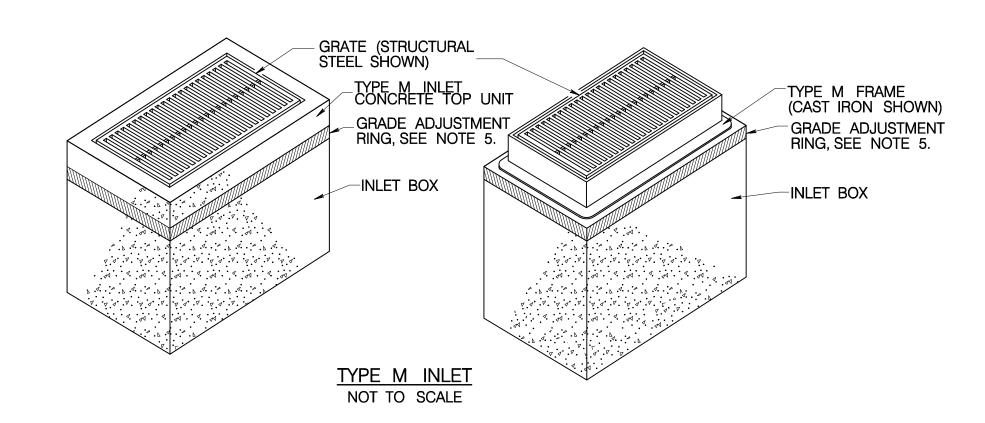

#### **PLACEMENT NOTES:**

- 1. EACH TYPE OF CONCRETE TOP UNIT OR FRAME IS SUITED FOR A PARTICULAR SITUATION AS FOLLOWS:
  - TYPE C CONCRETE TOP UNIT AND TYPE C ALTERNATE CONCRETE TOP UNIT WITH A TYPE C FRAME ARE DESIGNATED FOR INSTALLATION WITH NON-
  - TYPE M CONCRETE TOP UNIT AND TYPE M FRAMES ARE DESIGNATED FOR INSTALLATION IN AREAS ADJACENT TO MEDIANS AND MOUNTABLE CURBS.
- 2. PLACEMENT OF CONCRETE TOP UNITS:
  - TYPE C AND TYPE C ALTERNATE: DOWEL THE TOP UNIT INTO THE ADJACENT CURB SECTIONS WITH 2-#8 x 1'-0" DOWEL BARS. PLACE 1/4" WIDE PREMOLDED
  - EXPANSION JOINT FILLER BETWEEN TOP UNIT AND ADJACENT CURB • PLACE THE TOP UNIT OR FRAME ADJACENT TO THE BACK EDGE OF THE CURB, FLUSH WITH THE PAVEMENT SURFACE, WHEN REQUIRED WITHIN A
- CONCRETE MOUNTABLE CURB SECTION. 3. THE SELECTION OF COMPONENTS TO ACHIEVE A SPECIFIED INLET ASSEMBLY IS THE
- CONTRACTOR'S RESPONSIBILITY, UNLESS OTHERWISE INDICATED ON THE CONTRACT 4. SET THE PRECAST CONCRETE TOP UNITS ON A NON-SHRINK GROUT PAD TO PROVIDE
- FULL BEARING ON THE SUPPORTING SURFACE. NON-SHRINK GROUT IS ALSO PERMITTED FOR CROSS SLOPE AND LONGITUDINAL GRADE ADJUSTMENTS.
  - PROVIDE NON-SHRINK GROUT IN ACCORDANCE WITH PUBLICATION 408, SECTION 1001.2(d).
  - MINIMUM GROÙT DEPTH = 1/2 "
- MAXIMUM GROUT DEPTH = 1" FOR ALTERNATE GRADE ADJUSTMENT SYSTEMS, WHICH DO NOT REQUIRE NON-SHRINK GROUT, REFER TO NOTE 5 UNDER THE GRADE ADJUSTMENT RING GENERAL NOTES ON
- 5. BRICK OR BRICK AND MORTAR ARE NOT ALLOWED FOR GRADE ADJUSTMENTS FOR NEW OR REHABILITATION PROJECTS.


SECTION C-C

NOT TO SCALE

- 1. CONSTRUCTION REQUIREMENTS:
- A CONSTRUCT IN ACCORDANCE WITH PUBLICATION 408, SECTIONS 605, 606 AND 714; AND AS MODIFIED
- B. MINIMUM CONCRETE CLASS: CAST-IN-PLACE CLASS A
- CLASS AA C. PROVIDE STEEL REINFORCEMENT IN ACCORDANCE WITH PUBLICATION 408, SECTION 709. PROVIDE
- MINIMUM YIELD STRENGTH OF 60,000 PSI. D. CLEAR COVER FOR STEEL
  - WALLS: CAST-IN PLACE 2" 1\*"<sup>1</sup>⁄2" PRECAST
  - FOOTINGS: CAST-IN PLACE 2 7 TOP BARS
    - 3" BOTTOM BARS
    - 2" SIDE COVER PRECAST
      - 2" TOP BARS 1/2" BOTTOM BARS
      - 1½" SIDE COVER
- SLABS: CAST-IN PLACE 2" TOP & BOTTOM BARS 2. THIS DETAIL DEPICTS THE VARIOUS COMPONENTS REQUIRED FOR COMPLETE INLET ASSEMBLIES. FOR INDIVIDUAL COMPONENTS AND
- 3. EACH TYPE OF INLET SHOWN IS SUITED FOR A PARTICULAR SITUATION AS FOLLOWS:

OTHER SPECIAL DETAILS, SEE REMAINING DETAILS:

- TYPE C INLET IS DESIGNATED FOR INSTALLATION WITH NON-MOUNTABLE CURBS.
- TYPE M INLET IS DESIGNATED FOR INSTALLATION IN MEDIAN AREAS AND MOUNTABLE CURBS.
- 4. THE SELECTION OF COMPONENTS TO ACHIEVE A SPECIFIED INLET ASSEMBLY IS THE CONTRACTOR'S RESPONSIBILITY.
- 5. USE PRECAST CONCRETE OR STEEL GRADE ADJUSTMENT RINGS WHEN REQUIRED. (REHABILITATION PROJECTS)
- 6. FOR WALL REINFORCEMENT, BOTH DIRECTIONS, USE 10 IN 2/FT MIN EACH WAY, EACH FACE 6" MAX. SPACING.
- 7. FOR FOOTING REINFORCEMENT, TOP AND BOTTOM, USE #4 BARS AT 12" CENTERS EACH WAY OR 17IN 2/FT WWF 6" MAX.SPACING.
- 8. PROVIDE WEEP HOLES ON INLET BOXES WHEN REQUIRED.
- 9. PIPES MAY BE CONNECTED TO DRAINAGE STRUCTURES (PRECAST INLETS, ETC.) WITH MORTAR OR WATERTIGHT RUBBER FLEXIBLE CONNECTORS.

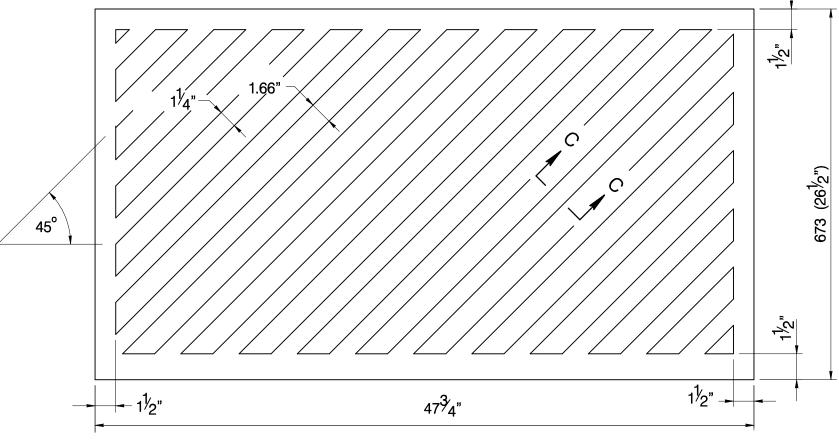

PLAN - ONE PIECE GRATE NOT TO SCALE

#### <u>NOTES</u>

- 1. THIS SHEET DEPICTS THE DIMENSIONS REQUIRED FOR UNIFORMITY AND INTERCHANGEABILITY. IT DOES NOT INCLUDE DETAILS REQUIRED FOR FABRICATION OR MANUFACTURING. PERMIT ONLY GRATES SUPPLIED BY A MANUFACTURER LISTED IN BULLETIN 15. FOR DEVIATIONS OR MODIFICATIONS OF THE STANDARDS SUBMIT SHOP DRAWINGS FOR APPROVAL.
- 2. CAST IRON GRATES MAY BE USED AS ALTERNATES TO STRUCTURAL STEEL GRATES PROVIDED THEY ARE SUPPLIED BY A MANUFACTURER LISTED IN BULLETIN 15 AND APPROVED FOR HS25 LOADING. CAST IRON GRATES NOT APPROVED FOR HS25 LOADING MAY BE USED OUTSIDE OF THE TRAVEL LANES; AT THE EDGE OF OUTSIDE SHOULDERS, SWALES, WIDE MEDIAN SWALES AND INFIELD AREAS.
- 3. THE FOLLOWING TWO DIFFERENT GRATE DEPTHS ARE SPECIFIED ON THIS
  - CAST IRON GRATES = 2 1/2 " DEPTH (MINIMUM)
- 4. THE SELECTION OF THE TYPE OF GRATE MATERIAL IS THE CONTRACTOR'S RESPONSIBILITY. UNLESS OTHERWISE INDICATED ON THE CONTRACT DOCUMENTS.


## CAST GRAY IRON GRATES

ASTM A-48, CLASS 35B (SEE NOTE 3) NOT TO SCALE

#### CONCRETE TOP UNIT NOTES:

- 1. SHEETS 2 THRU 6 DEPICTS THE DIMENSIONS REQUIRED FOR UNIFORMITY AND INTERCHANGEABILITY. IT DOES NOT INCLUDE DETAILS REQUIRED FOR FABRICATION OR MANUFACTURING. FOR DEVIATIONS OR MODIFICATIONS OF THE STANDARDS, SUBMIT SHOP DRAWINGS TO THE BUREAU OF DESIGN HIGHWAY QUALITY ASSURANCE DIVISION CHIEF FOR REVIEW AND ACCEPTANCE.
- 2. PROVIDE PRECAST CONCRETE TOP UNITS SUPPLIED BY A MANUFACTURER LISTED IN BULLETIN 15.
- 3. CAST-IN-PLACE TOP UNITS MAY BE MONOLITHIC WITH THE INLET BOX.
- 4. PROVIDE MATERIALS AND WORKMANSHIP IN ACCORDANCE WITH THE PUBLICATION 408. SECTIONS 605 AND 714, AASHTO/AWS BRIDGE WELDING CODE AND THE CONTRACT SPECIAL PROVISIONS.
- 5. THE SIZE OF THE INLET TOPS UNITS IS BASED ON THE MINIMUM DIMENSIONS INDICATED FOR THE STANDARD INLET BOX AS SHOWN ON RC-46M.
- 6. PROVIDE A TOP SLAB TO SUPPORT THE INLET TOP UNITS IF A STANDARD INLET BOX IS NOT SPECIFIED.
- 7. FABRICATOR IS RESPONSIBLE FOR LIFTING. HANDLING AND TRANSPORTATION STRESSES.
- 8. LIFTING DEVICES (IF REQUIRED):
  - PROVIDE GALVANIZED STEEL OR PLASTIC LIFTING DEVICES FOR HANDLING AND INSTALLATION.
  - FILL LIFTING DEVICES WITH NON-SHRINK GROUT AFTER INSTALLATION.
  - PROVIDE LIFTING DEVICES WITH A MINIMUM CAPACITY OF AT LEAST FOUR TIMES THE CALCULATED LOAD ON THE DEVICE.
- 9. PROVIDE THE FOLLOWING CONCRETE CLASS: • CAST-IN-PLACE: CLASS A CEMENT CONCRETE [DESIGN COMPRESSIVE STRENGTH,
  - f'c = 21 MPa (3,000 PSI)• PRECAST: CLASS AA CEMENT CONCRETE, MODIFIED [DESIGN COMPRESSIVE STRENGTH
- f'c = 28 MPa (4,000 PSI)]10.A HIGHER STRENGTH OF CONCRETE MAY BE SUBSTITUTED FOR A LOWER STRENGTH OF CONCRETE AT NO ADDITIONAL COST TO THE DEPARTMENT. SUBMIT MIX DESIGN
- TO THE DEPARTMENT FOR REVIEW AND ACCEPTANCE. 11.PROVIDE GRADE 420 (GRADE 60) DEFORMED REINFORCEMENT BARS THAT MEET THE
- REQUIREMENTS OF ASTM A615M (A615) OR ASTM A706M (A706). DO NOT WELD REINFORCEMENT BARS WITHOUT A PENNDOT APPROVED WELDING PROCEDURE.
- 12.CLEAR COVER FOR STEEL
  - PRECAST: 1 1/2 " • CAST-IN-PLACE: 2"
- 13.PROVIDE STRUCTURAL STEEL (ANGLES AND PLATES) CONFORMING TO AASHTO M270M (M270) GRADE 250 (36) [ASTM A709M (A709), GRADE 250 (36)].
- 14.ANCHORING OF ANGLES AND PLATES: PROVIDE EITHER STUDS OR BENT BAR ANCHORS IN ACCORDANCE WITH THE INDICATED DETAILS.
  - STUDS: PROVIDE STUDS CONFORMING TO AASHTO M169 (ASTM A108).
  - WELD STUDS TO ANGLES OR PLATES.
  - BENT BAR ANCHORS: PROVIDE GRADE 420 (GRADE 60) DEFORMED REINFORCEMENT BARS THAT MEET THE REQUIREMENTS OF ASTM A615M (A615) OR
- ASTM A706M (A706). WELD BARS TO ANGLES OR PLATES USING A PENNDOT APPROVED WELDING PROCEDURE.
- 15.GALVANIZE PLATES, ANGLES AND STUDS OR BENT BAR ANCHORS (AFTER FABRICATION AND BEFORE INSTALLATION IN FORMS) IN ACCORDANCE WITH PUBLICATION 408, SECTION 1105.02(s).
- 16.CHAMFER EXPOSED CONCRETE EDGES 1/2 " x 1/2 ". EXCEPT AS NOTED. (CHAMFERS ARE NOT SHOWN ON THE DETAILS)
- 17.PRECAST TOP UNITS: TAPERS MAY BE PROVIDED ON THE INSIDE AND/OR OUTSIDE VERTICAL FACES OF THE INLET TOPS TO FACILITATE FORM STRIPPING. TAPERS MAY RESULT IN BOTTOM DIMENSIONS THAT VARY TO A MAXIMUM 1 1/2 ".
- 18.REHABILITATION PROJECTS: THE CONCRETE TOP UNITS DETAILED IN THIS STANDARD ARE PERMITTED TO BE USED ON EXISTING INLET BOXES IF THE SIZE OF THE EXISTING BOX CAN SUPPORT THE NEW TOP AND IF THE PROPER DEPTH CAN BE OBTAINED. IF MODIFICATIONS ARE REQUIRED, REFER TO THE CONTRACT DRAWINGS.



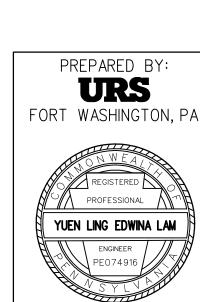

NO. DATE REVISIONS DRAINAGE DETAILS


AS NOTED

LIBERTY PROPERTY TRUST 180 SOUTH WARNER ROAD UPPER MERION TOWNSHIP, MONTGOMERY COUNTY, PENNSYLVANIA

URS CORPORATION Consulting Engineers 335 Commerce Drive · Suite 300 · Fort Washington · PA · 19034-2623

FIELD BOOK (215) 367-2500 · Fax (215) 367-1000 21386989 SHEET NO. CHECKED BY DRAWN BY SML 16 OF 38

21386989

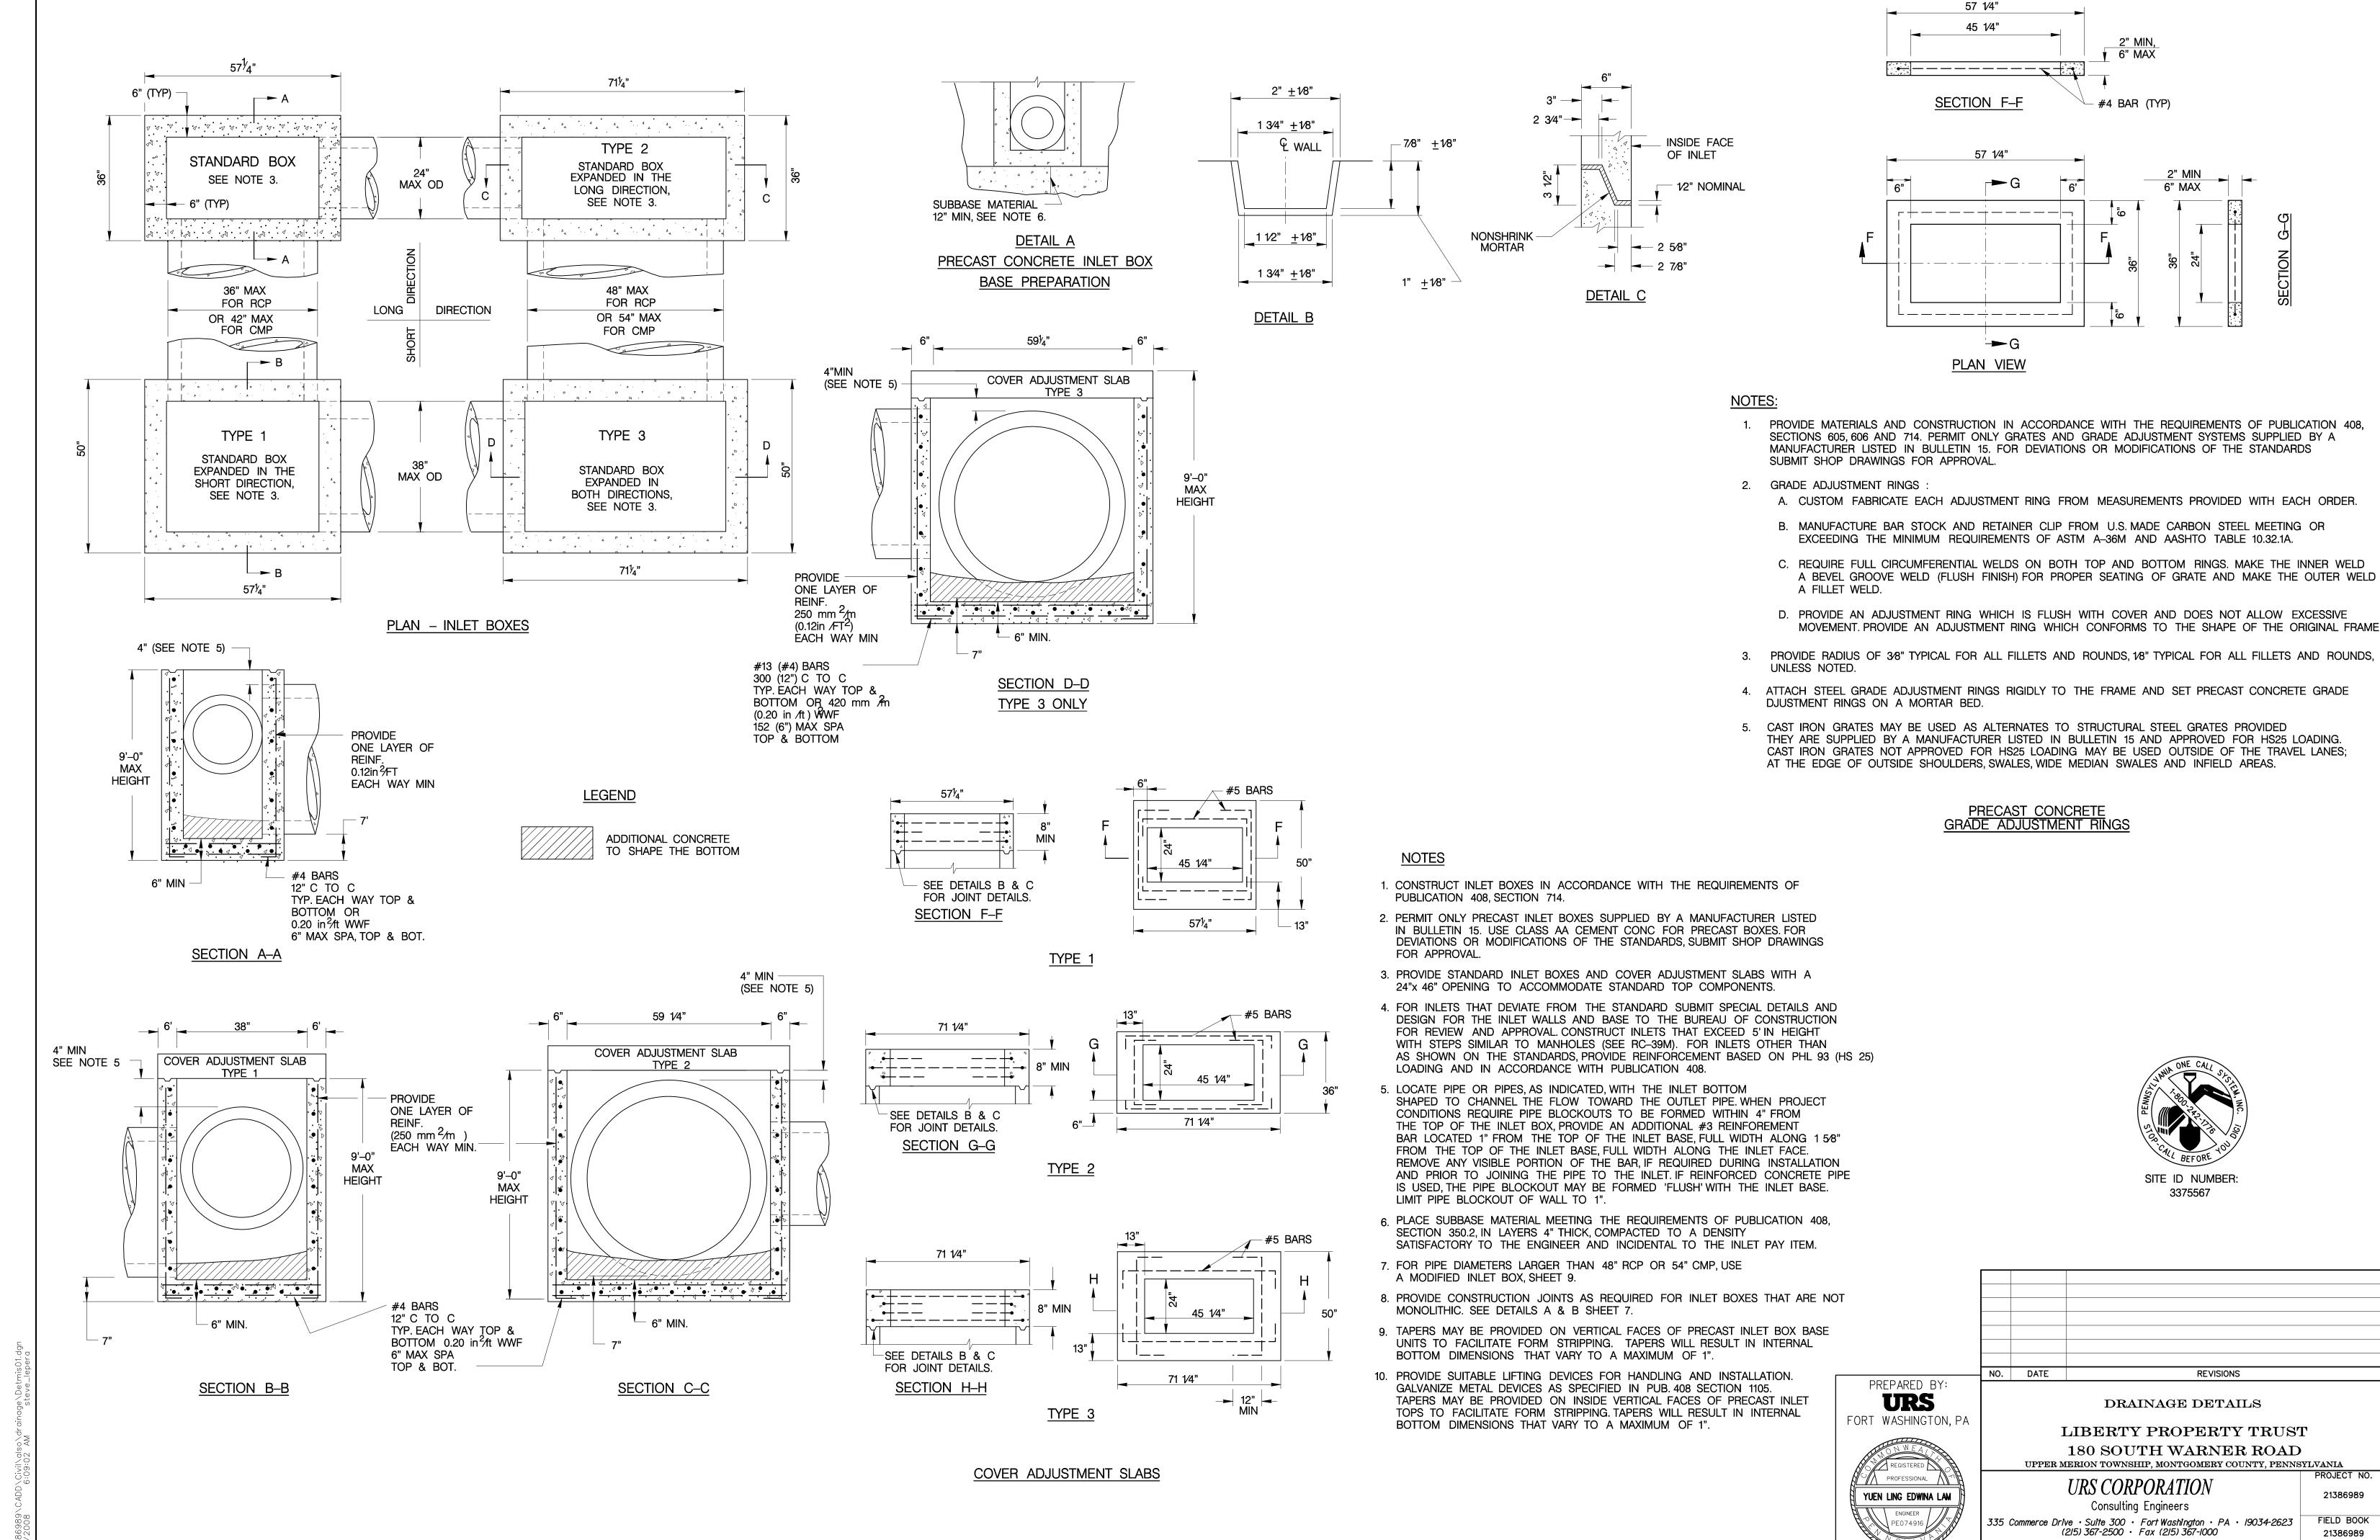

SHEET NO.


17 OF 38

DRAWN BY

SML

AS NOTED

CHECKED BY

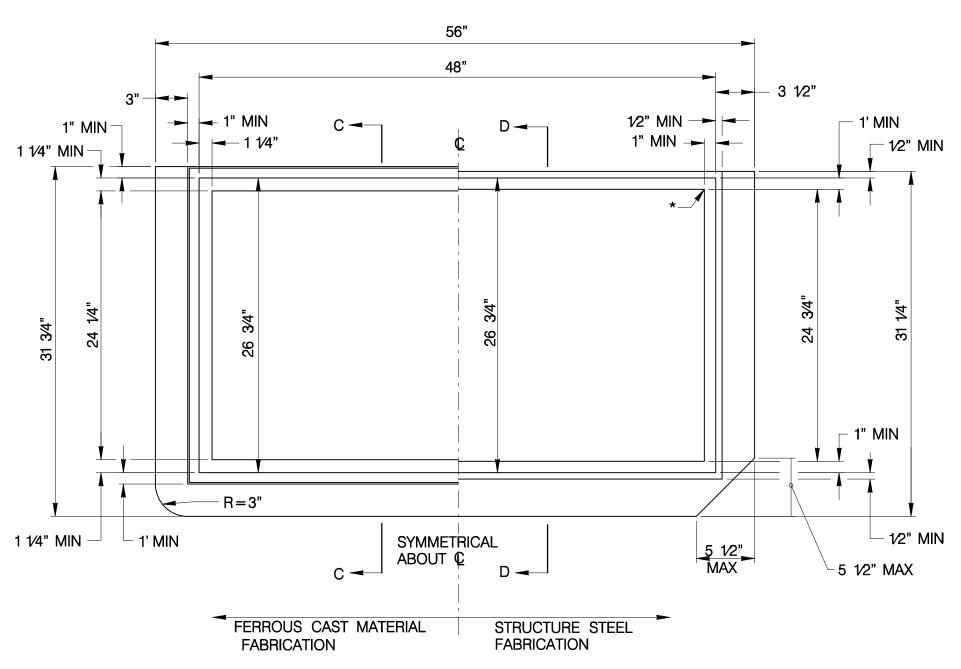

SECTION D-D
NOT TO SCALE

SECTION SEE DETAIL T-4.

SECTION C-C
NOT TO SCALE

2 1⁄2"


1/2' MIN

1 1/4' MIN

4' MIN

SECTION B-B NOT TO SCALE - SEE DETAIL T-3.

- SEE DETAIL T-1.

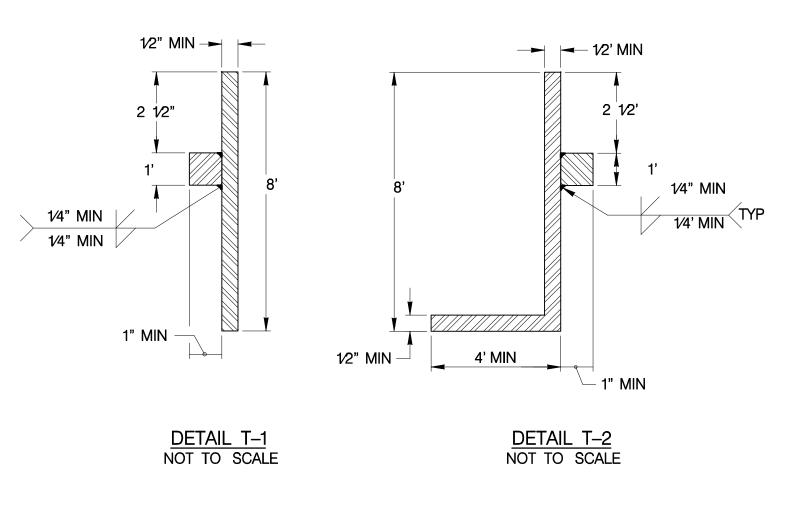

TYPE C FRAME

NOT TO SCALE

4" MIN ─────

1/2' MIN ---

3' MAX — -

1 1⁄4' MIN →

53 1⁄2"


5⁄8' MIN

─ 4' MIN

└─ 5⁄8' MIN

└─ 1 1⁄4' MIN

1 1/4' MIN -

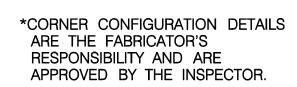

- 1⁄2' MIN

4' MIN -


4' MIN


└ 1 1⁄4' MIN


└─ 1/2" MIN

└─3" MAX

┌─ 1 1⁄4' MIN

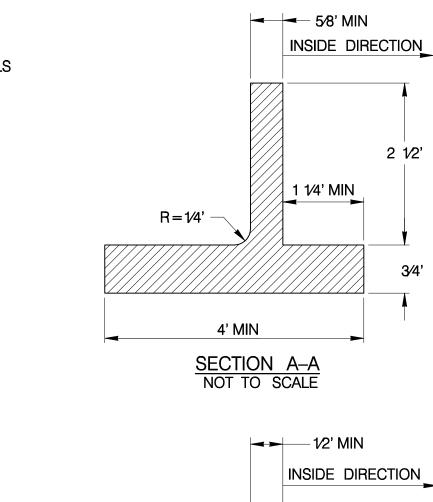

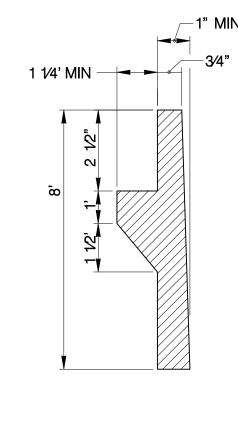

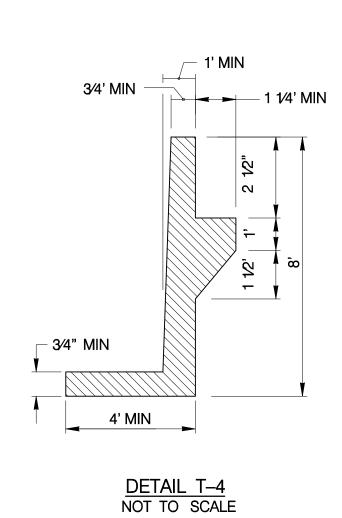



DETAIL T-3 NOT TO SCALE

NOTES:

- 1. THIS SHEET DEPICTS THE DIMENSIONS REQUIRED FOR UNIFORMITY AND INTERCHANGEABILITY. IT DOES NOT INCLUDE DETAILS REQUIRED FOR FABRICATION OR MANUFACTURING. PERMIT ONLY FRAMES SUPPLIED BY A MANUFACTURER LISTED IN BULLETIN 15. FOR DEVIATIONS OR MODIFICATIONS OF THE STANDARDS SUBMIT SHOP DRAWINGS FOR APPROVAL.
- 2. PROVIDE EITHER GRAY, MALLEABLE OR DUCTILE IRON CASTINGS OR STRUCTURAL STEEL FRAMES.
- 3. WELD STRUCTURAL STEEL FRAMES IN ACCORDANCE WITH THE REQUIREMENTS OF PUBLICATION 408, SECTION 1105.03(r).



FERROUS CAST MATERIAL

**FABRICATION** 

SYMMETRICAL

STRUCTURE STEEL


**FABRICATION** 


ABOUT €

48"



3375567

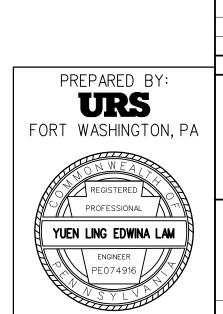

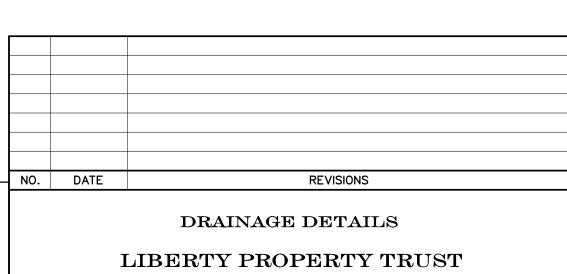

LIBERTY PROPERTY TRUST

180 SOUTH WARNER ROAD

UPPER MERION TOWNSHIP, MONTGOMERY COUNTY, PENNSYLVANIA

PROJECT NO

21386989


Consulting Engineers


Consulting Engineers

335 Commerce Drive · Suite 300 · Fort Washington · PA · 19034-2623
(215) 367-2500 · Fax (215) 367-1000

SCALE
AS NOTED

CHECKED BY
SHEET NO.
18 OF 38

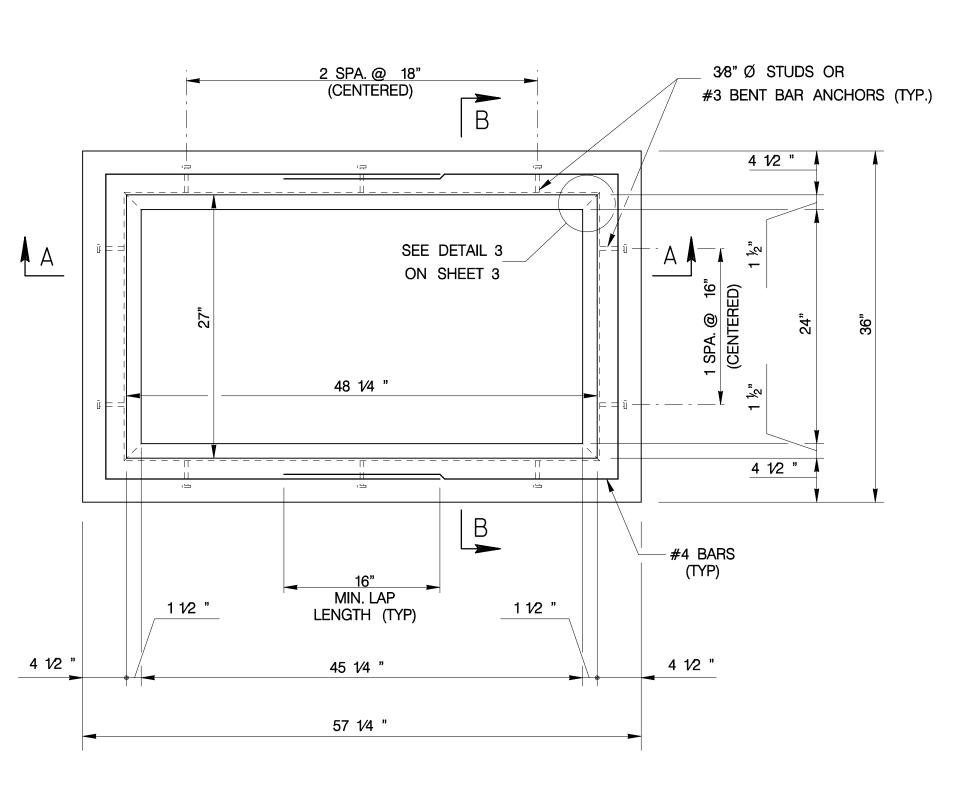


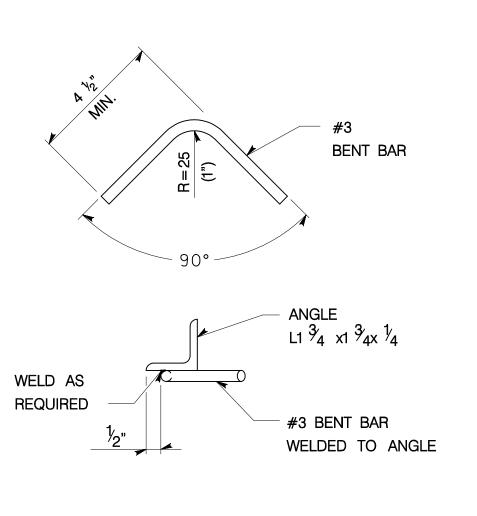


#3 BENT BAR ANCHOR DETAIL ATTACHED


TO ANGLE

ALTERNATE DETAIL IN PLACE OF PROVIDING \(^{9}\)<sub>8</sub> \(\varphi\) STUDS

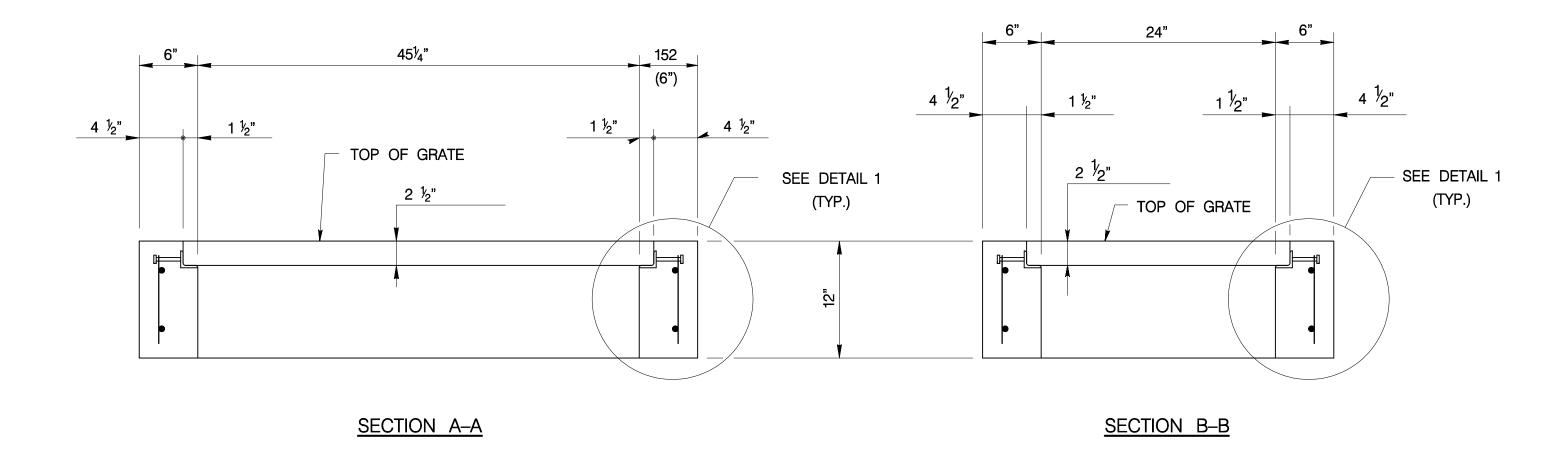


<u>PLAN VIEW - TYPE M</u>

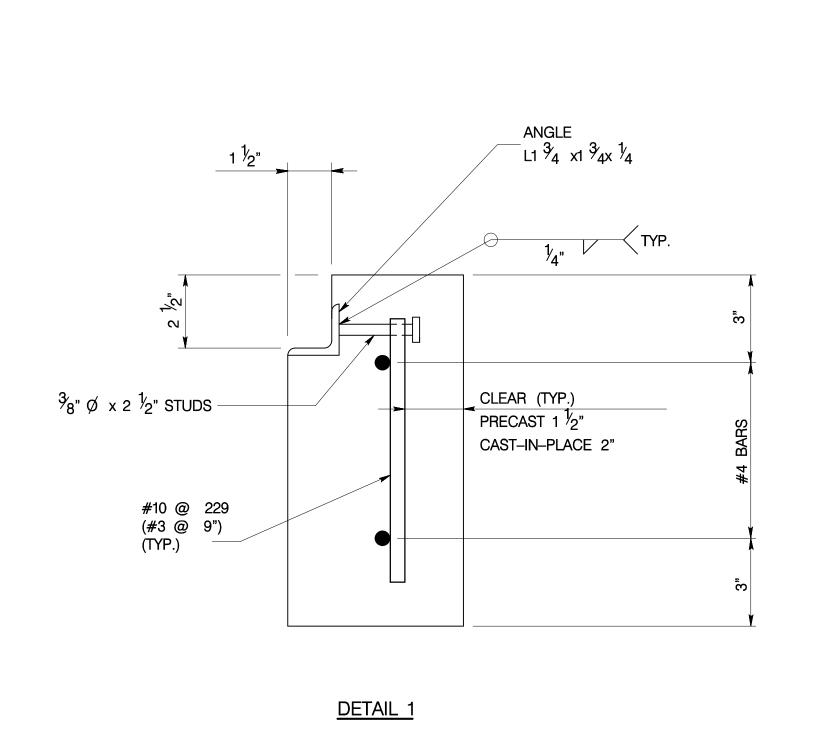

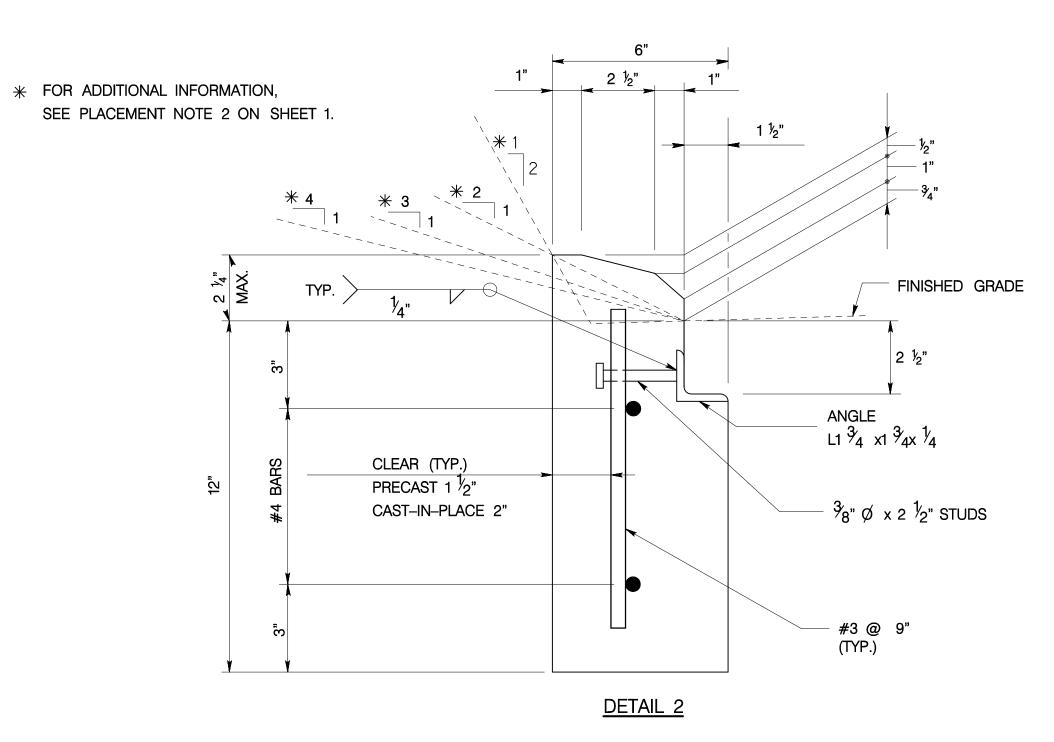





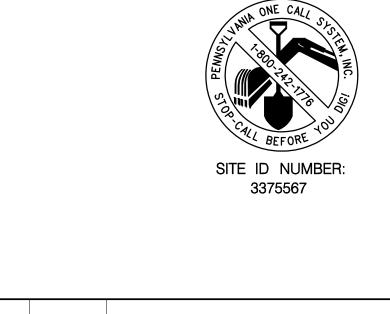


NO. DATE REVISIONS PREPARED BY: URS DRAINAGE DETAILS FORT WASHINGTON, PA LIBERTY PROPERTY TRUST 180 SOUTH WARNER ROAD
UPPER MERION TOWNSHIP, MONTGOMERY COUNTY, PENNSYLVANIA URS CORPORATION 21386989 YUEN LING EDWINA LAM Consulting Engineers 335 Commerce Drive • Suite 300 • Fort Washington • PA • 19034-2623 (215) 367-2500 • Fax (215) 367-1000 FIELD BOOK 21386989 SHEET NO. 19 OF 38 SCALE AS NOTED DRAWN BY CHECKED BY SML

:\21386989\CADD\Civil\also\drainage\Detmis01.dgn 2/30/2008 6:09:38 AM steve\_lepera

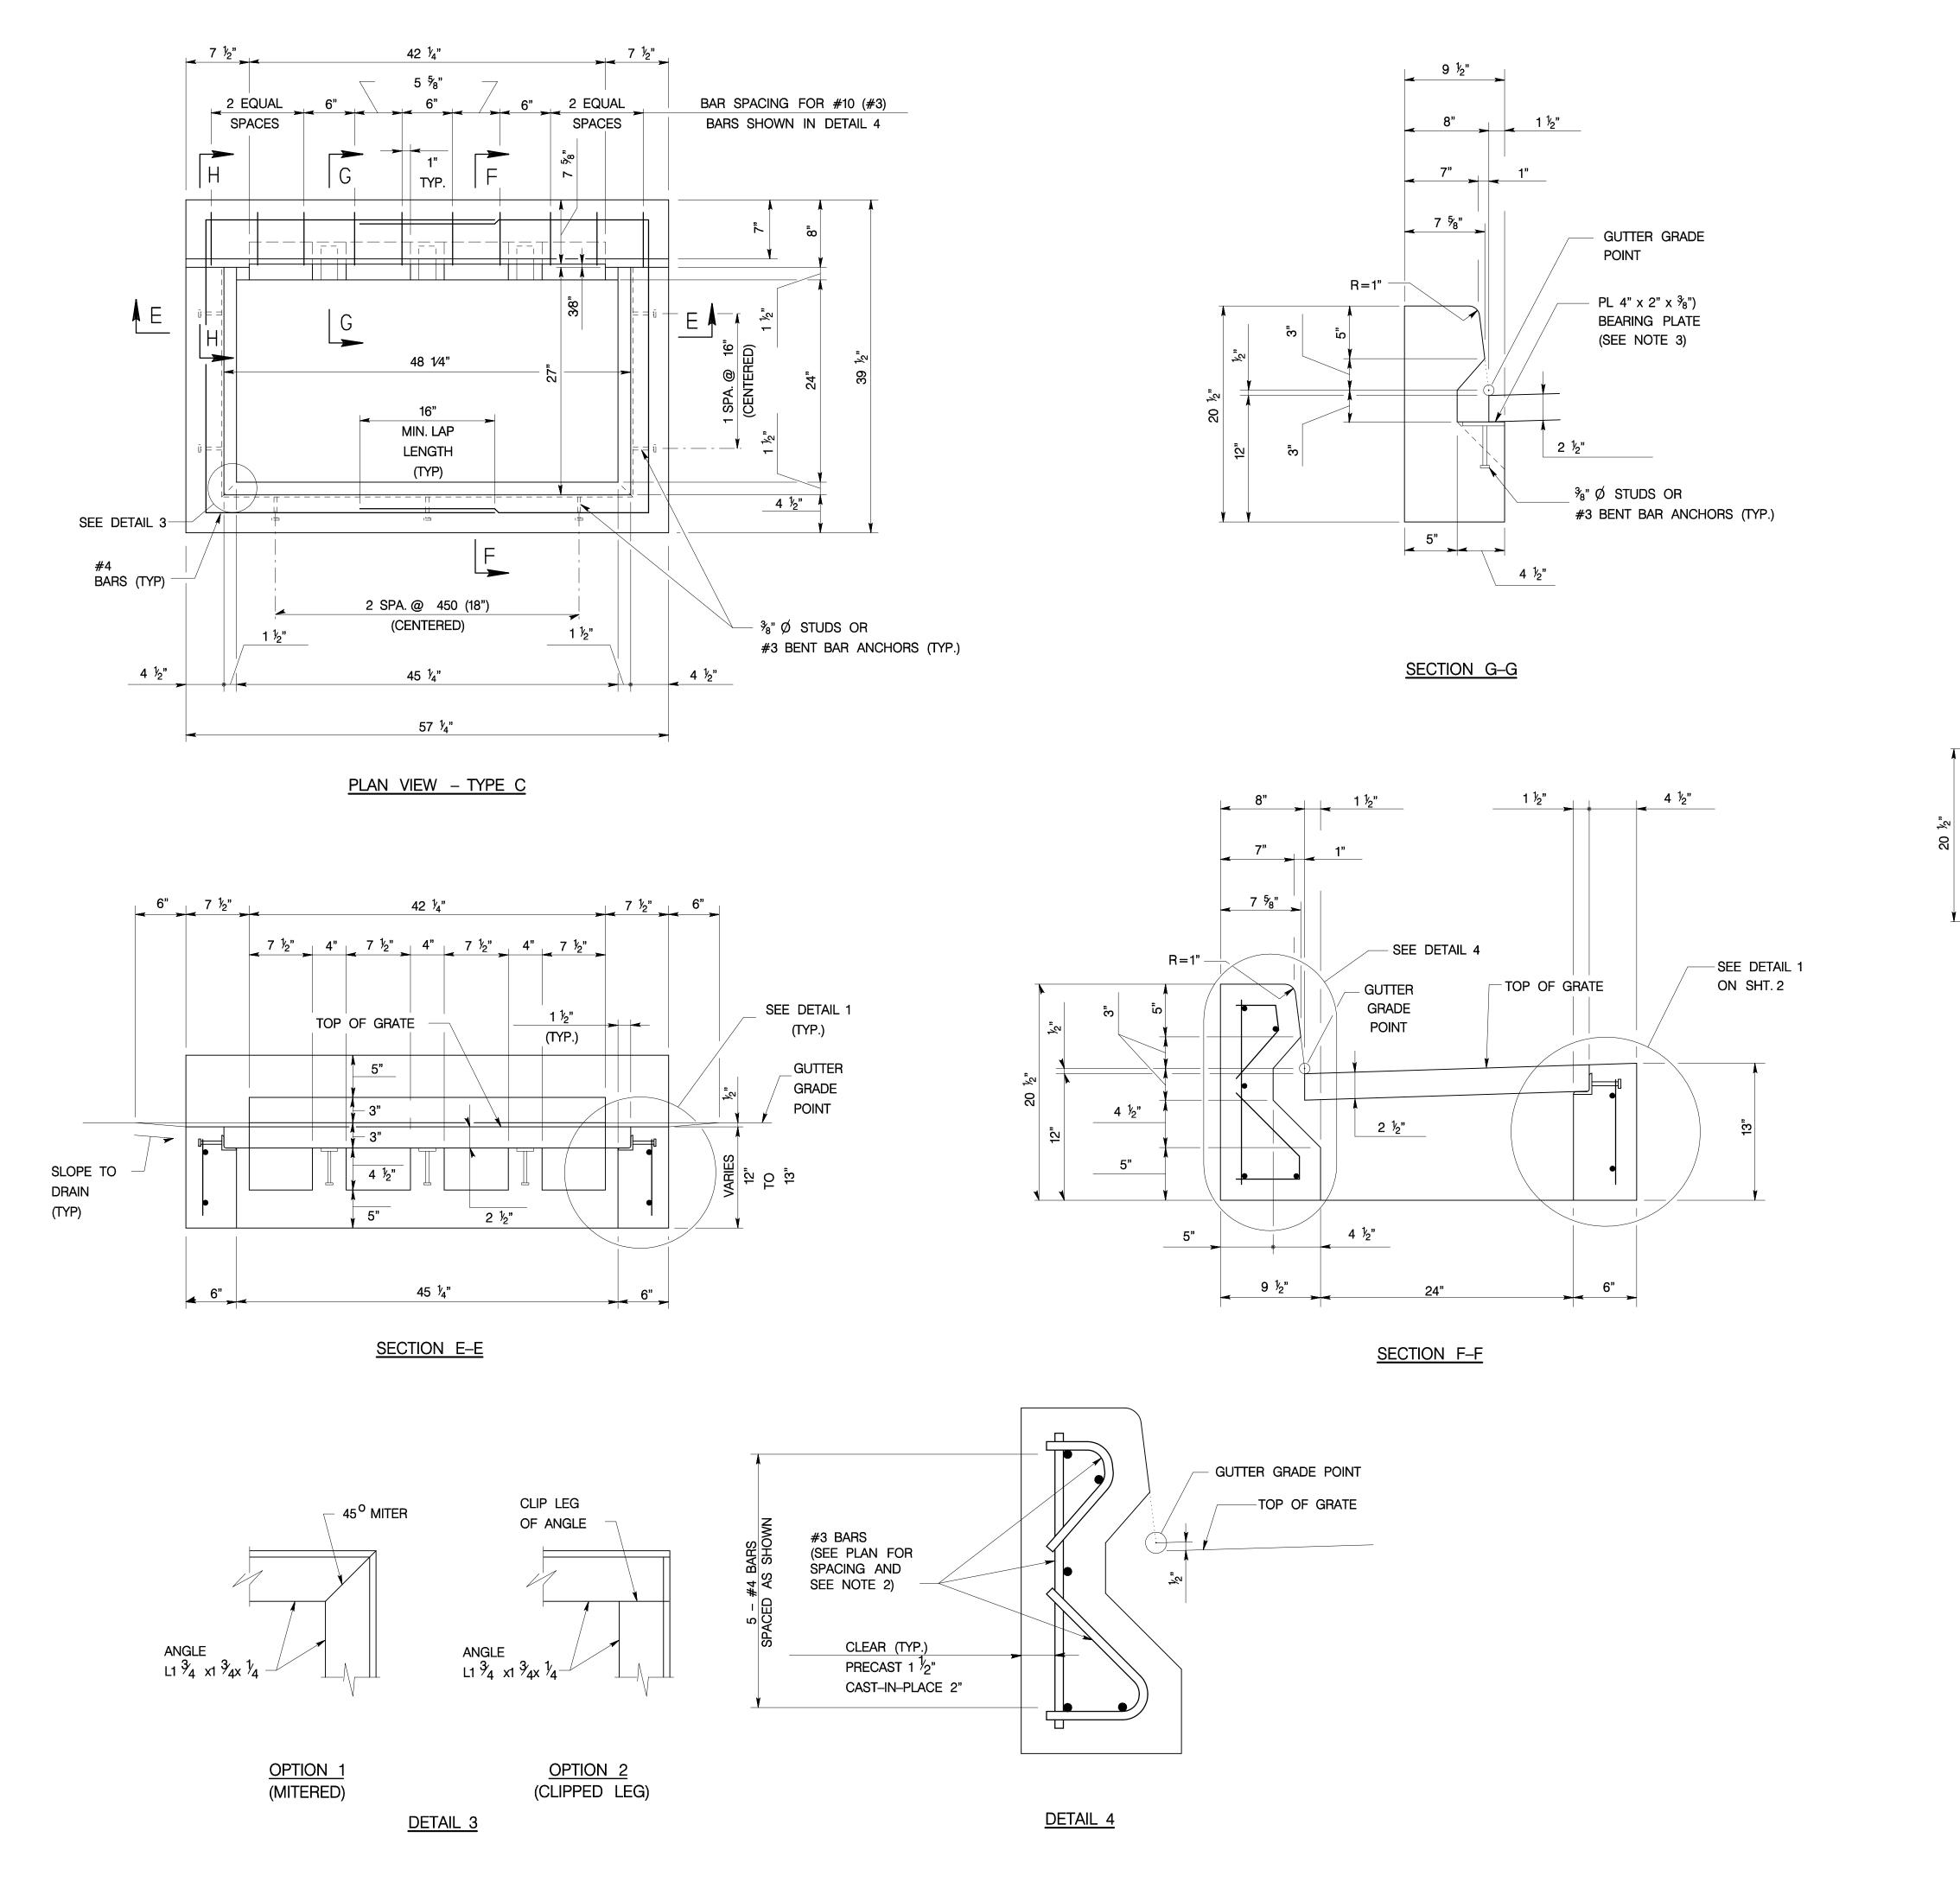

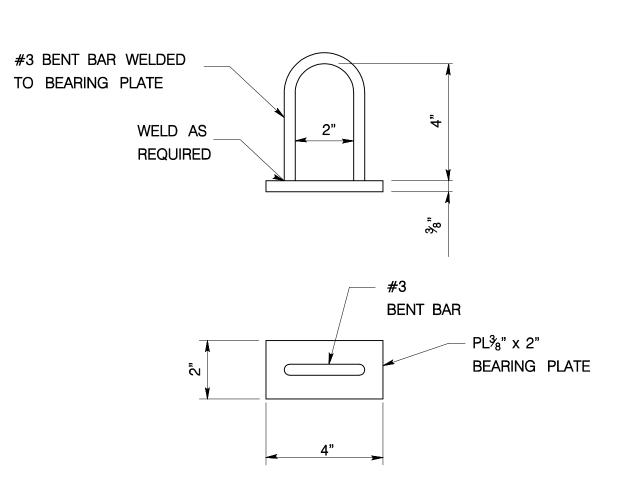

#10 (#3) BENT BAR ANCHOR
DETAIL ATTACHED
TO BEARING PLATE
ALTERNATE DETAIL IN PLACE OF
PROVIDING 9.5 (\*) | STUD%) | STUD

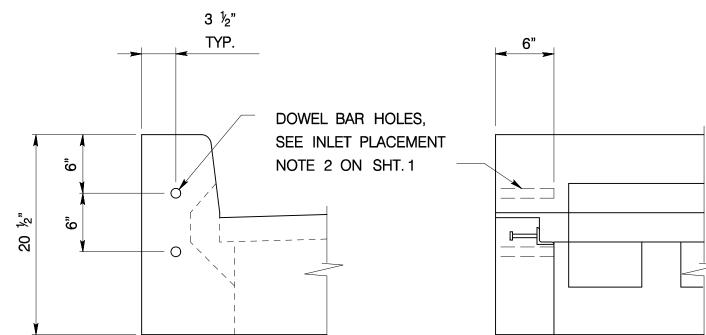

SECTION H-H


FRONT ELEVATION


## <u>NOTES</u>


- 1. FOR ADDITIONAL NOTES SEE SHEET 1.
- 2. FABRICATOR TO DETERMINE NUMBER OF BARS REQUIRED TO MATCH SHAPE INDICATED. PROVIDE ONE, TWO, OR THREE BARS AS REQUIRED.
- 3. A MAXIMUM OF TWO HOLES ARE PERMITTED IN THE PLATE TO POSITION AND HOLD THE PLATE IN PLACE DURING FABRICATION. HOLES ARE NOT PERMITTED TO BE GREATER THAN 1/4" DIAMETER.



NO. DATE REVISIONS PREPARED BY: **URS** DRAINAGE DETAILS FORT WASHINGTON, PA LIBERTY PROPERTY TRUST 180 SOUTH WARNER ROAD UPPER MERION TOWNSHIP, MONTGOMERY COUNTY, PENNSYLVANIA URS CORPORATION 21386989 Consulting Engineers FIELD BOOK 335 Commerce Drive • Suite 300 • Fort Washington • PA • 19034-2623 (215) 367-2500 • Fax (215) 367-1000 21386989 SHEET NO. 20 OF 38 DRAWN BY CHECKED BY AS NOTED SML

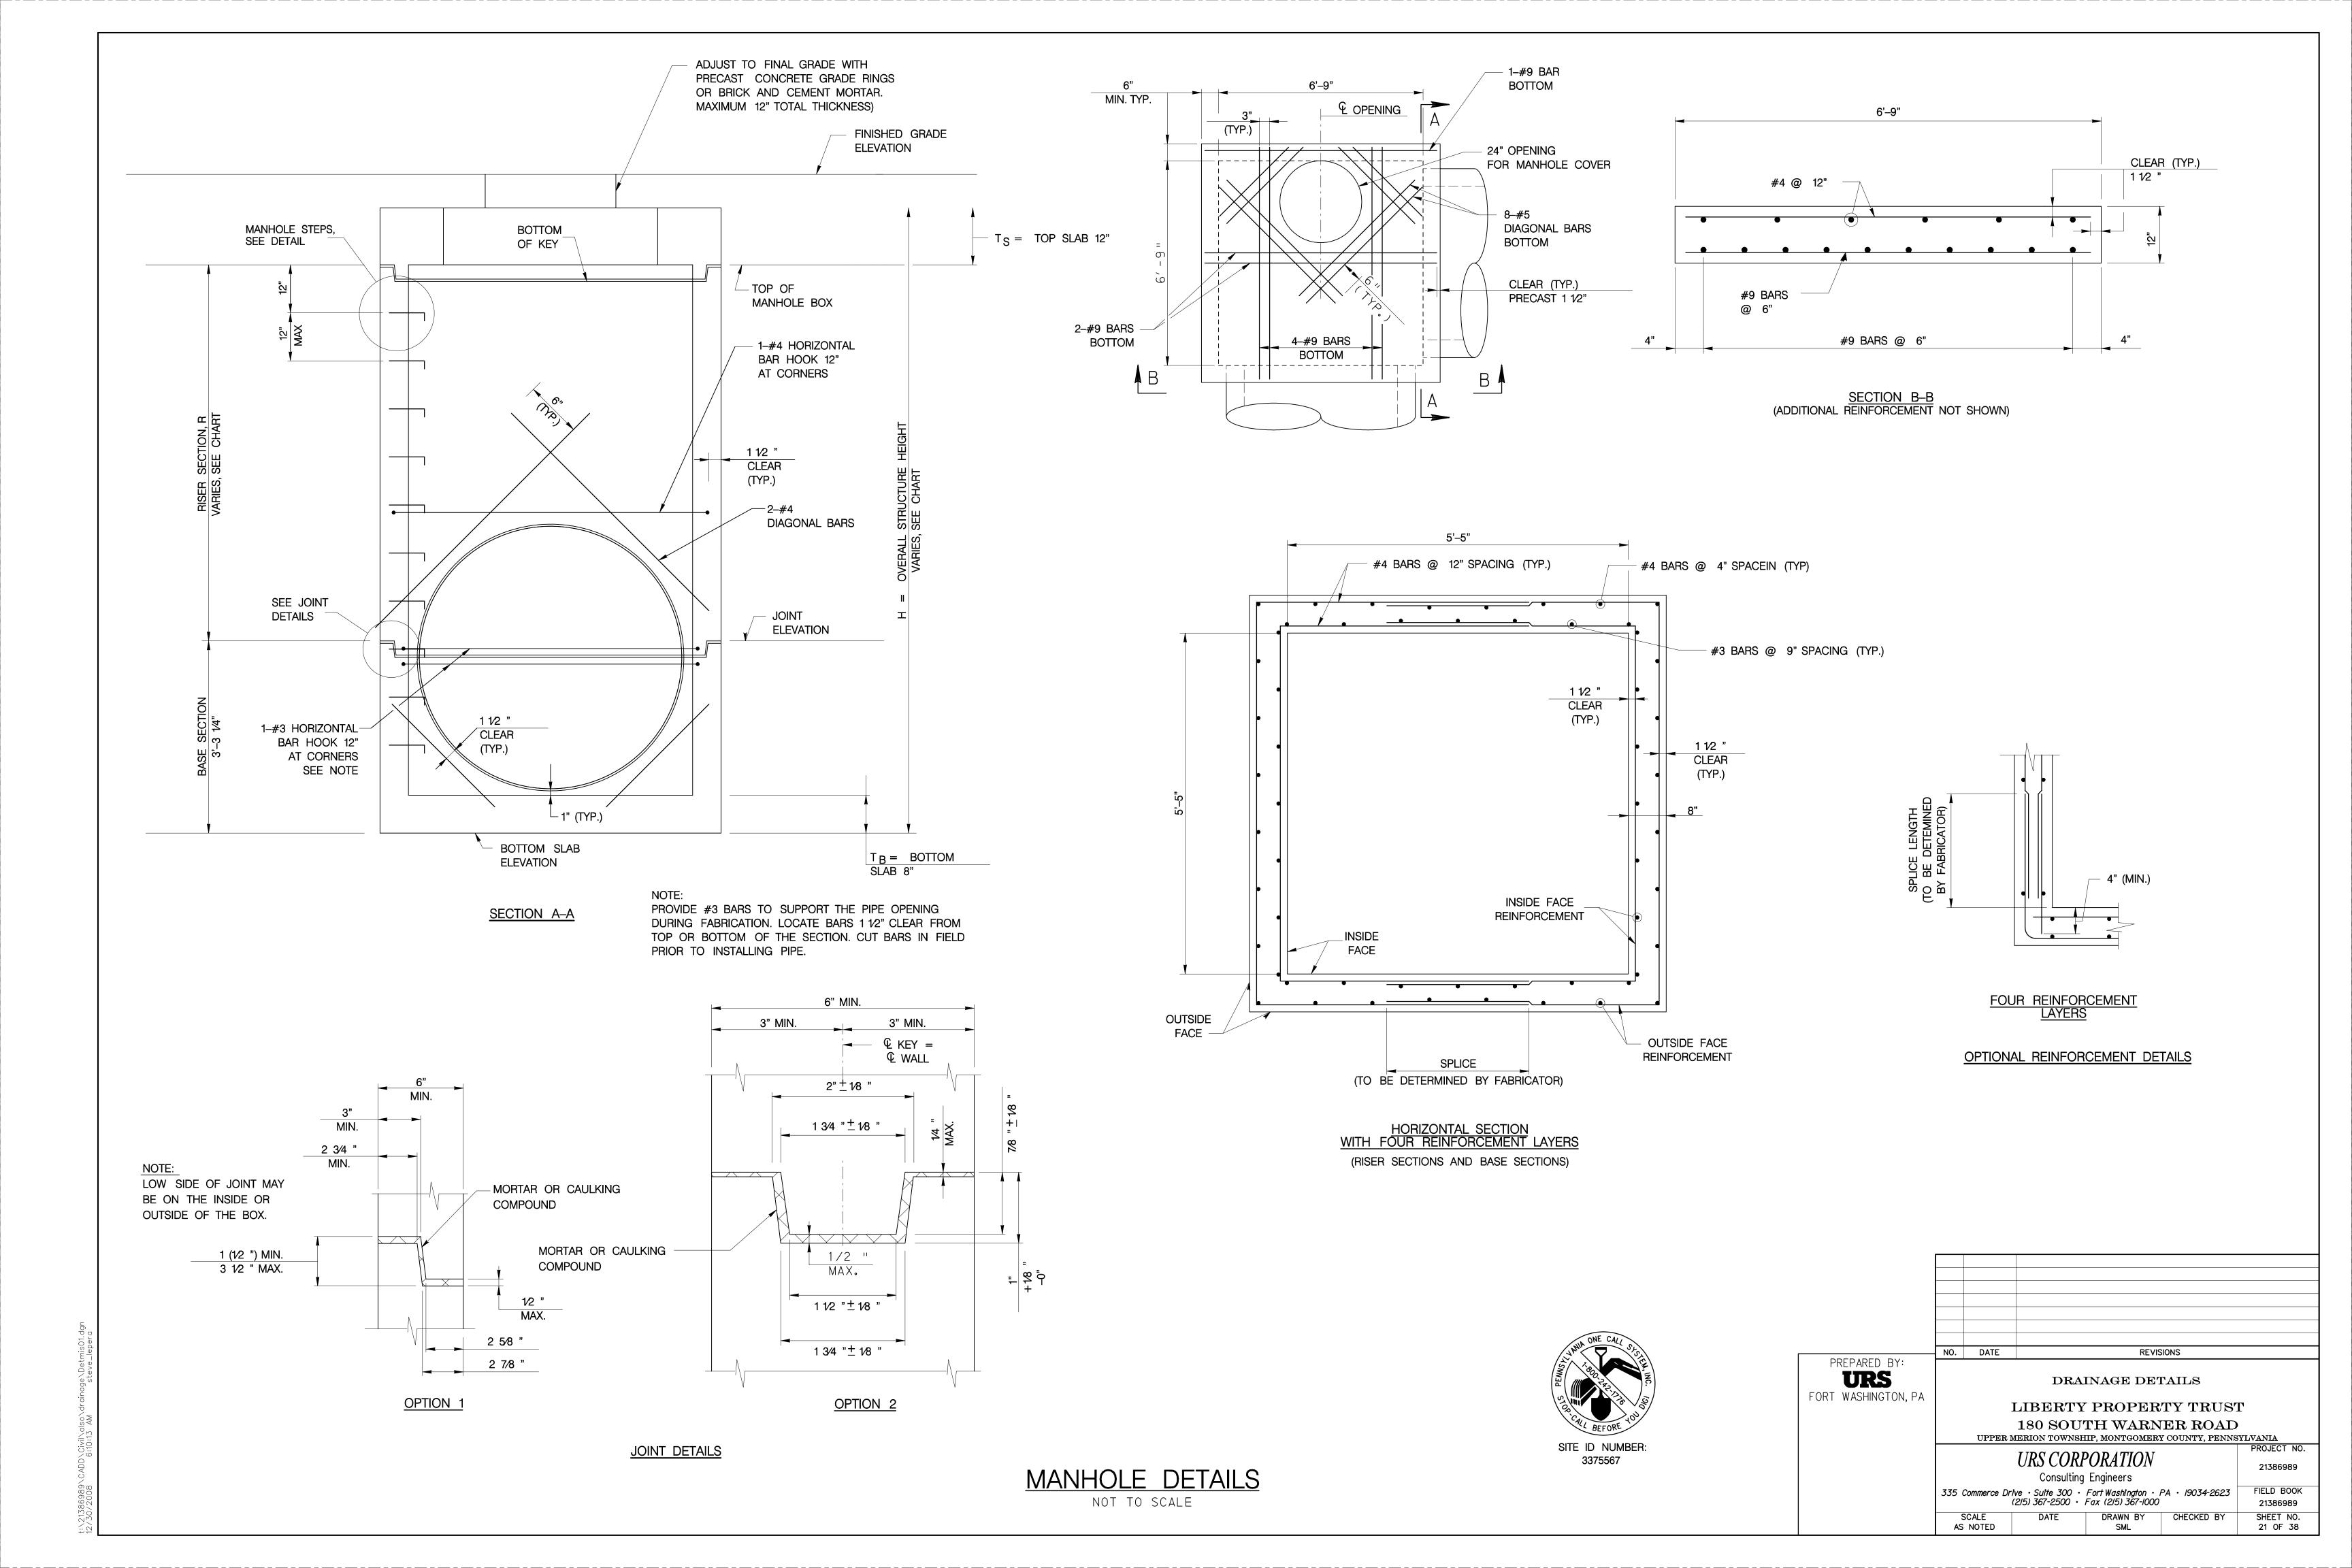

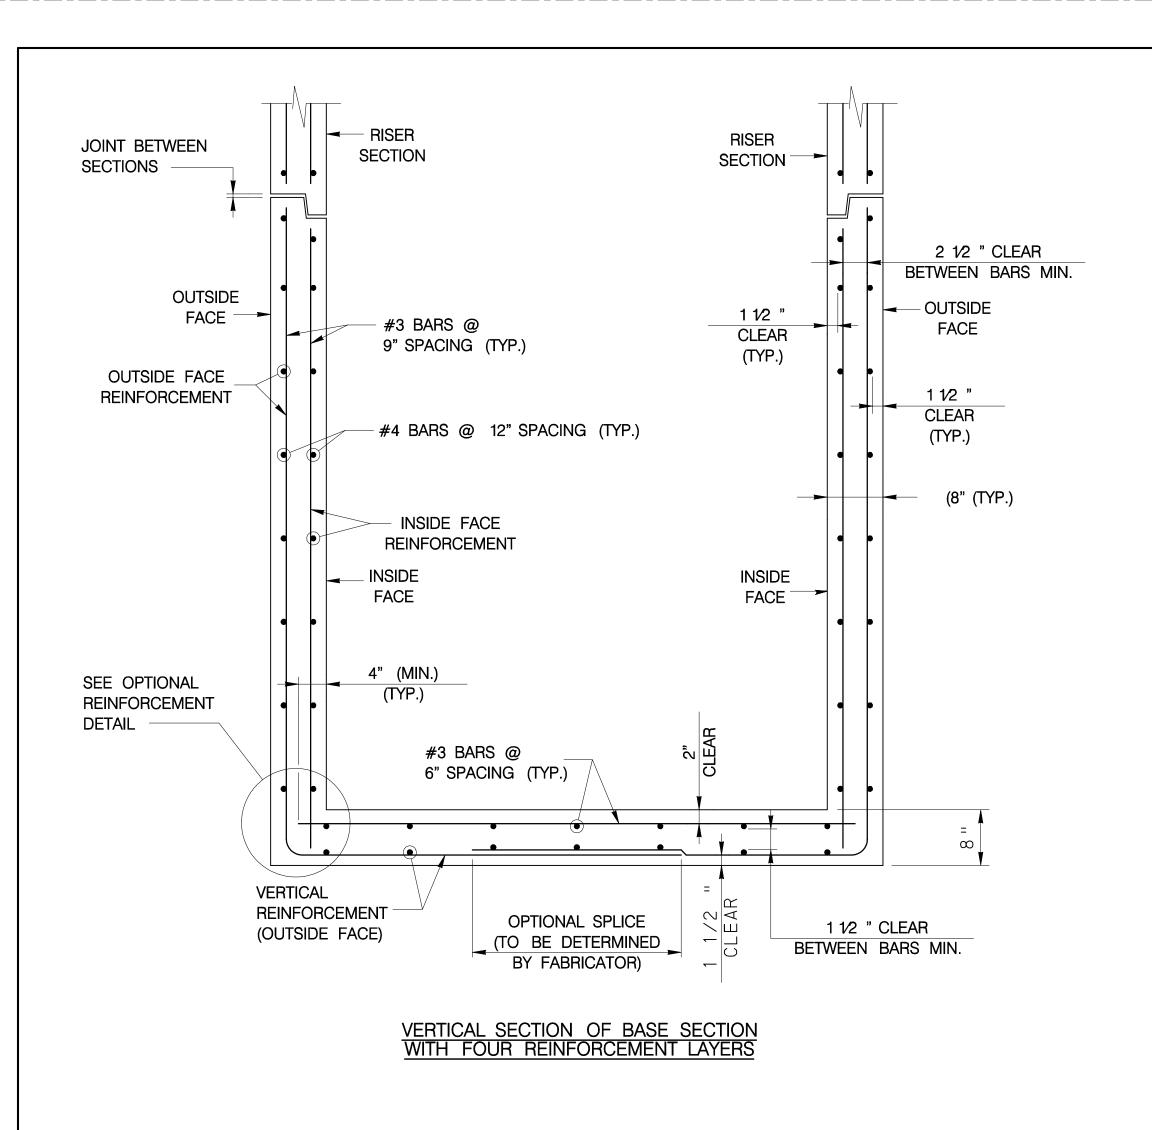

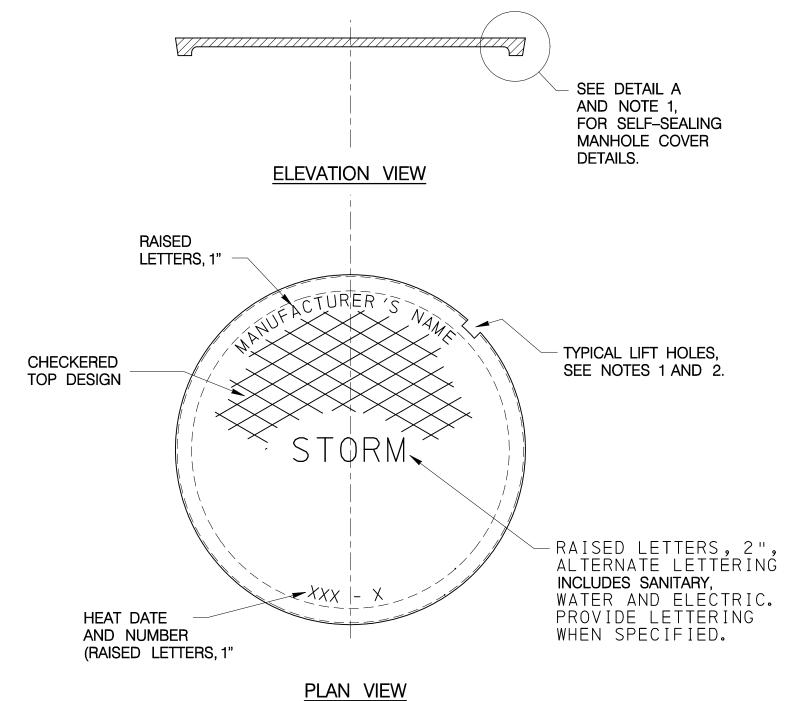

## CAST IRON MANHOLE COVER

1. PROVIDE A GASKET SEALING SYSTEM, DOVETAIL GROOVE AND CONTINUOUS GASKET, AS INDICATED IN DETAIL A, TO PREVENT INFLOW THROUGH THE BEARING SURFACES, OF SURFACE RUNOFF WATER INTO THE MANHOLE SYSTEM, WHEN SPECIFIED. PROVIDE 1/4 " DIA ONE PIECE SELF-SEAL POLYISOPRENE ROUND GASKET, 40 DUROMETER GLUED IN PLACE. PROVIDE TWO (2) LIFT HOLES AT 180 DEGREE TO FACILITATE COVER REMOVAL FÓR SELF-SEALING MANHOLE COVER.

2. PROVIDE ONE LIFT HOLE TO FACILITATE COVER REMOVAL FOR


NON-SEALING MANHOLE COVER.

STRUCTURE	TYPE	RIM ELEV	INVERT IN	INVERT OUT	RISER SECTION, R (FT)	OVERALL HEIGHT, H (FT)
A06	MANHOLE, TYPE 6 BOX	202.51	194.28 (A05) 191.83 (A07)	191.83	6.66	11.43
A07	MANHOLE, TYPE 6 BOX	202.61	<del>-</del>	192.03	6.56	11.33
A09	MANHOLE, TYPE 6 BOX	200.54	191.20 (A07) 193.70 (A08)	191.20	5.32	10.09
A10	MANHOLE, TYPE 6 BOX	200.13	191.04 (A03A) 191.00 (A06) 191.00 (A09)	191.00	5.11	9.88
A11 A	MANHOLE, SPECIAL, TYPE 6 BOX	199.90	189.97	189.97	5.91	10.68


▲ SEE BASIN OUTLET STRUCTURE A11 DETAIL FOR ADDITIONAL INFORMATION

## MANHOLE DETAILS


NOT TO SCALE

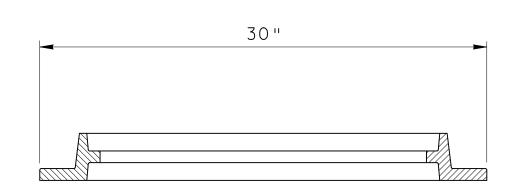


**ELEVATION VIEW** OF MANHOLE FRAME

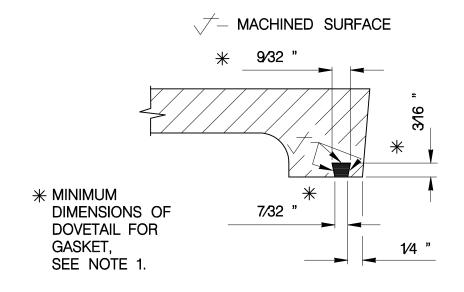


<u>DETAIL A</u> GASKET SEALING SYSTEM

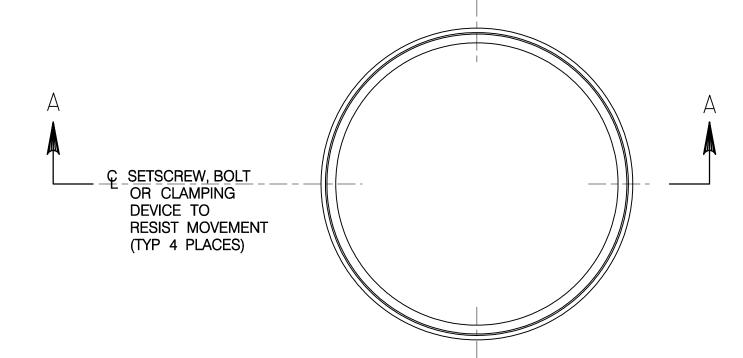

<u>PLAN VIEW</u> ONE PIECE ADJUSTMENT RISER

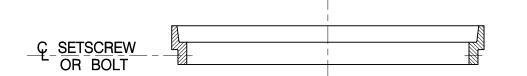

SECTION A-A ADJUSTMENT RISER

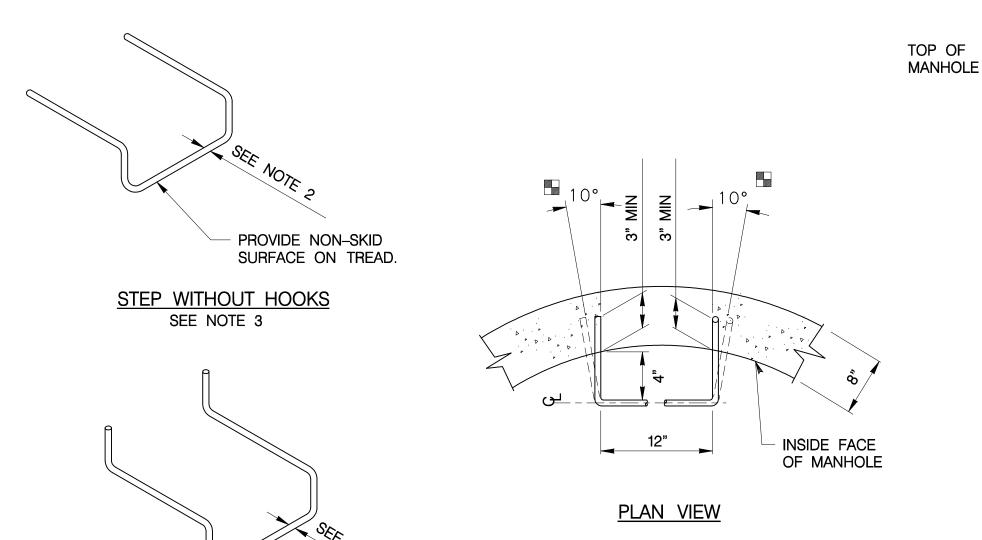

STEP WITH HOOKS

PROVIDE NON-SKID SURFACE ON TREAD.

# TYPICAL STEP CONFIGURATION MANHOLE STEPS

<u>NOTES</u>

1. PROVIDE MANHOLE STEPS MEETING TOWNSHIP REQUIREMENTS. ALTERNATE CONFIGURATIONS AND DIMENSIONS, AS APPROVED BY THE ENGINEER, MAY BE USED.

ALTERNATE ACCEPTABLE CONFIGURATION

2. PROVIDE MINIMUM 1" SECTION DIMENSION FOR METAL STEPS. PROVIDE MINIMUM 3/4 " SECTION DIMENSION FOR NON-DETERIORATING MATERIAL STEPS.

3. MECHANICAL ANCHOR REQUIRED FOR INSTALLATION OF STEPS WITHOUT HOOKS.



PREPARED BY: **URS** FORT WASHINGTON, PA

NO. DATE REVISIONS DRAINAGE DETAILS LIBERTY PROPERTY TRUST


180 SOUTH WARNER ROAD UPPER MERION TOWNSHIP, MONTGOMERY COUNTY, PENNSYLVANIA


INSIDE FACE OF MANHOLE


MIN


SIDE VIEW

URS CORPORATION 21386989 Consulting Engineers 335 Commerce Drive • Suite 300 • Fort Washington • PA • 19034-2623 (215) 367-2500 • Fax (215) 367-1000 FIELD BOOK 21386989 SHEET NO. 22 OF 38 SCALE AS NOTED DRAWN BY CHECKED BY

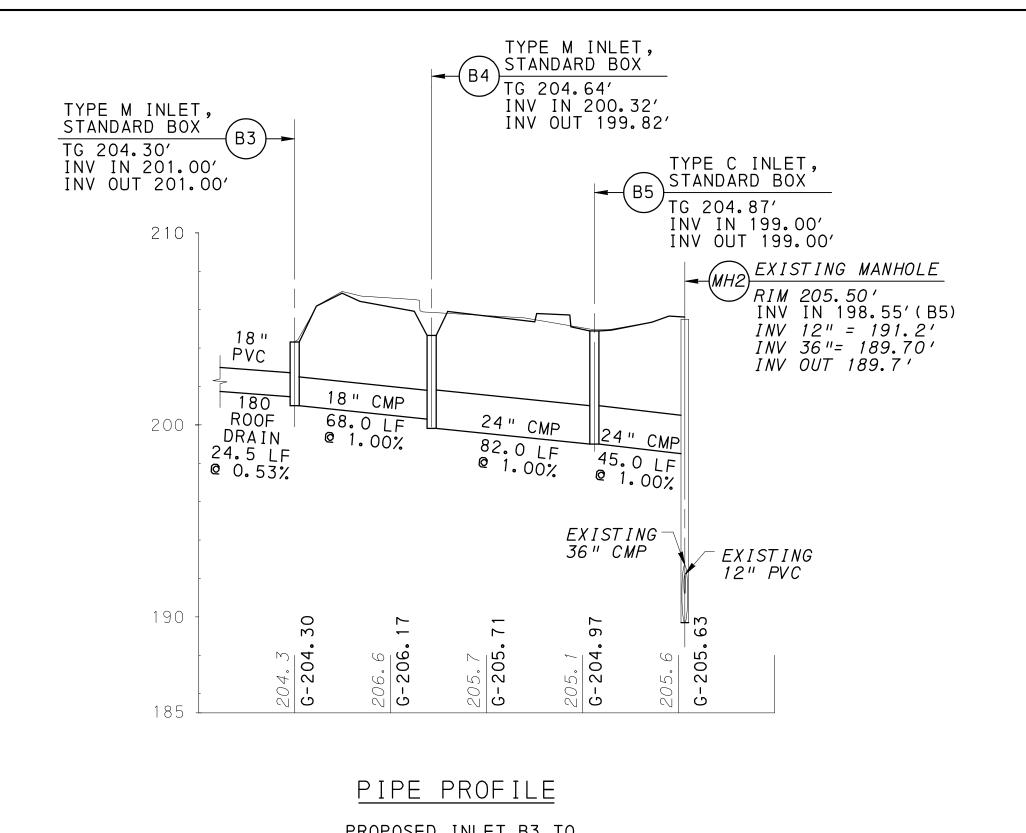

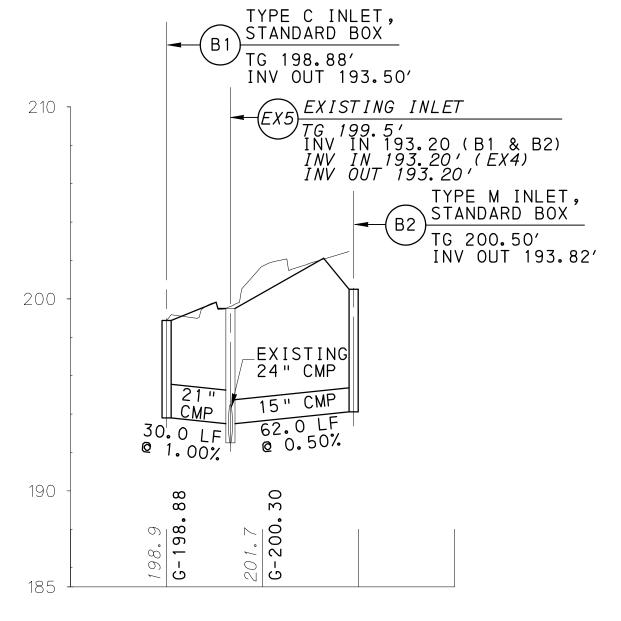

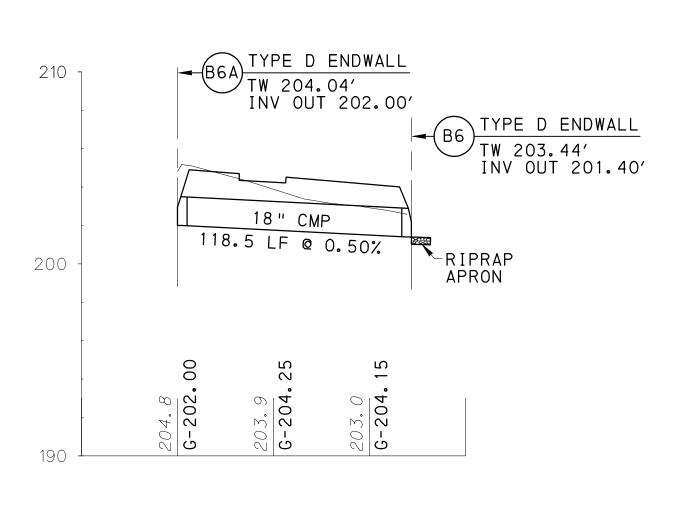

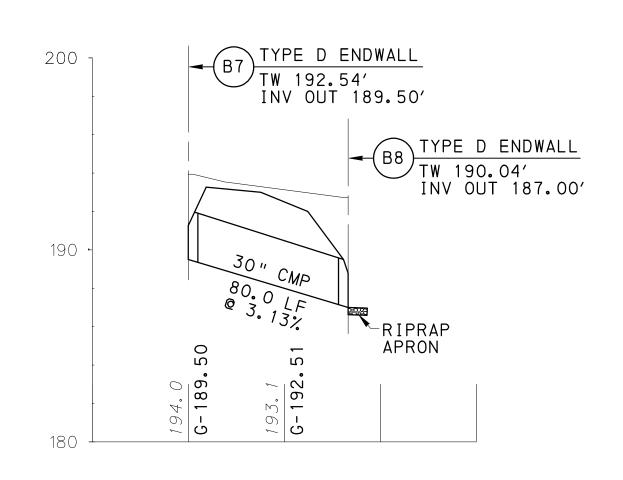



PROPOSED INLET B3 TO EXISTING MANHOLE MH2


PIPE PROFILE PROPOSED INLET B1 TO EXISTING INLET EX5 PROPOSED INLET B2 TO EXISTING INLET EX5

PIPE PROFILE PROPOSED INLET B6A TO ENDWALL B6

PIPE PROFILE PROPOSED INLET B7 TO ENDWALL B8

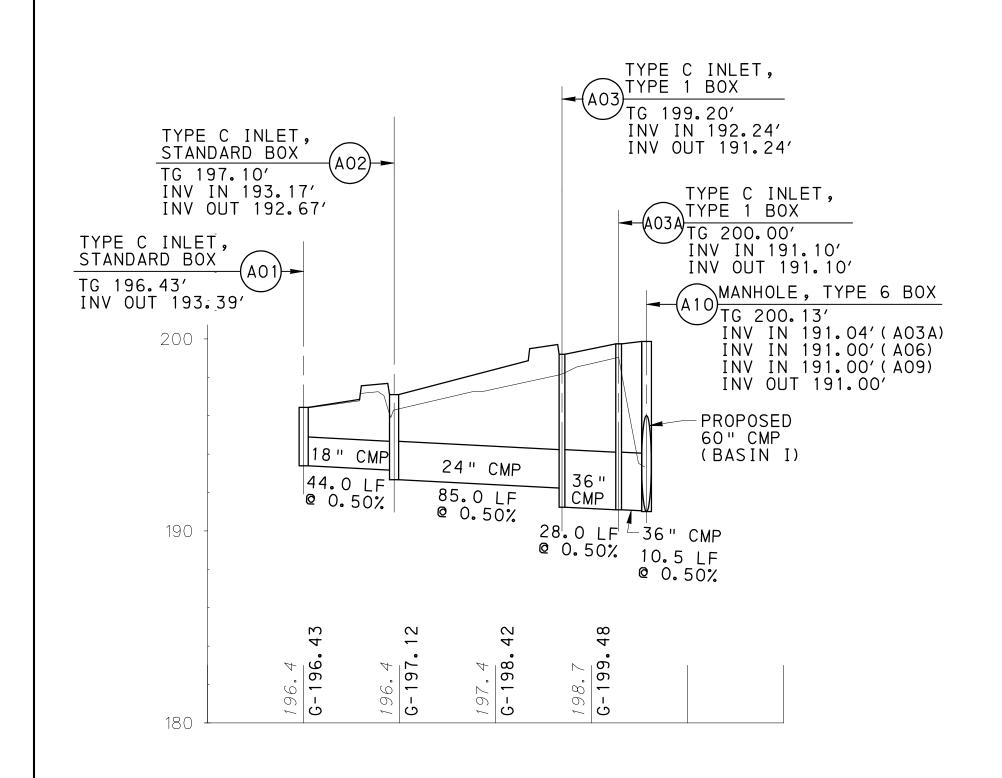

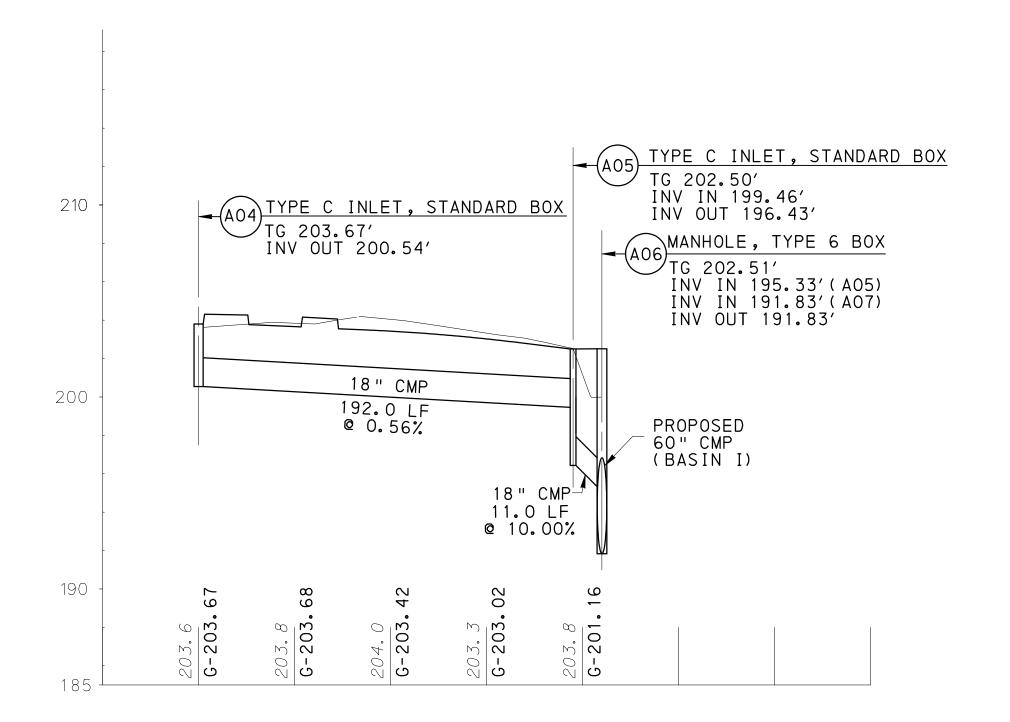

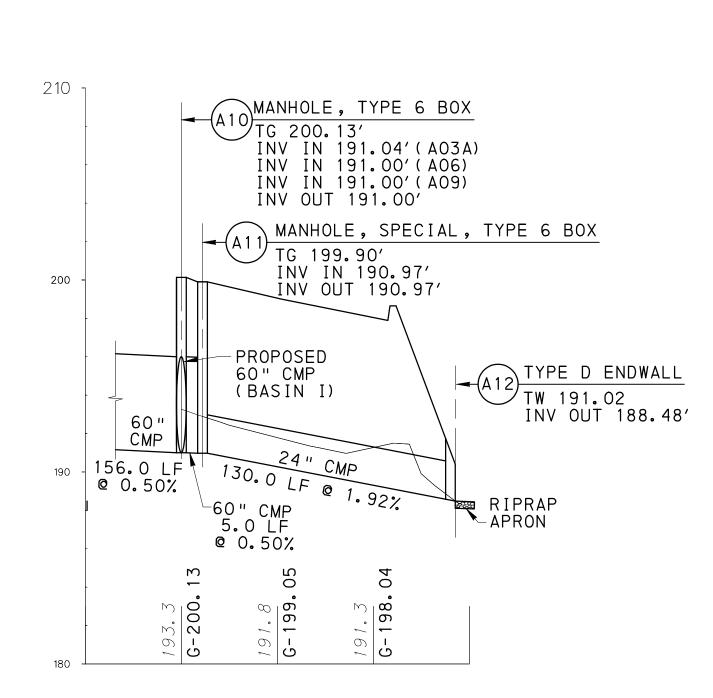

PIPE PROFILE


PROPOSED INLET A01 TO PROPOSED MANHOLE A10


PIPE PROFILE

PROPOSED INLET A04 TO PROPOSED MANHOLE A06

PIPE PROFILE


PROPOSED MANHOLE A10 TO PROPOSED ENDWALL A12

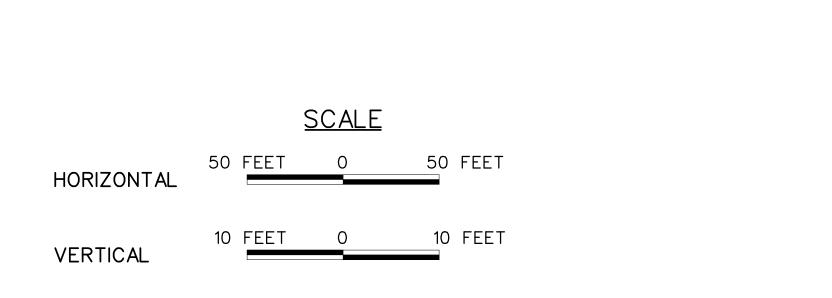


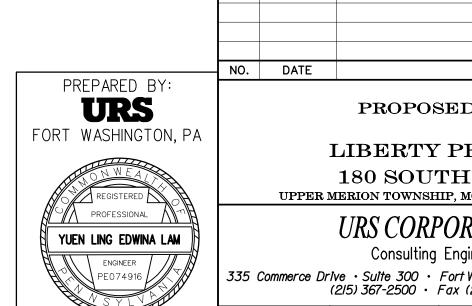


REVISIONS PROPOSED PIPE PROFILES LIBERTY PROPERTY TRUST 180 SOUTH WARNER ROAD UPPER MERION TOWNSHIP, MONTGOMERY COUNTY, PENNSYLVANIA


URS CORPORATION 21386989 Consulting Engineers 335 Commerce Drive · Suite 300 · Fort Washington · PA · 19034-2623 (215) 367-2500 · Fax (215) 367-1000 FIELD BOOK 21386989 SHEET NO. DRAWN BY CHECKED BY 17 OF 17 AS NOTED SML

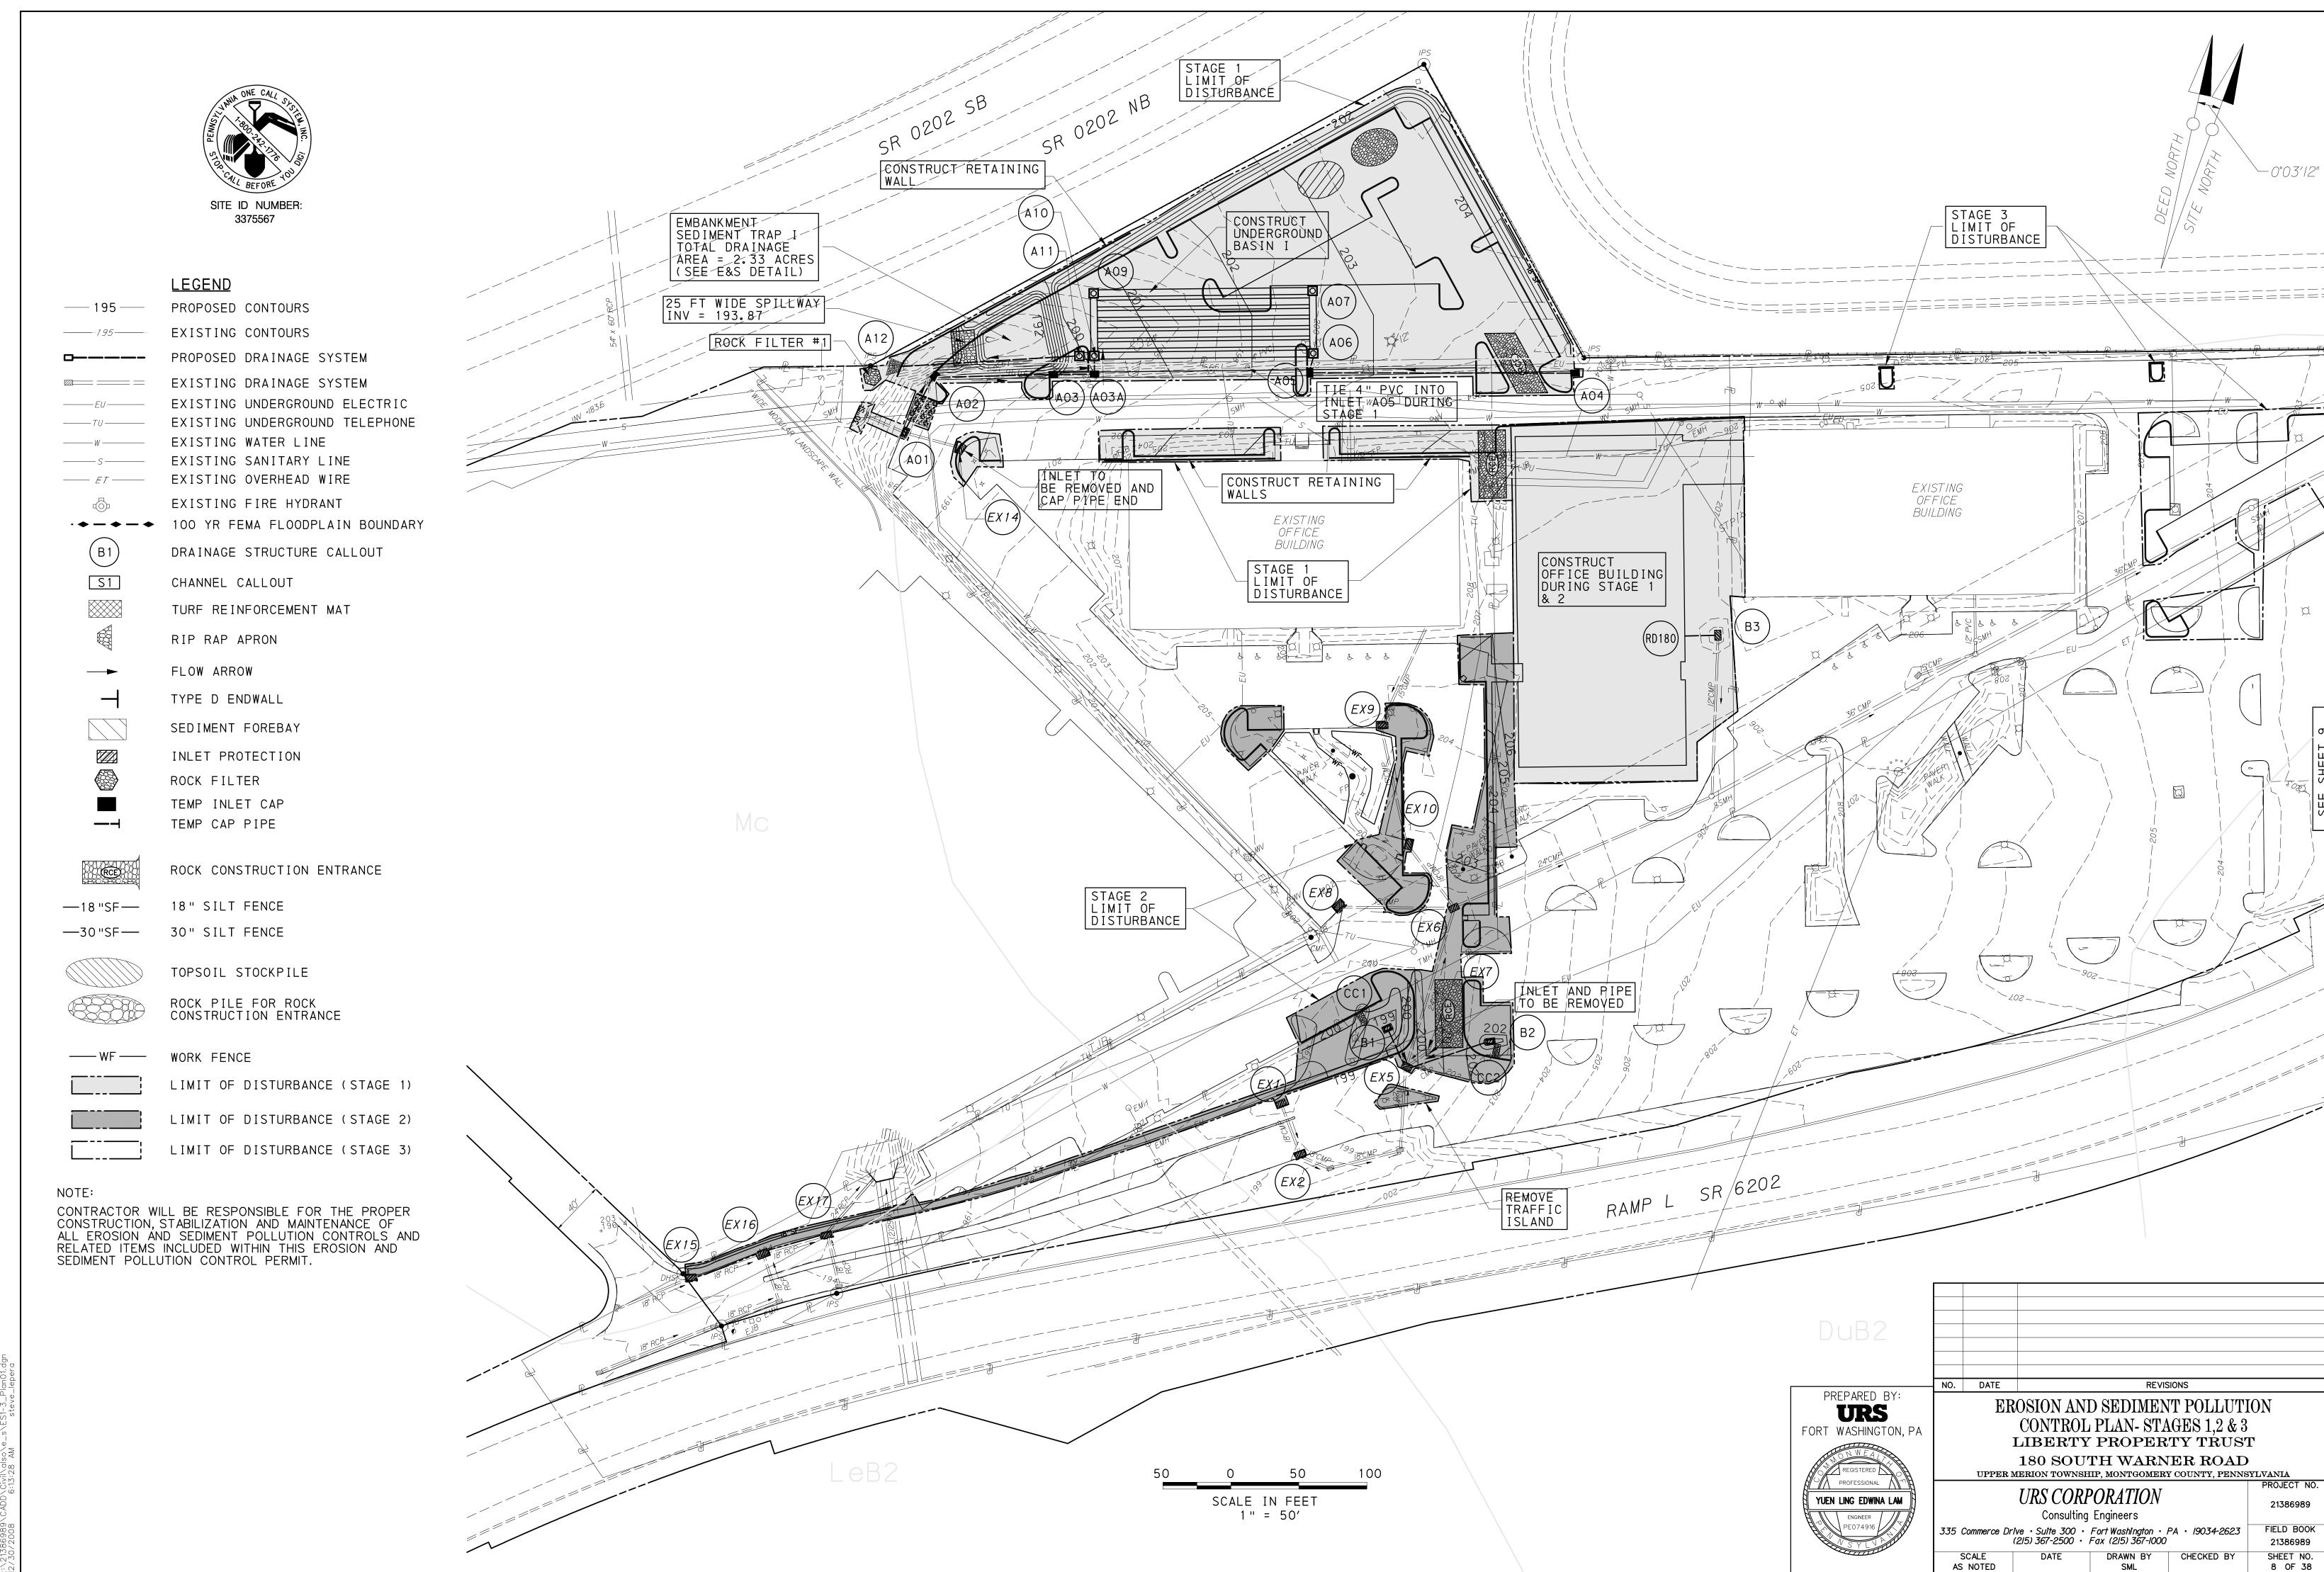

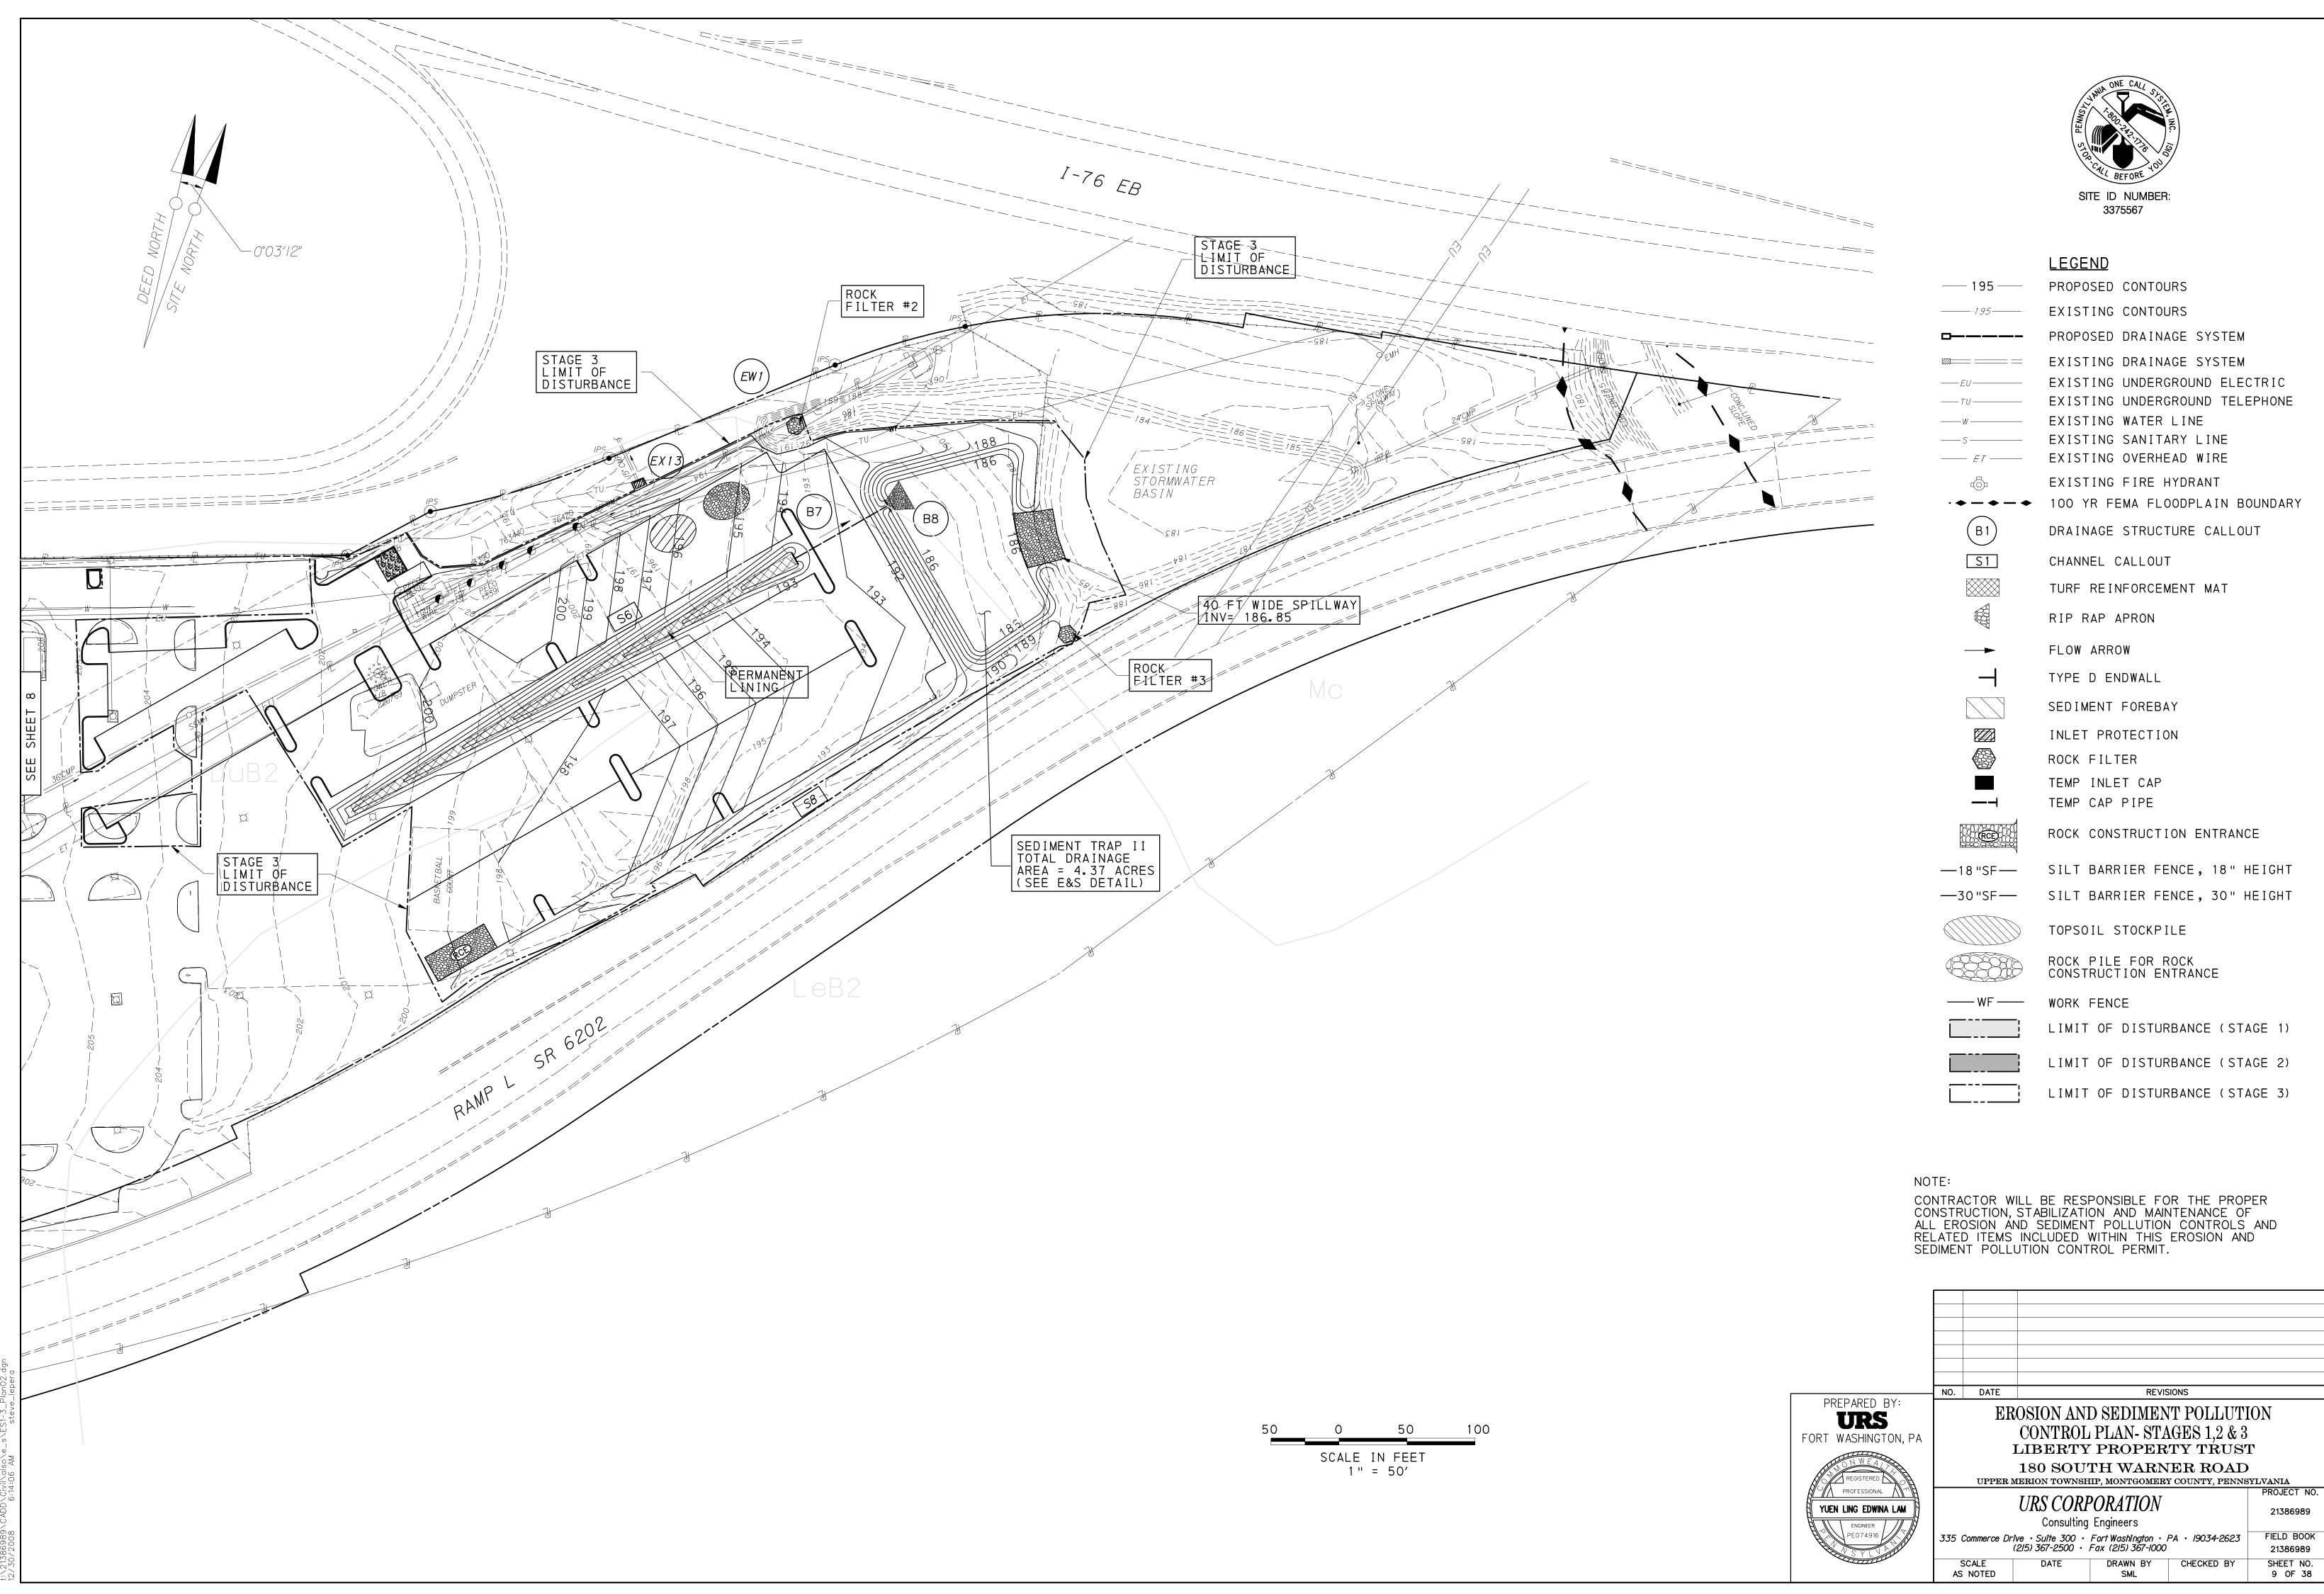

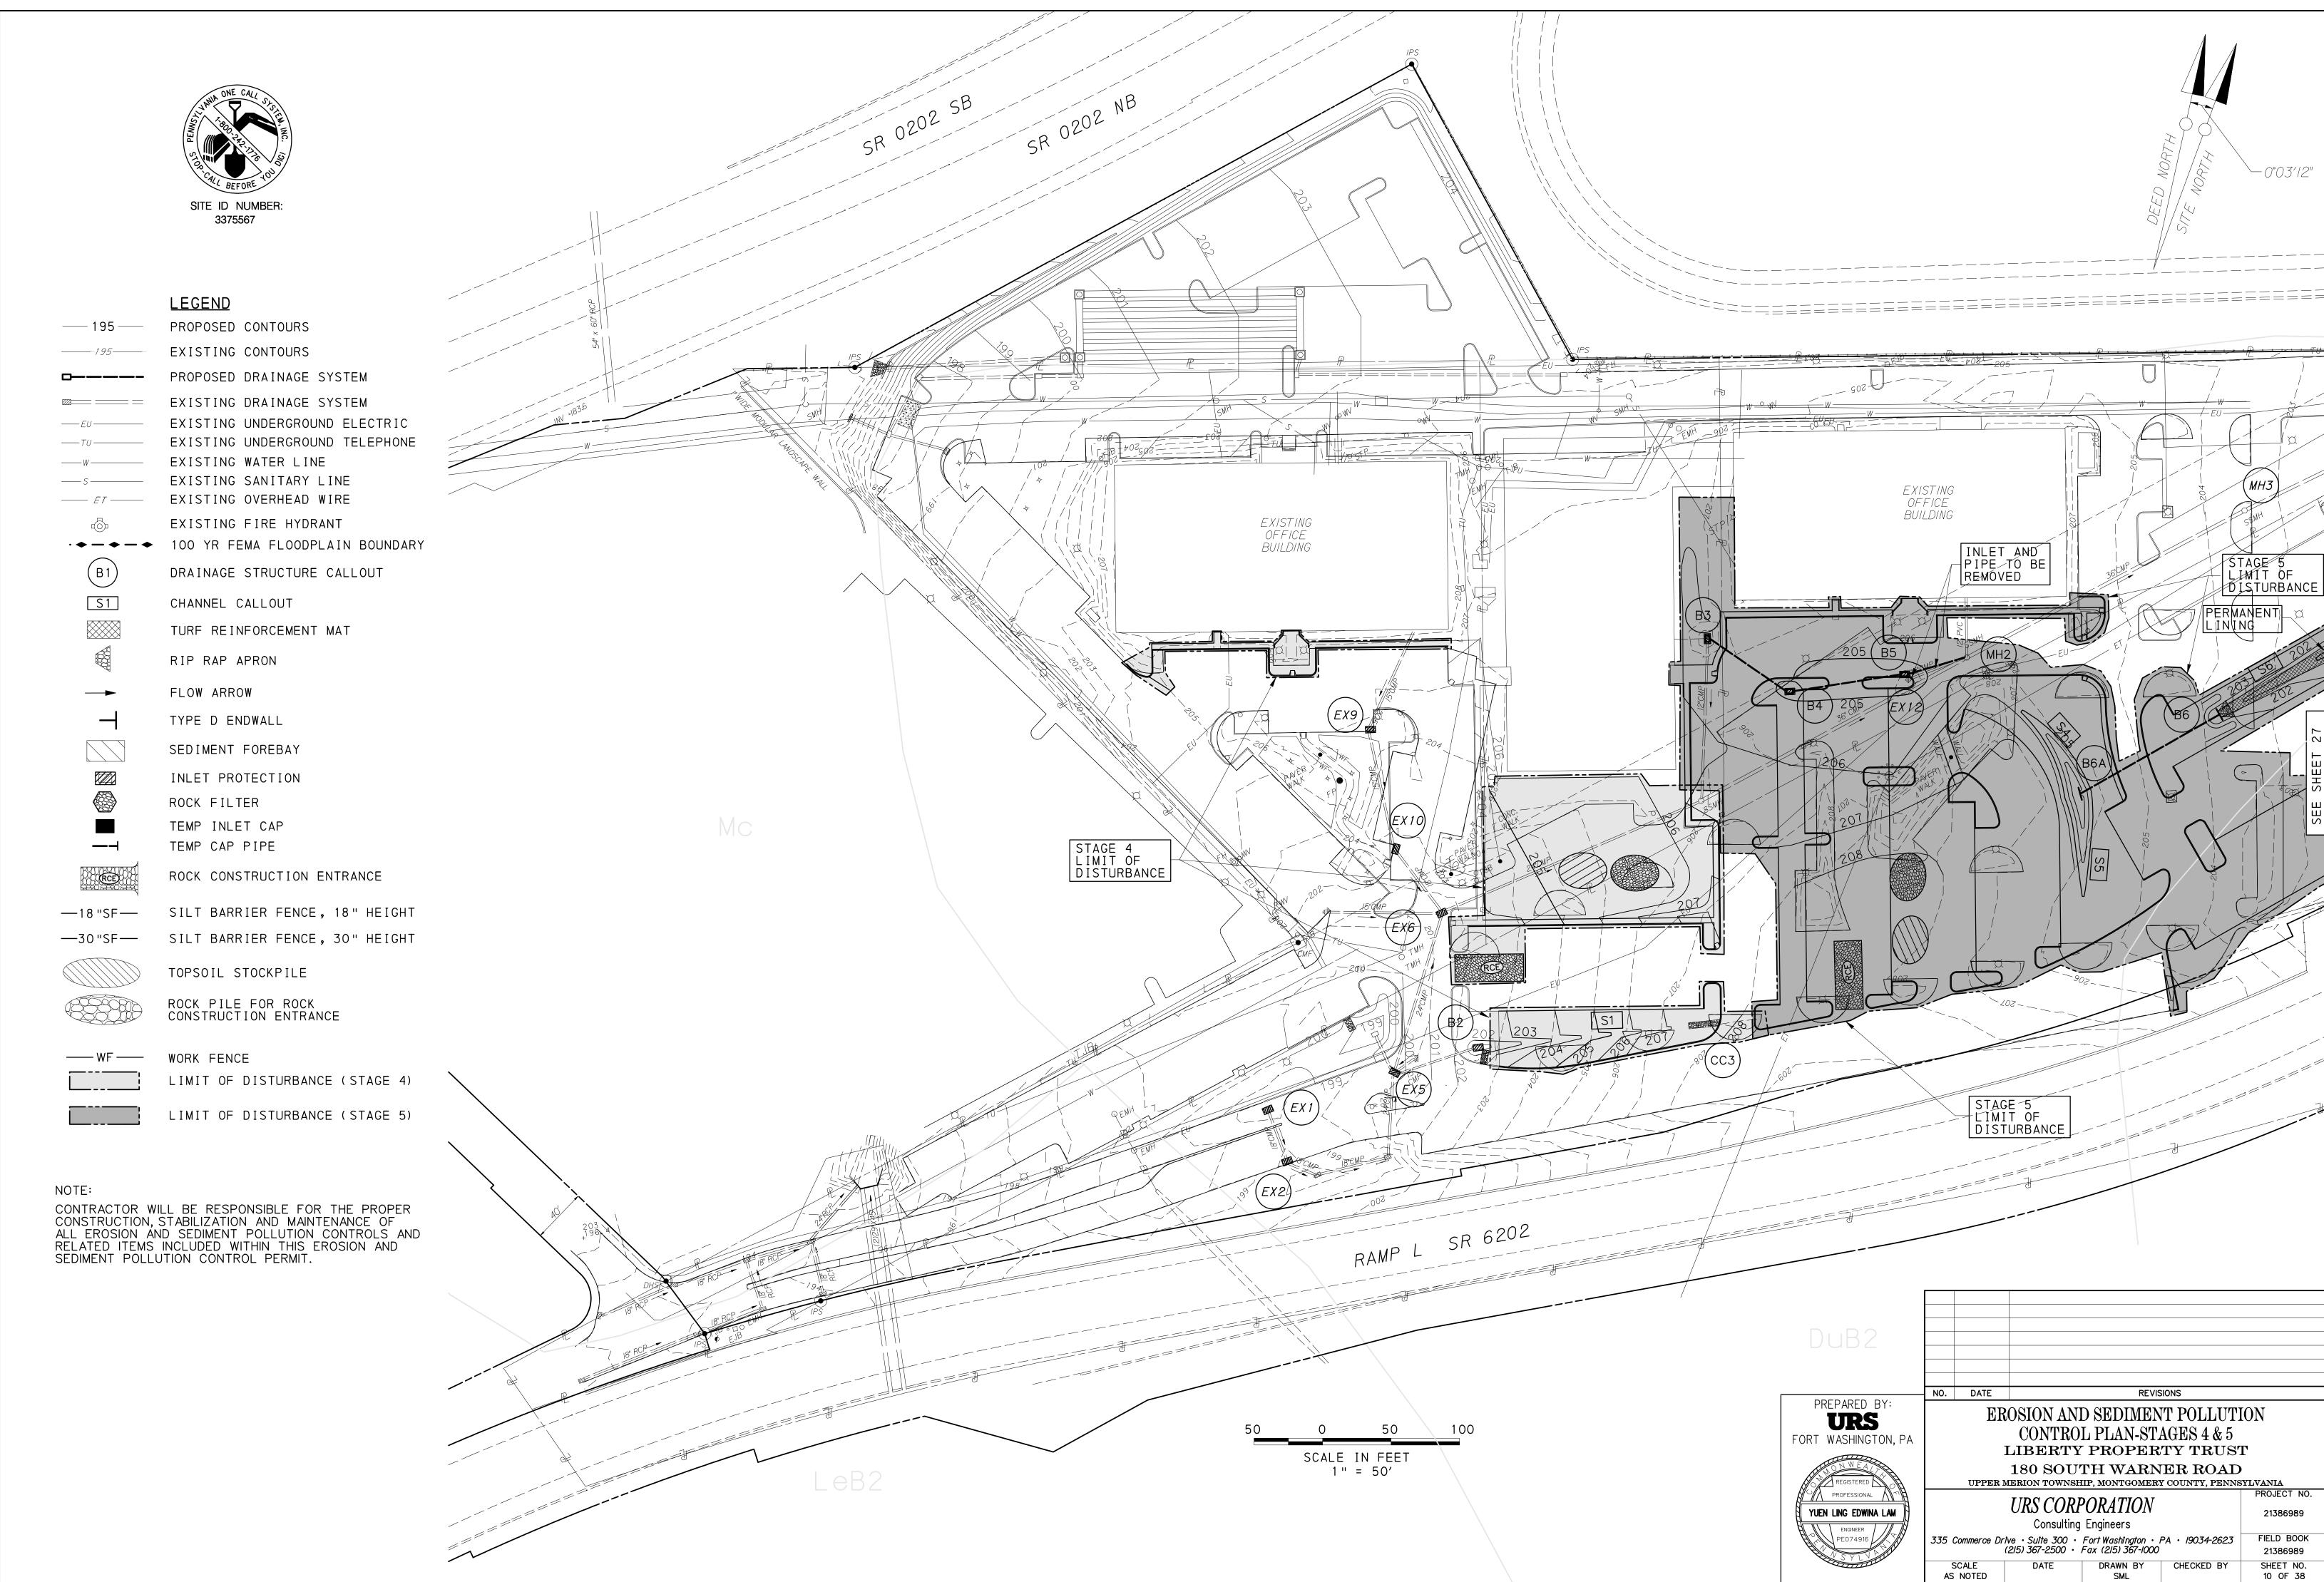

.Z.)366989\CAUD\CIVII\diso\e\_s\ES4-5\_FlanUl.agn /30/2008 6:15:28 AM steve\_lepera

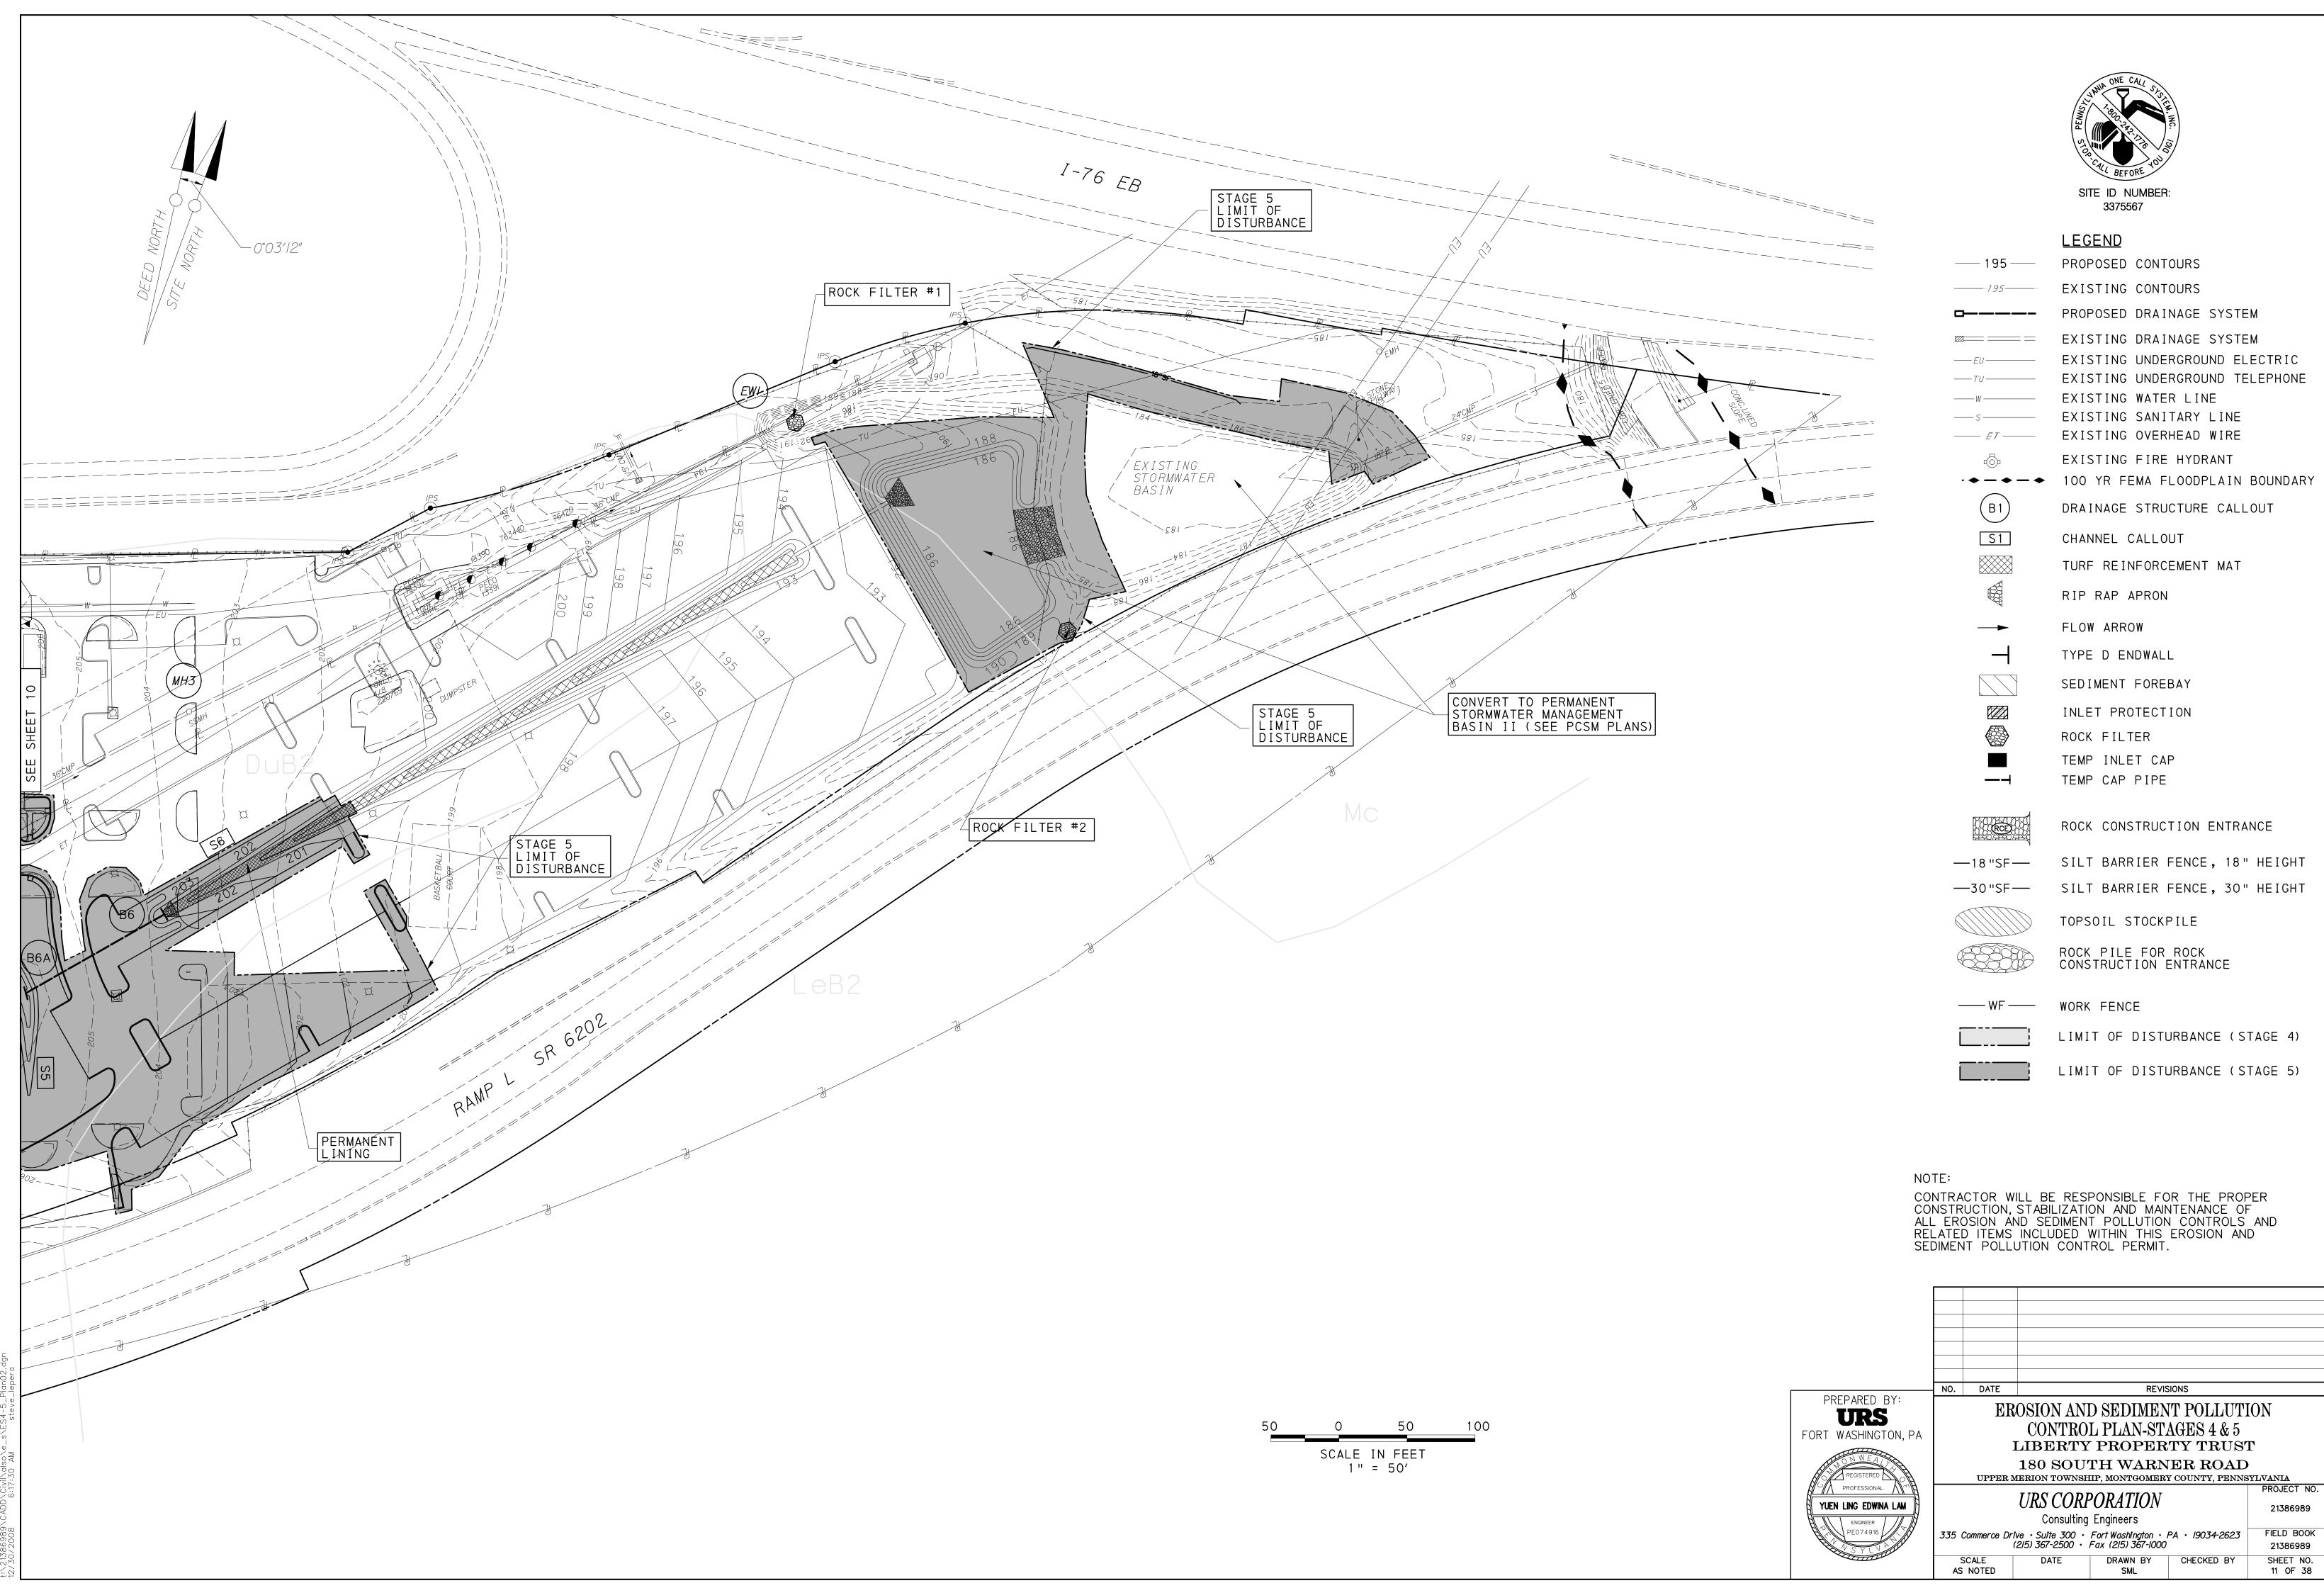

#### STANDARD EROSION AND SEDIMENT POLLUTION CONTROL PLAN NOTES

NOTE: AT LEAST 7 DAYS BEFORE STARTING ANY EARTH DISTURBANCE ACTIVITIES, THE OPERATOR SHALL INVITE ALL CONTRACTORS INVOLVED IN THOSE ACTIVITIES INCLUDING BUT NOT LIMITED TO: THE LANDOWNER AND ALL APPROPRIATE MUNICIPAL OFFICALS, THE EROSION AND SEDIMENT CONTROL PLAN PREPARER, AND THE MONTGOMERY COUNTY CONSERVATION DISTRICT TO AN ON SITE MEETING. ALSO AT LEAST 3 DAYS BEFORE STARTING ANY EARTH DISTURBANCE ACTIVITIES, ALL CONTACTORS INVOLVED IN THOSE ACTIVITIES SHALL NOTIFY THE PENNSYLVANIA ONE CALL SYSTEM INCORPORATED AT 1-800-242-1776 FOR BURIED UTILITIES LOCATIONS.

THE FOLLOWING ARE GENERAL NOTES AND WILL BE INCLUDED, UPON ACCEPTANCE, IN THE CONTRACT DOCUMENTS:

- 1. THE OPERATOR SHALL ASSURE THAT THE APPROVED EROSION AND SEDIMENT CONTROL PLAN IS PROPERLY AND COMPLETELY IMPLEMENTED.
- 2. IMMEDIATELY UPON DISCOVERING UNFORESEEN CIRCUMSTANCES POSING THE POTENTIAL FOR ACCELERATED EROSION AND / OR SEDIMENT POLLUTION, THE OPERATOR SHALL IMPLEMENT APPROPRIATE BEST MANAGEMENT PRACTICES TO ELIMINATE POTENTIAL FOR ACCELERATED EROSION AND / OR SEDIMENT POLLUTION.
- BEFORE INITIATING ANY REVISIONS TO THE APPROVED EROSION AND SEDIMENT CONTROL PLAN OR REVISIONS TO OTHER PLANS WHICH MAY IMPACT THE EFFECTIVENESS OF THE APPROVED E&S CONTROL PLAN, THE OPERATOR MUST RECEIVE APPROVAL OF THE REVISIONS FROM THE MONTGOMERY COUNTY CONSERVATION DISTRICT.
- 4. THE OPERATOR SHALL ASSURE THAT AN EROSION AND SEDIMENT CONTROL PLAN HAS BEEN PREPARED, APPROVED BY THE APPROPRIATE CONSERVATION DISTRICT, AND IS BEING IMPLEMENTED AND MAINTAINED FOR ALL SOIL AND / OR ROCK SPOIL AND BORROW AREAS, REGARDLESS OF THEIR LOCATIONS.
- 5. THE CONTRACTOR IS ADVISED TO BECOME THOROUGHLY FAMILIAR WITH THE PROVISIONS OF THE APPENDIX 64, EROSION CONTROL RULES AND REGULATIONS, TITLE 25, PART 1, DEPARTMENT OF ENVIRONMENTAL PROTECTION, SUBPART C. PROTECTION OF NATURAL RESOURCES, ARTICLE III, WATER RESOURCES, CHAPTER 102, EROSION CONTROL.
- 6. SEDIMENT REMOVED FROM BMP'S SHALL BE DISPOSED OF IN LANDSCAPE AREAS OUTSIDE OF STEEP SLOPES, WETLANDS, FLOODPLAINS OR DRAINAGE SWALES AND IMMEDIATELY STABILIZED, OR PLACED IN TOPSOIL STOCKPILES.
- 7. THE NPDES BOUNDARY IS EQUAL TO THE LIMITS OF DISTURBANCE OF THE SITE AND ANY OFF-SITE AREAS WITHIN THE LIMITS OF DISTURBANCE THAT ARE THE RESPONSIBILITY OF THE DEVELOPER TO INSTALL. OFF-SITE FACILITIES SUCH AS: UTILITIES AND ROADWAYS.
- 8. THE PROJECT RECEIVING WATERCOURSE IS CROW CREEK, AND THE CHAPTER 93 CLASSIFICATION IS WARM WATER FISHERY.
- 9. ONLY LIMITED UPSLOPE DISTURBANCE WILL BE PERMITTED TO PROVIDE ACCESS TO SEDIMENT TRAPS, ROCK FILTER DAMS, AND INTERCEPTOR CHANNELS FOR GRADING AND ACQUIRING BORROW TO CONSTRUCT THOSE CONTROLS.
- 10. EROSION AND SEDIMENTATION CONTROLS MUST BE CONSTRUCTED, STABILIZED AND FUNCTIONAL BEFORE SITE DISTURBANCE WITHIN THE TRIBUTARY AREAS OF THOSE CONTROLS.
- 11. AFTER FINAL SITE STABILIZATION HAS BEEN ACHIEVED, TEMPORARY EROSION AND SEDIMENTATION CONTROLS MUST BE REMOVED. AREAS DISTURBED DURING REMOVAL OF THE CONTROLS MUST BE STABILIZED IMMEDIATELY.
- 12. SEDIMENT TRAPS MUST BE PROTECTED FROM UNAUTHORIZED ACTS OF THIRD PARTY.
- 13. SEDIMENT MUST BE REMOVED FROM TRAPS WHEN SEDIMENT HAS ACCUMULATED TO THE CLEANOUT ELEVATION.
- 14. SILT BARRIER FENCE MUST BE INSTALLED AT LEVEL GRADE. BOTH ENDS OF EACH FENCE SECTION MUST EXTEND AT LEAST 8 FEET UPSLOPE AT 45 DEGREE TO THE MAIN FENCE ALIGNMENT
- 15. SEDIMENT MUST BE REMOVED WHEN ACCUMULATIONS REACH HALF THE ABOVE GROUND HEIGHT OF THE SILT BARRIER FENCE
- 16. ANY FENCE SECTION WHICH HAS BEEN UNDERMINED OR OVERTOPPED MUST BE IMMEDIATELY REPLACED WITH A ROCK FILTER OUTLET. SEE ROCK FILTER OUTLET DETAIL.
- 17. IN ACCORDANCE WITH THE APPROVED CONSTRUCTION SEQUENCE, THE ENGINEER WILL LIMIT THE AREA OF EXCAVATION, BORROW, WASTE, AND EMBANKMENT IN PROGRESS DEPENDENT UPON THE PROGRESS OF THE CONTRACTOR'S STABILIZATION AND OTHER SPECIFIED TEMPORARY OR PERMANENT EROSION CONTROL MEASURES. THE EXTENT OF EXPOSED ERODIBLE SURFACE AREA AT ANY TIME DURING CONSTRUCTION SHALL BE LIMITED IN ACCORDANCE WITH THE APPROVED CONSTRUCTION SEQUENCE.
- 18. ALL TOPSOIL FROM THE OVERALL SITE PREPARATION WILL BE STOCKPILED WHERE SHOWN ON PLAN AND STABILIZED TO PROTECT FROM EROSION. SILT BARRIER FENCE PROTECTION WILL BE INSTALLED PRIOR TO STOCKING AND ANY NECESSARY GRADING TO PREVENT SILT FROM LEAVING SITE WILL BE COMPLETED AND STABILIZED. AT THE TIME OF FINAL GRADING THE TOPSOIL SHALL BE REDISTRIBUTED UNIFORMLY THROUGHOUT THE SITE.
- 19. THE CONTRACTOR WILL BE RESPONSIBLE FOR THE PROPER CONSTRUCTION, STABILIZATION, AND MAINTENANCE OF ALL EROSION AND SEDIMENTATION CONTROLS AND RELATED ITEMS INCLUDED WITHIN THIS PERMIT.
- 20. STORMWATER INLETS WHICH DO NOT DISCHARGE TO SEDIMENT TRAPS OR BASINS MUST BE PROTECTED UNTIL THE TRIBUTARY AREAS ARE STABILIZED.
- 21. SEDIMENT MUST BE REMOVED FROM INLET PROTECTION AFTER EACH STORM EVENT.
- 22. STOCKPILE HEIGHTS MUST NOT EXCEED 35 FEET. STOCKPILE SLOPES MUST BE 2:1 OR FLATTER.
- 23. CHANNELS, SEDIMENT TRAPS, AND STOCKPILE MUST BE STABILIZED IMMEDIATELY.
- 24. HAY OR STRAW MULCH MUST BE APPLIED AT A RATE OF AT LEAST 3.0 TONS PER ACRE
- 25. MULCH WITH MULCH CONTROL NETTING OR EROSION CONTROL BLANKETS MUST BE INSTALLED ON ALL SLOPES 3:1 OR STEEPER.
- 26. STRAW MULCH SHALL BE APPLIED IN LONG STANDS, NOT CHOPPED OR FINELY BROKEN

- 27. UNTIL THE SITE IS STABILIZED, ALL EROSION AND SEDIMENTATION CONTROLS MUST BE MAINTAINED PROPERLY. MAINTENANCE MUST INCLUDE INSPECTIONS OF ALL EROSION AND SEDIMENT CONTROL AFTER EACH RUNOFF EVENT AND ON A WEEKLY BASIS. ALL SITE INSPECTIONS WILL BE DOCUMENTED IN AN INSPECTION LOG KEPT FOR THIS PURPOSE. THE COMPLIANCE ACTIONS AND THE DATE, TIME AND NAME OF THE PERSON CONDUCTING THE INSPECTION. THE INSPECTION LOG WILL BE KEPT ON SITE AT ALL TIMES AND MADE AVAILABLE TO THE DISTRICT UPON REQUEST.
  - ALL PREVENTIVE AND REMEDIAL MAINTENANCE WORK INCLUDING CLEAN OUT, REPAIR, REPLACEMENT, REGRADING, RESEEDING, REMULCHING AND RENETTING, MUST BE PREFORMED IMMEDIATELY. IF EROSION AND SEDIMENTATION BMPS FAIL TO PERFORM, AS EXPECTED, REPLACEMENT BMPS OR MODIFICATIONS OF THOSE INSTALLED WILL BE NEEDED.
  - WHERE BMPS ARE FOUND TO FAIL TO ALLEVIATE EROSION OR SEDIMENT POLLUTION THE PERMITTEE OR CO-PERMITTEE SHALL INCLUDE THE FOLLOWING INFORMATION:
  - A. THE LOCATION AND SEVERITY OF THE BMPS FAILURE AND ANY POLLUTION EVENTS. B. ALL STEPS TAKEN TO, REDUCE, ELIMINATE AND PREVENT THE RECURRENCE OF THE NON-COMPLIANCE. C. THE TIME FRAME TO CORRECT THE NON-COMPLIANCE, INCLUDING THE EXACT DATES WHEN THE ACTIVITY WILL RETURN TO COMPLIANCE.
- 28. SHOULD ANY MEASURES CONTAINED WITHIN THIS PLAN PROVE INCAPABLE OF ADEQUATELY REMOVING SEDIMENT FROM ON-SITE FLOWS PRIOR TO DISCHARGE OR STABILIZING THE SURFACES INVOLVED, ADDITIONAL MEASURES MUST BE IMMEDIATELY IMPLEMENTED BY THE CONTRACTOR TO ELIMINATE ALL SUCH PROBLEMS.
- 29. ADHERE TO ANY MANUFACTURER'S RECOMMENDATIONS FOR REPLACING SILT BARRIER FENCE FABRIC DUE TO WEATHERING.
- 30. WATERCOURSE CHANNELS WILL BE MAINTAINED TO ENSURE THAT THE SPECIFIED DESIGN DIMENSIONS AND STABILIZATION ARE AVAILABLE AT ALL TIMES.
- 31. ALL PERMANENT ROCK OUTLETS WILL BE INSPECTED, CLEANED AND REPAIRED TO FINAL ELEVATIONS AFTER ALL STORM EVENTS DURING CONSTRUCTION AND AFTER STABILIZATION IS COMPLETED.
- 32. SHOULD UNFORESEEN EROSIVE CONDITIONS DEVELOP DURING CONSTRUCTION, TAKE ACTION TO REMEDY SUCH CONDITIONS AND TO PREVENT DAMAGE TO ADJACENT PROPERTIES AS A RESULT OF INCREASED RUNOFF AND/OR SEDIMENT DISPLACEMENT. HOLD IN READINESS STOCKPILES OF WOOD CHIPS HAY BALES, CRUSHED STONE AND OTHER MULCHES TO DEAL IMMEDIATELY WITH EMERGENCY PROBLEMS OF EROSION.
- 33. ALL STRUCTURES ASSOCIATED WITH CONSTRUCTION OF SEDIMENT REMOVAL FACILITIES AND STORM SEWER PIPING MUST BE AVAILABLE ON-SITE PRIOR TO DISTURBING THE ASSOCIATED AREA.
- 34. ALL PUMPED WATER FROM CONSTRUCTION AREAS MUST BE PUMPED TO A SEDIMENT BASIN, SEDIMENT TRAP OR FILTER BAG AS SHOWN ON THE PLANS. CONTRACTOR MUST OBTAIN APPROVAL FROM THE CHESTER COUNTY CONSERVATION DISTRICT FOR ANY TYPE OF FACILITY NOT SHOWN ON THE PLANS.
- 35. LIMIT CLEARING AND GRUBBING OPERATIONS FOR ACCESS FOR CONSTRUCTING EROSION AND SEDIMENTATION CONTROL DEVICES TO A MAXIMUM WIDTH OF 20 FEET. PLACE 4 INCHES OF SUBBASE ON CLEARED AREA.
- 36. UPON COMPLETION OF SITE CONSTRUCTION AND STABILIZATION, REMOVE ALL INLET PROTECTION, SILT BARRIER FENCE, AND ROCK FILTER DAMS. SEED, MULCH AND STABILIZE ALL DISTURBED AREAS FOR WINTER SEASON CONSTRUCTION SHUT DOWN.
- 37. UNIFORM 70% PERENNIAL VEGETATIVE COVER OR OTHER PERMANENT NON-VEGETATIVE COVER MUST BE ESTABLISHED PRIOR TO REMOVAL OF ALL SEDIMENT TRAPS, SEDIMENT BASINS AND ALL EROSION AND SEDIMENT POLLUTION CONTROL DEVICE.
- 38. WASTE OR BORROW SOIL USED ON THE SITE MUST COME FROM A SITE WITH AN EROSION AND SEDIMENT POLLUTION CONTROL PLAN APPROVED BY THE APPROPRIATE COUNTY CONSERVATION DISTRICT.
- 39. DURING WINTER MONTHS (NOVEMBER TO MARCH) EARTHMOVING WILL BE PERFORMED DURING FAVORABLE WEATHER CONDITIONS
- 40. MAINTAIN EXISTING TEMPORARY SLOPE PIPE DRAINS AND BERMS UNTIL CONSTRUCTION IS COMPLETED.
- 41. TOTAL DISTURBED AREA = 10.69 ACRES
- 42. ENVIRONMENTAL DUE DILIGENCE IS DEFINED AS: INVESTIGATIVE TECHNIQUES, INCLUDING, BUT NOT LIMITED TO, VISUAL PROPERTY INSPECTIONS, ELECTRONIC DATA BASE SEARCHES, REVIEW OF PROPERTY OWNERSHIP, REVIEW OF PROPERTY US HISTORY, SANDBORN MAPS, ENVIRONMENTAL QUESTIONNAIRES, TRANSACTION SCREENS, ANALYTICAL TESTING, ENVIRONMENTAL ASSESSMENTS OR AUDITS.
- 43. CLEAN FILL IS DEFINED AS: UNCONTAMINATED, NON-WATER SOLUBLE, NON-DECOMPOSABLE, INERT, SOLD MATERIAL. THE TERM INCLUDES SOIL, ROCK, STONE, DREDGED MATERIAL, USED ASPHALT, AND BRICK, BLOCK OR CONCRETE FROM CONSTRUCTION AND DEMOLITION ACTIVITIES THAT IS SEPARATE FROM OTHER WASTE AND IS RECOGNIZABLE AS SUCH. THE TERM DOES NOT INCLUDE MATERIALS PLACED IN OR ON THE WATERS OF THE COMMONWEALTH UNLESS OTHERWISE AUTHORIZED. (THE TERM "USED ASPHALT" DOES NOT INCLUDE MILLED ASPHALT OR ASPHALT THAT HAS BEEN PROCESSED FOR RE-USE.)
- 44. ANY DAMAGE THAT OCCURS AS A RESULT OF THE BASIN OR TRAP DISCHARGE MUST BE REPAIRED IN A PERMANENT MANNER THAT IS SATISFACTORY TO THE MUNICIPALITY, CONSERVATION DISTRICT AND DOWN SLOPE LANDOWNER(S).
- 45. AN AREA SHALL BE CONSIDERED TO HAVE ACHIEVED FINAL STABILIZATION WHEN IT HAS A MINIMUM UNIFORM 70% PERENNIAL VEGETATIVE COVER OR OTHER PERMANENT NON-VEGETATIVE COVER WITH A DENSITY SUFFICIENT TO RESIST ACCELERATED SURFACE EROSION AND SUBSURFACE CHARACTERISTICS SUFFICIENT TO RESIST SLIDING AND OTHER MOVEMENTS. IMMEDIATELY AFTER EARTH DISTURBANCE ACTIVITIES CEASE. THE OPERATOR SHALL STABILIZE ANY AREAS DISTURBED BY THE ACTIVITIES. DURING NON-GERMINATING PERIODS, MULCH MUST BE APPLIED AT THE SPECIFIED RATES. DISTURBED AREAS WHICH ARE NOT AT FINISHED GRADE AND WHICH WILL BE REDISTURBED WITHIN 1 YEAR MUST BE STABILIZED IN ACCORDANCE WITH THE TEMPORARY VEGETATIVE STABILIZATION SPECIFICATIONS. DISTURBED AREAS WHICH ARE AT FINISHED GRADE OR WHICH WILL NOT BE REDISTURBED WITHIN 1 YEAR MUST BE STABILIZED IN ACCORDANCE WITH THE PERMANENT VEGETATIVE STABILIZATION SPECIFICATIONS.
- 46. CONTRACTOR WILL BE RESPONSIBLE TO PREPARE AND OBTAIN A SEPARATE EROSION AND SEDIMENTATION CONTROL PERMIT FOR THE IMPORT AND EXPORT OF FILL MATERIAL.



PREPARED BY: **URS** FORT WASHINGTON, PA YUEN LING EDWINA LAM

NO. DATE REVISIONS EROSION & SEDIMENT POLLUTION CONTROL STANDARD NOTES LIBERTY PROPERTY TRUST 180 SOUTH WARNER ROAD

UPPER MERION TOWNSHIP, MONTGOMERY COUNTY, PENNSYLVANIA URS CORPORATION

AS NOTED

Consulting Engineers 335 Commerce Drive • Suite 300 • Fort Washington • PA • 19034-2623 (215) 367-2500 · Fax (215) 367-1000

SML

DRAWN BY CHECKED BY

21386989

FIELD BOOK

21386989

SHEET NO.

2 OF 38

NOTE:

CONTRACTOR WILL BE RESPONSIBLE FOR THE PROPER CONSTRUCTION, STABILIZATION AND MAINTENANCE OF ALL EROSION AND SEDIMENT POLLUTION CONTROLS AND RELATED ITEMS INCLUDED WITHIN THIS EROSION AND SEDIMENT POLLUTION CONTROL PERMIT.

98

92

85

80×

80

0.15

0.10

0.15

7.5

2.0

1.0

#### \* MINIMUM 20% HARDSEED AND 60% NORMAL SPROUT

BIRDSFOOT TREFOIL MIXTURE (LOTUS)

• REDTOP (AGROSTIS ALBA)

OF EITHER EMPIRE, NORCEN, OR LEO.

● TALL FESCUE (FESTUCA ARUNDINACEA VAR. KENTUCKY 31) 70

CORNICULATUS). A MIXTURE OF 1/2 VIKING AND 1/2

#### SEEDING APPLICATION DATES

GENERAL: SPREAD SEEDS WHERE INDICATED AND AT THE RATES SPECIFIED IN TABLE A, OR AS OTHERWISE INDICATED. SPREAD SEEDS WITHIN THE FOLLOWING DATES, OR OTHERWISE INDICATED OR DIRECTED.

● FORMULA B, D, AND L-----MARCH 15 TO JUNE 1 AUGUST 1 TO OCTOBER 15 • FORMULA C ----- CROWNVETCH PORTION: ANYTIME EXCEPT SEPTEMBER AND OCTOBER ● FORMULA E ------ MARCH 15 TO OCIOBER 15 ● FORMULA W ------ APRIL 1 TO JUNE 15 AUGUST 16 TO SEPTEMBER 15

\* FOR INFORMATION ONLY, REFERS TO PADOT'S PUBLICATION 408, SECTION 804 AND 805 FOR COMPLETE AND REGULATORY SPECIFICATIONS.

WHEN PROJECT CONDITIONS WARRANT, SEEDING DATES MAY BE EXTENDED. IF EXTENDED. EITHER APPLY FULL TREATMENT OR APPLY ONLY 50% OF THE PERMANENT SEEDING AND SOIL SUPPLEMENTS AND APPLY THE REMAINING 50% WITHIN THE NEXT SEEDING DATES, AS DIRECTED IN WRITING BY THE INSPECTOR-IN-CHARGE.

ON TOPSOILED AREAS, WHERE TEMPORARY SEEDING OR MULCHING HAS BEEN APPLIED, USE TILLAGE AND SOIL SUPPLEMENTS PRIOR TO PERMANENT SEEDING.

ON UNTOPSOILED AREA. WHERE TEMPORARY SEEDING OR MULCHING HAS BEEN APPLIED. PERMANENT SEED AND/OR SOIL SUPPLEMENTS MAY BE APPLIED WITHOUT TILLING.

ALL FINISHED SLOPES SHALL BE SEEDED AND/OR MULCHED IN APPROXIMATELY 15-FOOT INCREMENTS WITH PERMANENT IN-SEASON SEEDING AS INDICATED IN THE SEEDING SCHEDULE SHOWN IN TABLE B. THIS SHALL BE DONE IMMEDIATELY AFTER GRADING IS COMPLETED, AT THE FULL APPLICATION RATES SPECIFIED FOR SEED, SUPPLEMENTS, AND MULCH OR OTHER STABILIZATION METHODS.

#### TARLE R

TABLE B							
SCHEDULE OF SEEDING AND SOIL SUPPLEMENTS							
SEEDING AND SOIL SUPPLEMENT FORMULA	APPLICATION						
В	NONSTEEP AREAS (LESS THAN 4:1) HIGHLY MAINTAINED AND MOWED SURFACES, USE ONLY ON TOPSOIL AREAS.						
С	SLOPES STEEPER THAN 3:1						
D	ALL DRAINAGE SWALES AND DITCHES AND < 4:1						
E	TEMPORARY SEEDING						
L	ALL SLOPE 4:1 AND FLATER, DITCHES AND CHANNEL						
W	POND EMBANKMENT AND SELECTED DITCHES IN WETLANDS						

#### MULCH TYPES

FREE FROM FOREIGN MATERIAL, COARSE STEMS, AND ANY SUBSTANCES TOXIC TO PLANT GROWTH. ALSO, FREE FROM MATURE SEED BEARING STALKS OR ROOTS OF PROHIBITED AND NOXIOUS WEEDS, BOTH AS DEFINED BY LAW.

WHEN REQUESTED, AND PRIOR TO PROJECT DELIVERY, FURNISH A CERTIFIED PHYSICAL AND CHEMICAL ANALYSIS FOR MULCHES. USE MULCHES SEPARATELY OR, IF INDICATED, IN COMBINATION WITH WEED BARRIER MAT, AS SPECIFIED IN SECTION 808.2(Q).

EITHER ONE OR A COMBINATION OF THE FOLLOWING, AS SPECIFIED:

#### A. HAY

**MULCHES** 

TIMOTHY HAY, MIXED CLOVER AND TIMOTHY HAY, OR OTHER ACCEPTABLE NATIVE OR FORAGE GRASSES, WELL-CURED TO LESS THAN 20% MOISTURE CONTENT, BY WEIGHT.

#### B. STRAW

EITHER WHEAT OR OAT STRAW, REASONABLY FREE OF VIABLE SEED, WELL CURED TO LESS THAN 20% MOISTURE CONTENT, BY WEIGHT.

#### MULCHING APPLICATION RATES

#### MULCHING SEEDED AREAS

PLACE MULCH. OF THE KIND INDICATED. IMMEDIATELY AFTER SEEDING OR WITHIN 48 HOURS AFTER SEEDING IS COMPLETED. UNLESS OTHER-WISE INDICATED, PLACE ONLY STRAW OR WOOD FIBER OVER TOPSOILED AREAS. USE HAY, STRAW, OR WOOD FIBER IN OTHER AREAS, AS INDICATED OR SPECIFIED.

PLACE HAY OR STRAW UNIFORMLY, IN A CONTINUOUS BLANKET, AT A MINIMUM RATE OF 1,200 POUNDS PER 1,000 SQUARE YARDS, OR AS OTHERWISE INDICATED. IF DIRECTED, INCREASE THE RATE OF APPLICATION, DEPENDING UPON THE MATERIAL USED, SEASON, SOIL CONDITIONS, OR METHOD OF APPLICATION. AN ACCEPTABLE MECHANICAL BLOWER MAY BE USED TO APPLY MULCH. MACHINES WHICH CUT MULCH INTO SHORT PIECES WILL NOT BE PERMITTED. ANCHOR MULCH WITH SPECIFIED MULCH BINDERS APPLIED AT THE FOLLOWING RATES:

- © RECYCLED CELLULOSE FIBER. 160 POUNDS PER 1,000 SQUARE YARDS
- WOOD FIBER. 160 POUNDS PER 1,000 SQUARE YARDS
- NONASPHALTIC EMULSION. AT MANUFACTURER'S RECOMMENDED RATE • RECYCLED CELLULOSE FIBER/WOOD FIBER MIXTURE. 160 POUNDS

PER 1,000 SQUARE YARDS.

APPLY WOOD FIBER MULCH HYDRAULICALLY IN ACCORDANCE WITH THE MANUFACTURER'S TANK-MIXING INSTRUCTION. IT MAY BE INCORPORATED AS AN INTEGRAL PART OF THE SLURRY AFTER THE SEED AND SOIL SUPPLEMENTS HAVE BEEN THOROUGHLY MIXED. APPLY UNIFORMLY AT THE RATE OF 320 POUNDS PER 1,000 SQUARE YARDS, UNLESS OTHERWISE

MULCH TEMPORARY SEEDED AREAS WITH HAY.

#### MULCHING PLANTED AREAS

UNIFORMLY MULCH ENTIRE PLANT PIT BASINS, SHRUB BEDS, AND OTHER AREAS AS DIRECTED TO A LOOSE DEPTH OF 3 INCHES, OR AS INDICATED. DO NOT MULCH AREAS PLANTED WITH CROWNVETCH OR REFORESTATION

PLACE MULCH EITHER BY HAND OR USING MECHANICAL SPREADING FQUIPMENTMANUFACTURERED FOR THIS PURPOSE. TEST APPLICATION PROCEDURES TO ENSURE CONFORMANCE WITH DEPTH REQUIREMENTS. REDISTRIBUTE MULCH IN AREAS OF EXCESSIVE DEPTH. APPLY MULCH WITHIN 48 HOURS AFTER COMPLETION OF EACH PLANTED AREA.

### MULCH CONTROL NETTING

#### 1. PLASTIC

A UNIFORMLY EXTRUDED, RECTANGULAR, PLASTIC MESH MEETING THE FOLLOWING REQUIREMENTS:

● COLOR --------- BLACK, GREEN OR CLEAR

WEIGHT --------- 0.23 OUNCES PER SQUARE YARD, MINIMUM

● MESH OPENING ------ NOMINAL 3/4- INCH x 3/4- INCH

#### 2. COCONUT COIR

UNDYED, BIODEGRADABLE COCONUT COIR YARN WOVEN INTO A MESH MEETING THE FOLLOWING REQUIREMENTS:

• WEIGHT ----- 6 OUNCES PER SQUARE YARD

● MESH OPENING ------ NOMINAL 2- INCH x 2- INCH

#### MULCH NETTING APPLICATION

#### 1. PLASTIC

INSTALL NETTING OVER DESIGNATED MULCH SURFACE, STAPLE UPSLOPE ENDS, EDGES, BOTTOM, AND OVERLAPS AT 2-FOOT INTERVALS. OVERLAP ADJAĆENT FÁBRIC WIĎTHS BY NOT LESS THAN 4- INCH. STAPLE FROM CENTER OF FABRIC TO OUTSIDE EDGES. SECURE REMAINING FABRIC AREAS BY PUTTING IN APPROXIMATELY 1 STAPLE PER SQUARE YARD OF AREA.

#### 2. COCONUT COIR

INSTALL NETTING OVER DESIGNATED MULCH SURFACE, STRETCH FABRIC TIGHTLY AND ANCHOR WITH WOOD STAKES ALONG ALL EDGES AT 6 1/2 TO 7- FOOT INTERVALS. OVERLAP ADJACENT FABRIC WIDTHS BY NOT LESS THAN 8- INCH.

### 3. MULCH NETTING

MUST BE INSTALLED ON ALL SLOPES STEEPER THAN 3:1.

#### SOIL SUPPLEMENTS

#### PULVERIZED AGRICULTURAL LIMESTONE

CONFORMING TO THE REQUIREMENTS OF THE AGRICULTURAL LIMING MATERIALS ACT OF 1978, P.L. 15, NO. 9, AS AMENDED; CONFORMING TO THE CURRENT STATE SPECIFICATIONS NO. L-37 FOR GROUP 1, CLASS B, TYPE MO MATERIAL.

FURNISH MATERIAL HAVING AN EFFECTIVE NEUTRALIZING POWER OF NOT LESS THAN 64 WHEN CALCULATED, USING THE GUARANTEED CHEMICAL ANALYSIS AND FINENESS, IN ACCORDANCE WITH THE AGRICULTURAL LIMING MATERIALS RULÉS AND REGULATIONS (7 PA. CODE, PART V, CHAPTER 108).

#### 2. COMMERCIAL FERTILIZER

CONFORMING TO THE REQUIREMENTS OF THE PENNSYLVANIA SOIL CONDITIONER AND PLANT GROWTH SUBSTANCE LAW, ACT OF DECEMBER 1, 1977, P.L. 258, NO. 86 (3P.S.68.2), AS AMENDED.

USE DRY FORMULATIONS OF 10-20-20 ANALYSIS FOR SEEDED AND SODDED AREAS. USE DRY FORMULATIONS OF 20-10-5 AND 16-8-16 ANALYSIS CONTROLLED RELEASE FOR TREE, SHRUB, AND VINE TYPE PLANTING OPERATIONS. USE DRY FORMULATIONS OF 19-6-12 ANALYSIS CONTROLLED RELEASE FOR HERBACEOUS WETLAND PLANTING OPERATIONS. USE OTHER ANALYSIS AS INDICATED OR SPECIFIED IN THE PROPOSAL.

#### 3. SLOW-RELEASE NITROGEN FERTILIZER

CONFORMING TO THE REQUIREMENTS OF THE PENNSYLVANIA SOIL CONDITIONER AND PLANT GROWTH SUBSTANCE LAW, ACT OF DECEM-BER 1. 1977. P.L.258. NO.86 (3P.S.68.2). AS AMENDED.

USE DRY FORMULATIONS OF EITHER 38-0-0 UREAFORM, 32-0-0 TO 38-0-0 SULFUR COATED UREA, 31-0-0 IBDU, OR ANOTHER ANALYSIS AS INDICATED, AND MEETING THE FOLLOWING REQUIREMENTS:

● 38-0-0 UREAFORM---38.0% MINIMUM TOTAL NITROGEN (TN) COLD WATER INSOLUBE -----25.0% MINIMUM NITROGEN (WIN) ACTIVITY INDEX -----40.0% MINIMUM UREA NITROGEN ------- 3.5% MINIMUM

32-0-0 TO 38-0-0 SULFUR COATED UREA WITH A 7-DAY DISSOLUTION RANGE OF 20% TO 30%

● 31-0-0 IBDU COARSE GRADE

(0.03 TO 0.1 INCH) ● WATER INSOLUBLE NITROGEN (WIN)----- 27.0% MINIMUM OTHER ANALYSIS AS INDICATED.

#### <u>SOIL SUPPLEMENTS</u> APPLICATION RATES

#### SOIL SUPPLEMENTS

UNIFORMLY APPLY SUPPLEMENTS TO THE AREAS TO BE SEEDED PROPERLY DOCUMENT BULK DELIVERY, AS SPECIFIED IN SECTION 804.2(A)2.

ON TOPSOILED AREAS. BLEND THE INITIAL SOIL SUPPLEMENTS INTO THE SOIL AT LEAST 50 mm BY RAKING, DISKING, HARROWING, OR BY ANOTHER ACCEPTABLE METHOD. THE BLENDING OF THE SUPPLE-MENTS INTO SOIL MAY BE PERFORMED DURING TILLAGE OPERATIONS.

PRIOR TO PROJECT COMPLETION, APPLY SLOW-RELEASE, NITROGEN FERTILIZER TO THE SURFACE OF FORMULA B, D AND L SEEDED AREAS. DO NOT NOT APPLY SLOW-RELEASE NITROGEN FERTILIZER SUPPLEMENT TO FORMULA C SEEDED AREAS.

APPLY SOIL SUPPLEMENTS AS FOLLOWS, UNLESS OTHERWISE INDICATED:

PULVERIZED AGRICULTURAL LIMESTONE ------ 800 POUNDS PER 1000 S.Y. 10-20-20 ANALYSIS COMMERCIAL ------ 140 POUNDS PER 1,000 S.Y. FERTILIZER

38-0-0 UREAFORM FERTILIZER ---------- 50 POUNDS PER 1,000 S.Y.

32-0-0 TO 38-0-0 SULFUR --------- 50 TO 59 POUNDS PER 1,000 S.Y. COATED UREA FERTILIZER

- 61 POUNDS PER 1.000 S.Y. 31-0-0 IBDU FERTILIZER ---

#### GENERAL NOTES

NOTE:

- 1. ALL SEEDING, SOIL SUPPLEMENTS AND MULCHING ITEMS SHALL BE PLACED IN ACCORDANCE WITH THE REQUIREMENTS OF PADOT PUBLICATION 408, SECTIONS 804 AND 805 OR OTHER APPROVED SPECIAL PROVISIONS.
- 2.ANY DISTURBED AREA ON WHICH ACTIVITY HAS CEASED MUST BE STABILIZED AND MULCHED IMMEDIATELY. DURING NON-GERMINATING PERIODS, MULCH MUST BE APPLIED AT THE RECOMMENDED RATES. DISTURBED AREAS WHICH ARE NOT AT FINISHED GRADE AND WHICH WILL BE REDISTURBED WITHIN 1 YEAR MUST BE SEEDED AND MULCHED WITH A QUICK GROWING TEMPORARY SEEDING MIXTURE AND MULCH. DISTURBED AREAS WHICH ARE EITHER AT FINISHED GRADE OR WILL NOT BE REDISTURBED WITHIN 1 YEAR MUST BE SEEDED AND MULCHED WITH A PERMANENT SEED MIXTURE AND MULCH IMMEDIATELY.



4.MULCH CONTROL NETTING MUST BE PLACED ON ALL SLOPES 3:1 AND STEEPER.


CONTRACTOR WILL BE RESPONSIBLE FOR THE PROPER

CONSTRUCTION. STABILIZATION AND MAINTENANCE OF

RELATED ITEMS INCLUDED WITHIN THIS EROSION AND

SEDIMENT POLLUTION CONTROL PERMIT.

5. CONTRACTOR WILL BE RESPONSIBLE FOR THE PROPER CONSTRUCTION, STABILIZATION AND MAINTENANCE, OF ALL EROSION AND SEDIMENTATION CONTROLS AND RELATED ITEMS INCLUDED WITHIN THIS PERMIT.

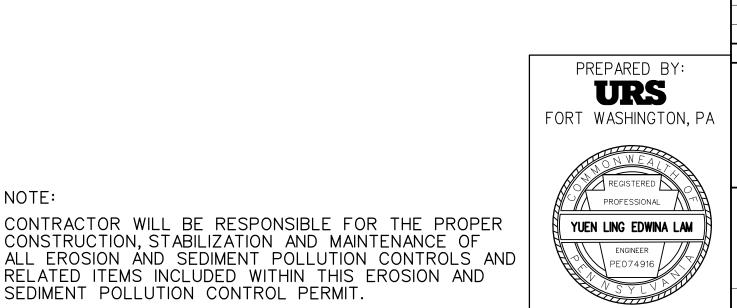

NO. DATE REVISIONS EROSION & SEDIMENT POLLUTION CONTROL SEEDING & MULCHING NOTES LIBERTY PROPERTY TRUST 180 SOUTH WARNER ROAD

SITE ID NUMBER:

3375567

UPPER MERION TOWNSHIP, MONTGOMERY COUNTY, PENNSYLVANIA URS CORPORATION Consulting Engineers

335 Commerce Drive • Suite 300 • Fort Washington • PA • 19034-2623 (215) 367-2500 · Fax (215) 367-1000 DRAWN BY CHECKED BY

AS NOTED

SML

FIELD BOOK 21386989 SHEET NO. 3 OF 38

21386989

\*ROCK LINED

40-MIL THICKNESS

EROSION CONTROL MAT OR TURF

REINFORCEMENT

40-MIL THICKNESS

--- SEEDING & SOIL

FORMULA D

varies<sup>l</sup>

SLOPES STEEPER THAN 3:1

NOT TO SCALE

SEEDING & SOIL SUPPLEMENTS FORMULA L OR D

**DITCHES AND CHANNELS** 

OP OF CUT SECTION

NOT TO SCALE

REINFORCEMENT

VARIES

SEEDING & SOIL SUPPLEMENTS FORMULA D

SUPPLEMENTS-

WHERE INDICATED

SEEDING & SOIL

SUPPLEMENTS -

FORMULA L —

SHOULDER-

\*INSTALL MULCH

MAT ON SLOPE

CONTROL NETTING -


STEEPER THAN 3:1


(SEE CROSS SECTION)


STEEPER THAN 3:1-

## SOIL USE LIMITATIONS AND RESOLUTIONS

SOIL TYPE	SUITABILITY OF MATERIAL FOR:			SOIL FEATURES THAT AFFECT ENGINEERING PRACTICES					
SERIES AND MAP SYMBOL	SAND AND GRAVEL	WINTER GRADING	ROAD FILL	TOPSOIL	DRAINAGE	POND RESERVOIR AREAS	EMBANKMENTS, DIKES, AND LEVEES	RESOLUTIONS	
DUFFIELD SILT LOAM	POOR	FAIR TO GOOD	FAIR	GOOD	SINKHOLE DEVELOPMENT	PERMEABLE SUBSTRATUM AND		THIS SOIL EXISTS AT THE OFFICE PARK SITE. DUFFIELD SOILS ARE	
DuB2	room	TAIN TO GOOD	TAIR	GOOD	SHAKITOLL DEVELOT WEIGH	EXCESSIVE SEEPAGE	LACKS STABILITY	SUSCEPTIBLE TO SINKHOLES. THIS SOIL IS SUITABLE FOR TOPSOIL.	
LAWRENCEVILLE SILT LOAM	POOR	POOR	FAIR	GOOD	SEASONAL HIGH WATER TABLE	MODERATELY SLOW PERMEABILITY	UNSTABLE	THIS SOIL EXISTS AT THE OFFICE PARK ENTRANCE AND ALONG RAMP L.	
LeB2	POOR	FOON	LAIN	GOOD	SLASONAL HIGH WATER TABLE	WODENATELT SLOW FERWIEABILITY	ONSTABLE	THIS SOIL IS SUITABLE FOR TOPSOIL.	
MADE LAND, LIMESTONE MATERIALS	POOR	POOR FAIR FAIR	EAID	IR UNSUITABLE	-		DOOD STADILITY	THIS SOIL EXISTS AT THE LOCATION OF THE PROPOSED UNDERGROUND BASIN AS WELL AS THE LOCATION OF THE EXISTING BASIN.	
Мс	FOON		FAIN			PERMEABLE SUBSTRATUM	POOR STABILITY	MADE LAND SOILS NEED TO BE REINFORCED WHEN UTILIZING THE SOIL AND IT IS UNSTABLE FOR EMBANKMENT, DIKES, AND LEVEES.	

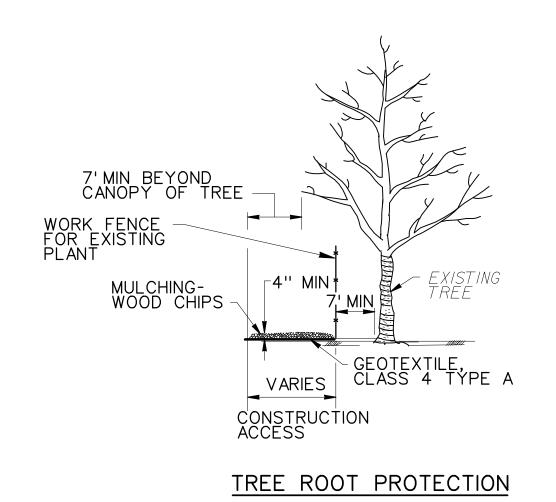

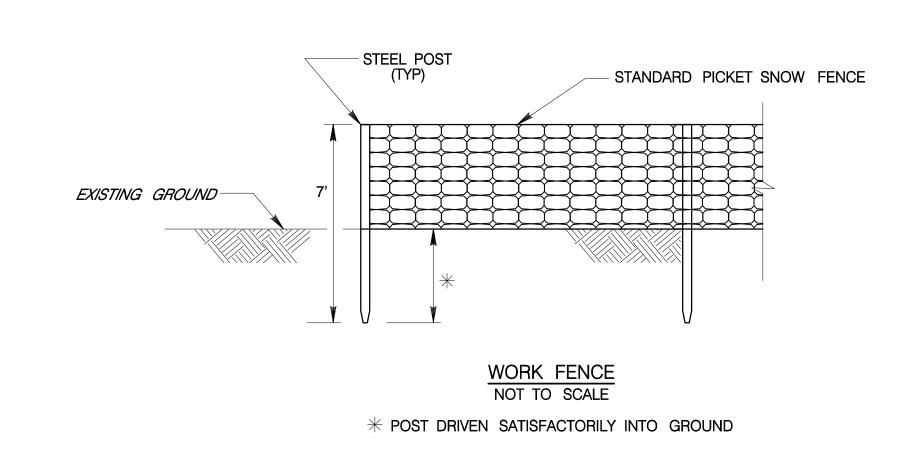

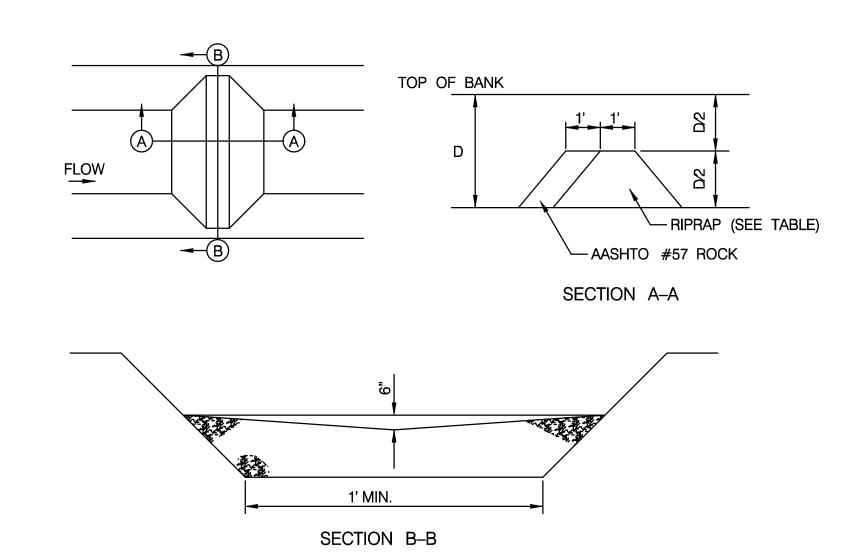

ROCK FILTER NO.	LOCATION	D (FT)	RIPRAP SIZE
1	AT OUTLET A12	1	R-2
2	AT EXISTING HEADWALL EW1	3	R-3
3	AT WESTERN CORNER OF PROPERTY	1	R–2

Sediment must be removed when accumulations reach 1/2 the height of the filters.

Immediately upon stabilization of each channel, remove accumulated sediment, remoe Rock Filter, and stabilize disturbed areas.

ROCK FILTERS
NOT TO SCALE



PREPARED BY: **URS** FORT WASHINGTON, PA YUEN LING EDWINA LAM SCALE AS NOTED

NO. DATE REVISIONS EROSION & SEDIMENT POLLUTION CONTROL SOIL TABLE AND E&S DETAILS LIBERTY PROPERTY TRUST 180 SOUTH WARNER ROAD
UPPER MERION TOWNSHIP, MONTGOMERY COUNTY, PENNSYLVANIA

URS CORPORATION

21386989 Consulting Engineers 335 Commerce Drive • Suite 300 • Fort Washington • PA • 19034-2623 (215) 367-2500 • Fax (215) 367-1000 FIELD BOOK 21386989

DRAWN BY CHECKED BY SML


SHEET NO. 4 OF 38

NOTE:

CONTRACTOR WILL BE RESPONSIBLE FOR THE PROPER CONSTRUCTION, STABILIZATION AND MAINTENANCE OF ALL EROSION AND SEDIMENT POLLUTION CONTROLS AND RELATED ITEMS INCLUDED WITHIN THIS EROSION AND SEDIMENT POLLUTION CONTROL PERMIT.

#### TEMPORARY CHANNEL LININGS

SWALE ID	LOCATION ON SITE	BOTTOM WIDTH B (ft)	LT SIDE SLOPE (1:Z1)	RT SIDE SLOPE (1:Z2)	MAX DEPTH D (ft)	CHANNEL LINING	STAPLE PATTERN
S1	IN FRONT OF PROPOSED BUILDING	2.00	3	3	0.31	EROSION CONTROL MULCH BLANKET	D
S4	NORTHERN HALF OF SWALE IN FRONT OF 190 S. WARNER RD	2.00	3	3	0.33	EROSION CONTROL MULCH BLANKET	D
S5	SOUTHERN HALF OF SWALE IN FRONT OF 190 S. WARNER RD	2.00	3	3	0.54	EROSION CONTROL MULCH BLANKET	D
S6	SWALE LEADING TO BASIN II	2.00	3	3	0.87	EROSION CONTROL MULCH BLANKET	D

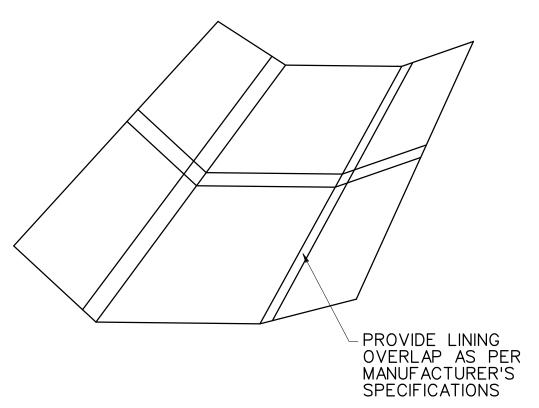

ECMB LINING INSTALLATION


WOOD POSTS-

HEIGHT OF ROCK FILTER=

5/6 HEIGHT SILT FENCE

OR STRAW BALES

1'-0''

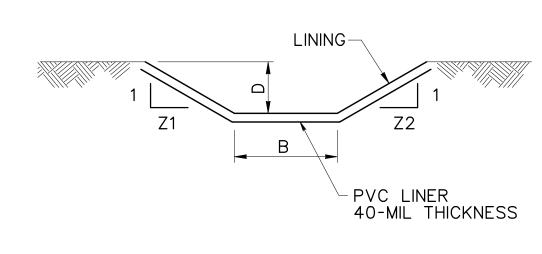


CHANNEL CROSS-SECTION

# ← 6.67 FT. >

STAPLE PATTERN "D"

NOT TO SCALE

3.4 STAPLES PER SQUARE YARD USING 6 IN., 11 GA WIRE ''U'' STAPLES. 8 IN. STAPLES AND LONGER MAY BE USED FOR LOOSE SOILS. 9 GA STAPLES OR HEAVIER MAY BE NECESSARY IN HARD OR ROCKY SOILS. SECURE BLANKETS TO SOIL BY PLACING A STAPLE/STAKE THROUGH EACH YELLOW COLORED DOT.

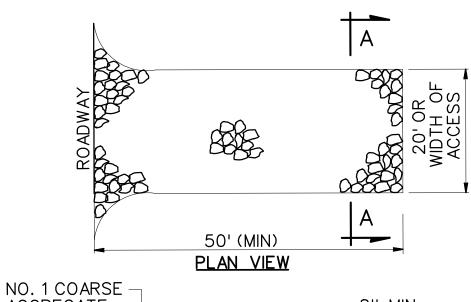


ROCK CONSTRUCTION ENTRANCE


NOT TO SCALE

NOTES:

- CONSTRUCT ROCK CONSTRUCTION ENTRANCES AT ALL PROJECT ACCESS POINTS.
- CONSTANTLY MAINTAIN STRUCTURE'S THICKNESS TO THE SPECIFIC DIMENSIONS BY ADDING ROCK. MAINTAIN A STOCKPILE ON SITE FOR THIS PURPOSE.
- AT END OF EACH CONSTRUCTION DAY, REMOVE ALL SEDIMENT DEPOSITED ON PUBLIC ROADS & RETURN SEDIMENT TO CONSTRUCTION SITE.

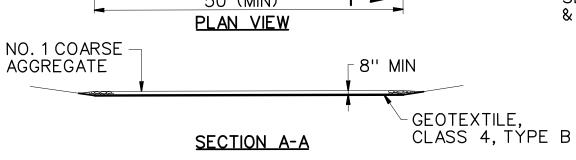

- 1. SHOP DRAWINGS FOR THE PVC LINER AND GEOTEXTILE FABRIC SHALL BE SUBMITTED TO THE TOWNSHIP FOR REVIEW PRIOR TO
- 2. A LINER MANUFACTURER REPRESENTATIVE SHALL BE PRESENT TO CERTIFY INSTALLATION OF THE LINER AND SEALING OF THE SEAMS.

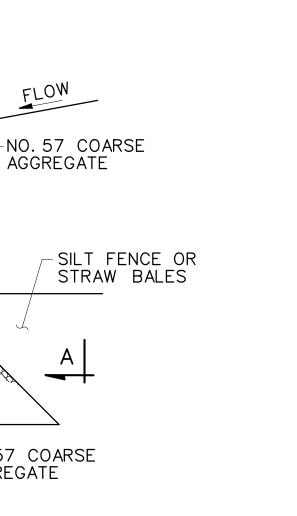





AGGREGATE

-NO. 57 COARSE

- INSTALLATION.



NOT TO SCALE 1. SEDIMENT MUST BE REMOVED WHEN ACCUMULATIONS

<u>ELEVATION</u>

2. PLACE ROCK FILTER OUTLET ALONG UPLAND STRAW BALE BARRIER AS INDICATED ON PLANS.

REACH ONE THIRD THE HEIGHT OF THE OUTLET.

3'-0" MIN 8'-0" MAX


- 3. PLACE ROCK FILTER OUTLET ALONG DOWNLAND STRAW BALE BARRIER AS INDICATED ON PLANS.
- 4. ROCK FILTER OUTLETS ALSO TO BE PLACED AS NECESSARY IN THE EVENT OF STRAW BALE OR SILT FENCE BARRIER FAILURE.

-ROCK, CLASS R-3

SECTION A-A

NOT TO SCALE


ROCK FILTER OUTLET

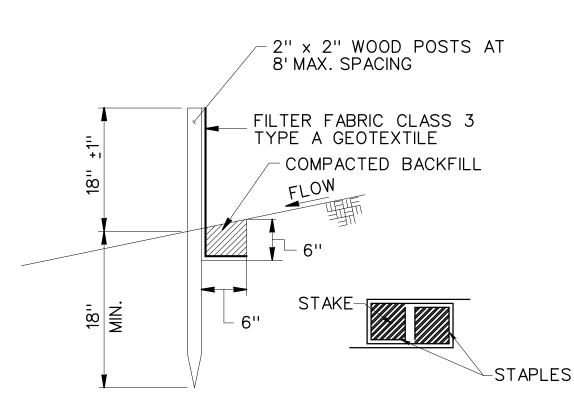

1. SILT FENCE MUST BE INSTALLED AT EXISTING GRADE. BOTH ENDS OF FENCE MUST BE EXTENDED AT LEAST 8 FEET UPSLOPE 45° TO MAIN FENCE ALIGNMENT.

2. SEDIMENT MUST BE REMOVED WHERE ACCUMULATIONS

3. ANY FENCE SECTION WHICH HAS BEEN UNDERMINED OR TOPPED MUST BE IMMEDIATELY REPLACED WITH A ROCK FILTER OUTLET. SEE ROCK FILTER OUTLET DETAIL.

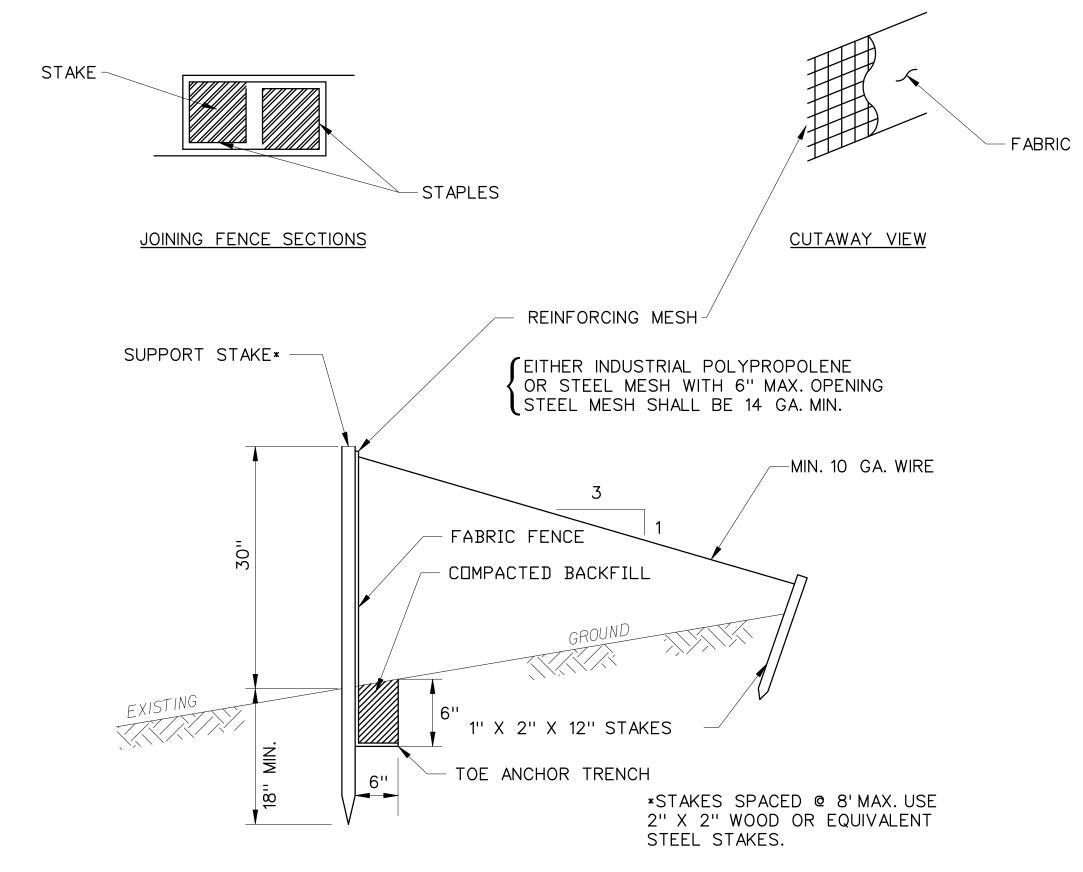

SILT BARRIER FENCE, 30" HEIGHT NOT TO SCALE



21386989

FIELD BOOK

21386989

SHEET NO.

5 OF 38

REACH HALF THE ABOVE GROUND FENCE HEIGHT.

PREPARED BY: **URS** FORT WASHINGTON, PA YUEN LING EDWINA LAM

NO. DATE REVISIONS EROSION AND SEDIMENT POLLUTION CONTROL DETAILS LIBERTY PROPERTY TRUST 180 SOUTH WARNER ROAD

DRAWN BY CHECKED BY


SML

UPPER MERION TOWNSHIP, MONTGOMERY COUNTY, PENNSYLVANIA URS CORPORATION Consulting Engineers 335 Commerce Drive · Suite 300 · Fort Washington · PA · 19034-2623 (215) 367-2500 · Fax (215) 367-1000

AS NOTED

NOTE:

CONTRACTOR WILL BE RESPONSIBLE FOR THE PROPER CONSTRUCTION, STABILIZATION AND MAINTENANCE OF ALL EROSION AND SEDIMENT POLLUTION CONTROLS AND RELATED ITEMS INCLUDED WITHIN THIS EROSION AND SEDIMENT POLLUTION CONTROL PERMIT.

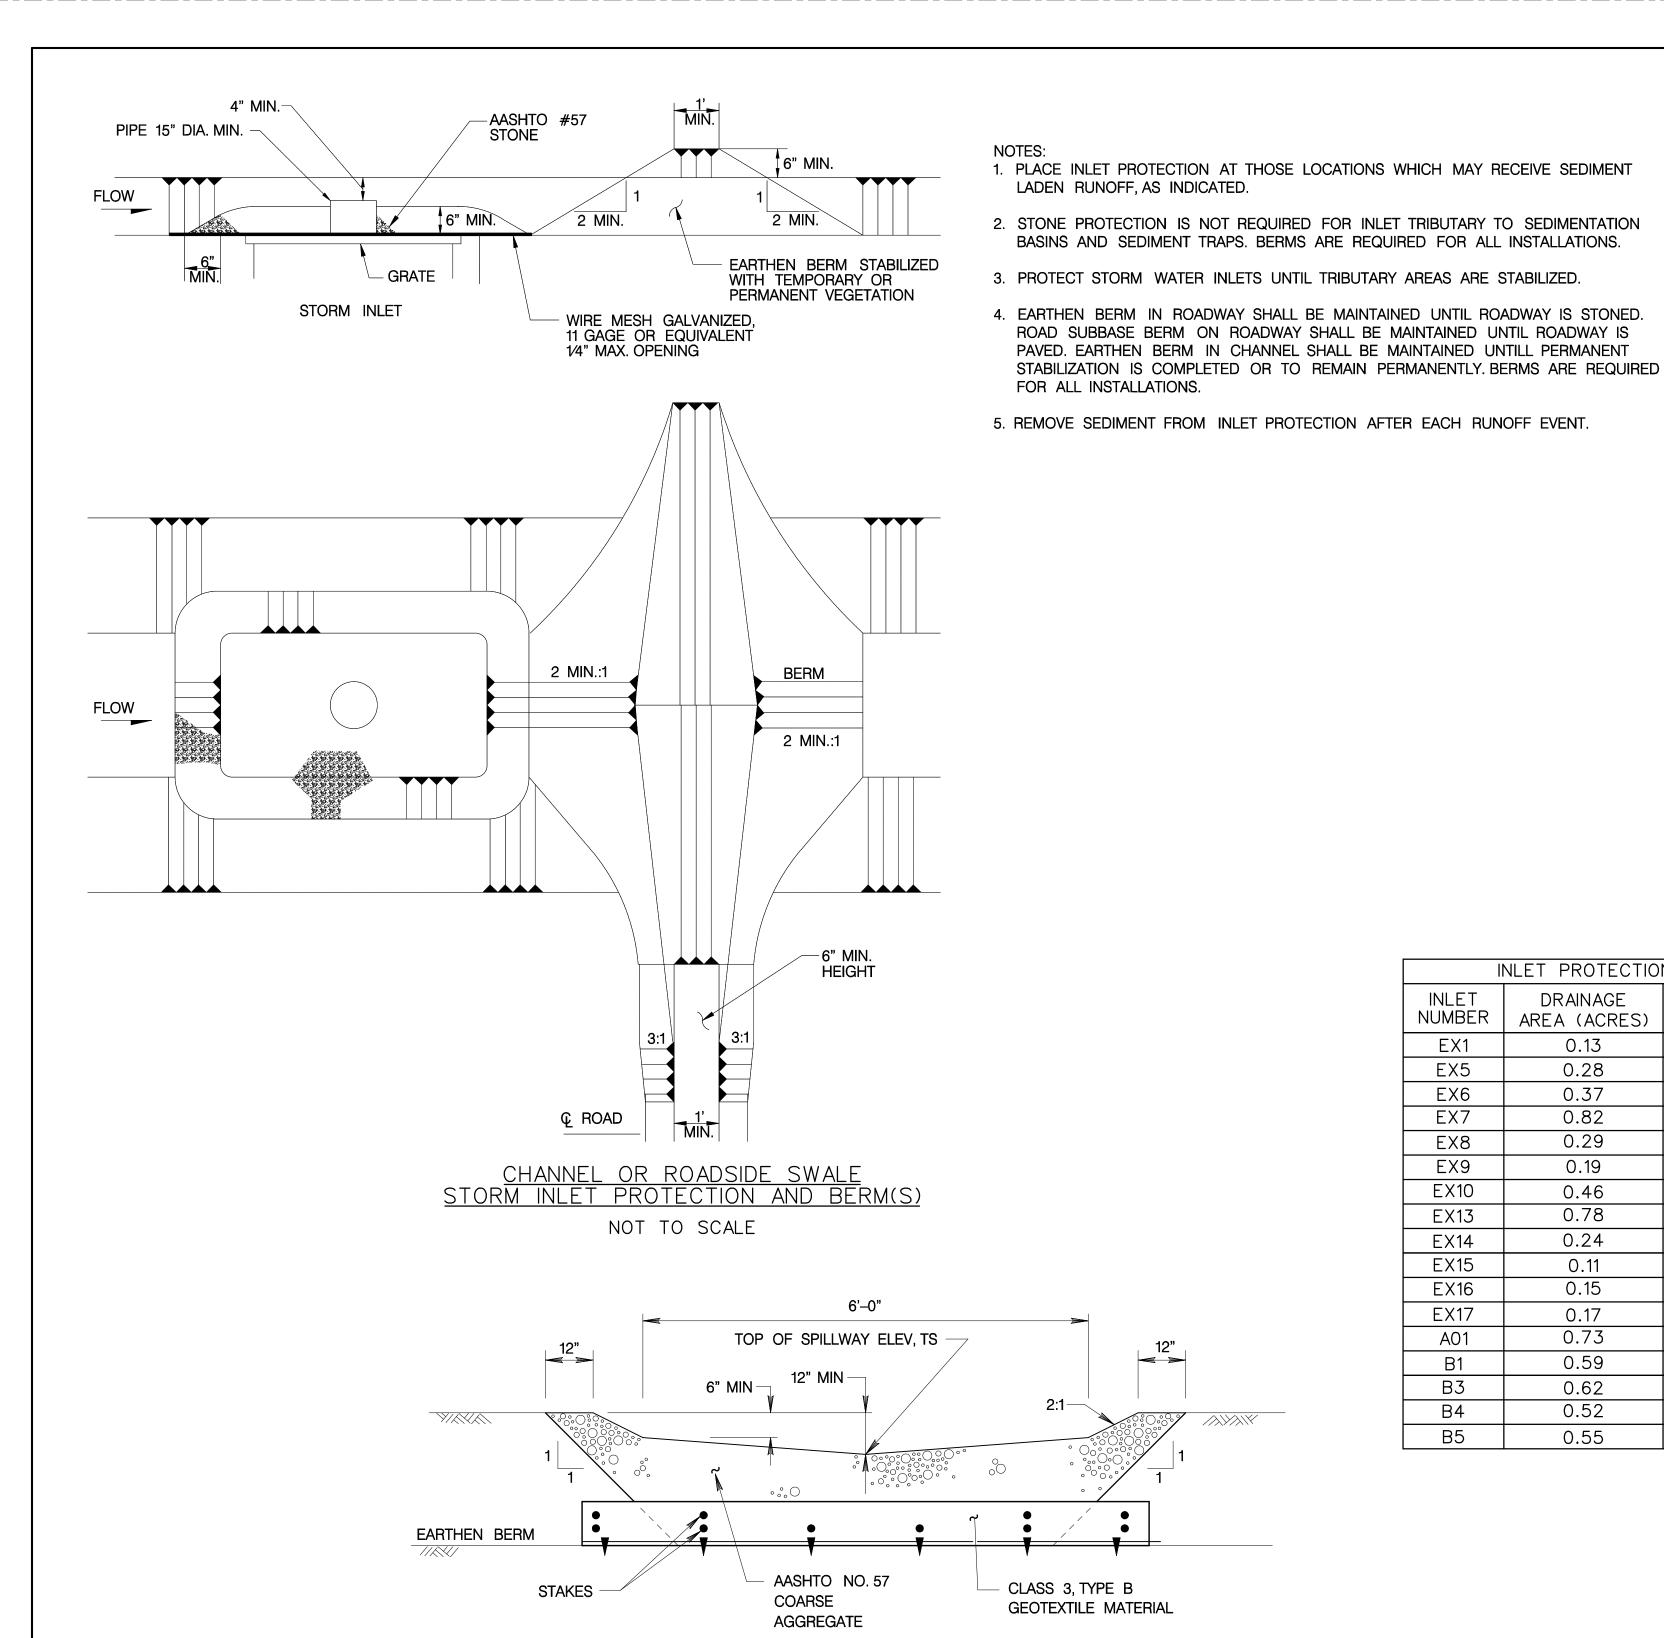

TOP OF

BERM

1'–0"

MIN


AASHTO NO.1

AGGREGATE

OR R-3 ROCK

COARSE

	NLET PROTECTIO	N
INLET NUMBER	DRAINAGE AREA (ACRES)	TYPE
EX1	0.13	IN ROAD
EX5	0.28	IN ROAD
EX6	0.37	IN ROAD
EX7	0.82	OFF ROAD
EX8	0.29	IN ROAD
EX9	0.19	IN ROAD
EX10	0.46	IN ROAD
EX13	0.78	OFF ROAD
EX14	0.24	IN ROAD
EX15	0.11	IN ROAD
EX16	0.15	IN ROAD
EX17	0.17	IN ROAD
A01	0.73	OFF ROAD
B1	0.59	OFF ROAD
В3	0.62	OFF ROAD
B4	0.52	OFF ROAD
B5	0.55	OFF ROAD

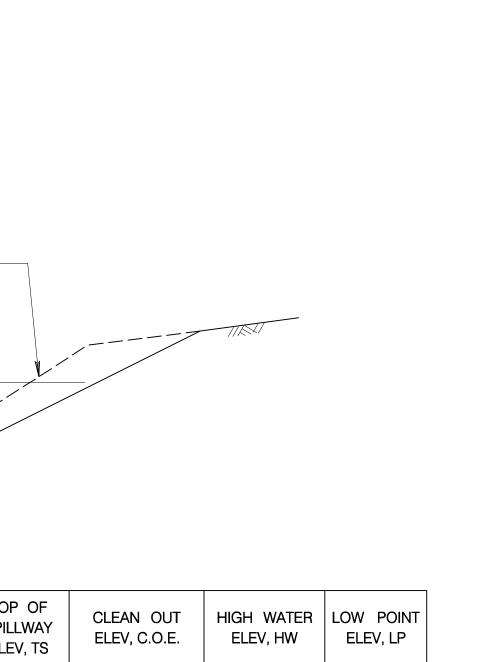


NOTE:

CONTRACTOR WILL BE RESPONSIBLE FOR THE PROPER

ALL EROSION AND SEDIMENT POLLUTION CONTROLS AND RELATED ITEMS INCLUDED WITHIN THIS EROSION AND


CONSTRUCTION, STABILIZATION AND MAINTENANCE OF

SEDIMENT POLLUTION CONTROL PERMIT.

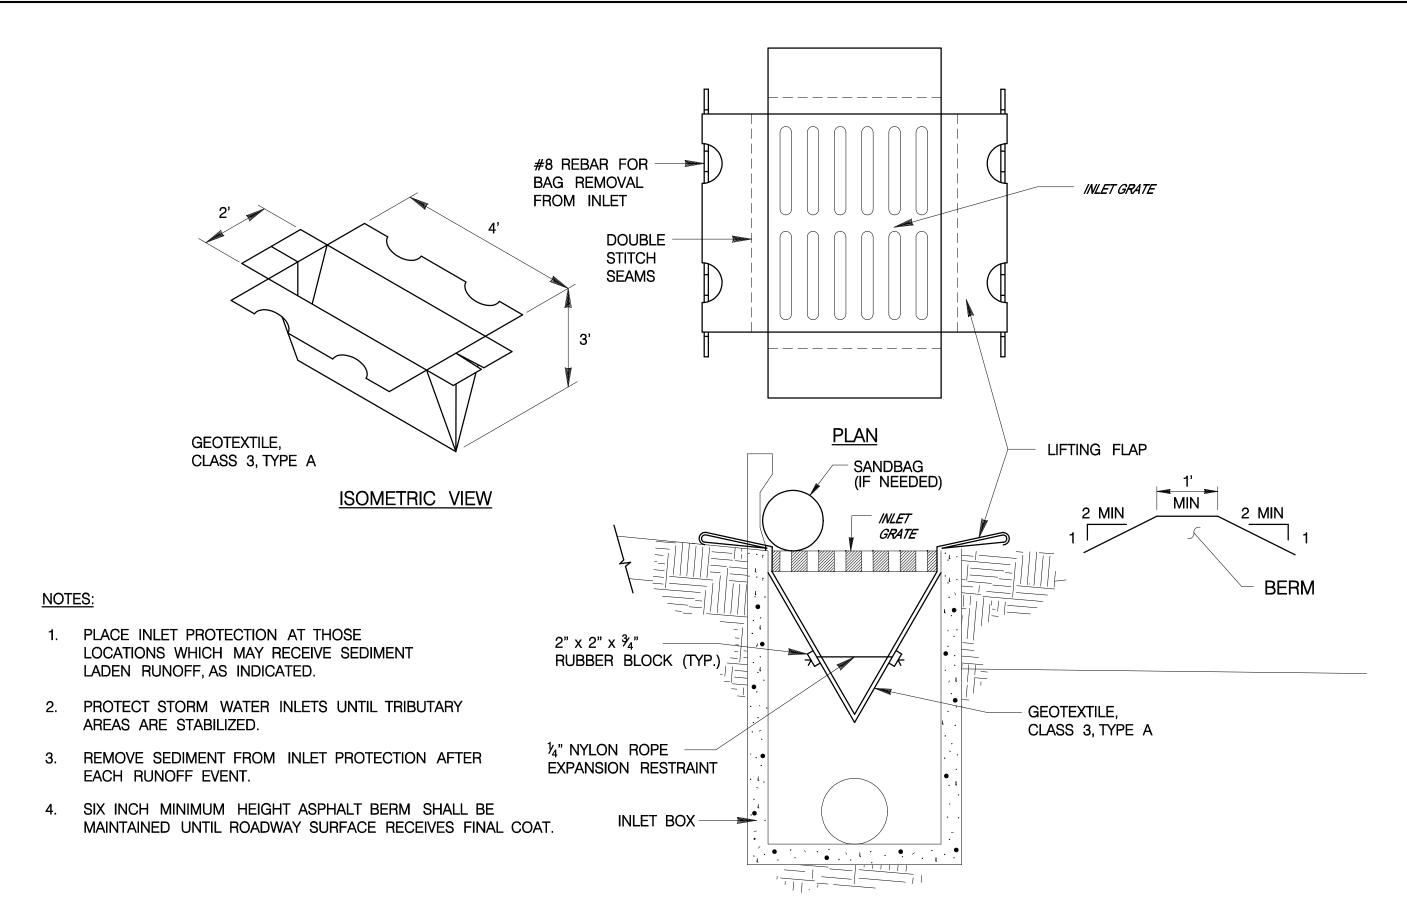


#### **ELEVATION**

#### INLET PROTECTION - IN ROAD NOT TO SCALE

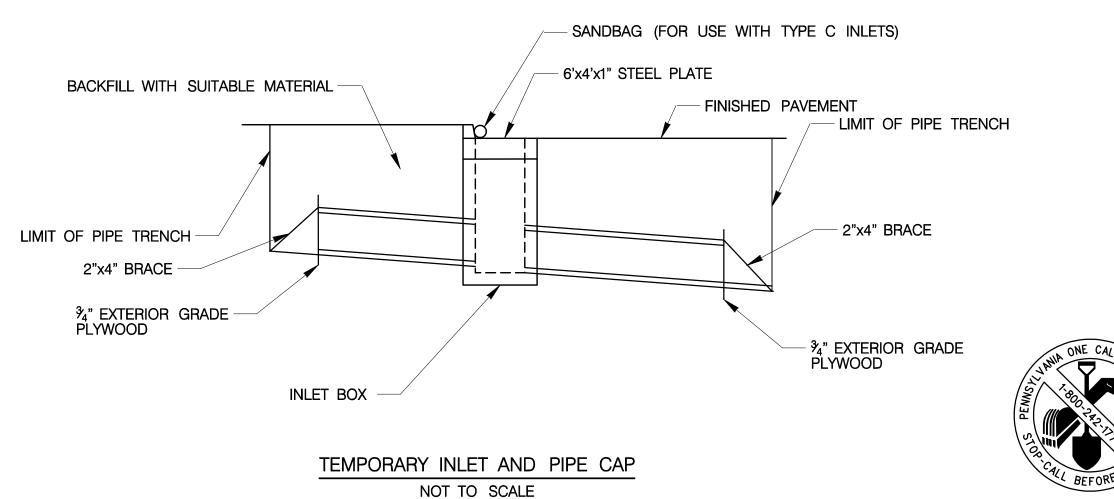



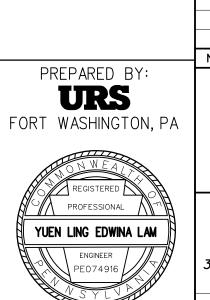

AS NOTED

NO. DATE REVISIONS EROSION & SEDIMENT POLLUTION CONTROL DETAILS LIBERTY PROPERTY TRUST 180 SOUTH WARNER ROAD UPPER MERION TOWNSHIP, MONTGOMERY COUNTY, PENNSYLVANIA

URS CORPORATION Consulting Engineers

21386989 335 Commerce Drive · Suite 300 · Fort Washington · PA · 19034-2623 (215) 367-2500 · Fax (215) 367-1000 FIELD BOOK 21386989 SHEET NO. DRAWN BY CHECKED BY

SML

6 OF 38

- CLASS 3, TYPE B GEOTEXTILE MATERIAL TOP OF TOP OF BERM SEDIMENT TRAP **SPILLWAY** ELEV, TB ELEV, TS 195.00 193.87 192.20 194.00 190.00 186.85 186.00

2:1---

**INSIDE FACE** 

TOP OF

**SPILLWAY** 

ELEV, TS

<u>5'-0"</u>

AASHTO NO. 57

COARSE

6" MIN -

EMBANKMENT SEDIMENT TRAP LAND II

NOT TO SCALE

AGGREGATE

/<u>}</u>}}

EXISTING GROUND

- CLEAN OUT ELEV, C.O.E.

- HIGH WATER ELEV, HW

LOW POINT ELEV, LP

### CONSTRUCTION SEQUENCE FOR SOIL EROSION CONTROL

#### NOTE

PA ONE CALL MUST BE NOTIFIED PRIOR TO THE START OF ANY EARTHMOVING ACTIVITIES.

ALL EARTH DISTURBANCE ACTIVITIES SHALL PROCEED IN ACCORDANCE WITH THE FOLLOWING SEQUENCE. EACH STAGE SHALL BE COMPLETED BEFORE ANY FOLLOWING STAGE IS INITIATED. CLEARING AND GRUBBING SHALL BE LIMITED ONLY TO THOSE AREAS DESCRIBED IN EACH STAGE.

AT LEAST 7 DAYS BEFORE STARTING ANY EARTH DISTURBANCE ACTIVITIES, THE OPERATOR SHALL INVITE ALL CONTRACTORS INVOLVED IN THOSE ACTIVITIES, THE LANDOWNER, ALL APPROPRIATE MUNICIPAL OFFICIALS, THE EROSION AND SEDIMENT CONTROL PLAN PREPARER, AND THE MONTGOMERY COUNTY CONSERVATION DISTRICT TO AN ON-SITE MEETING. ALSO, AT LEAST 3 DAYS BEFORE STARTING ANY EARTH DISTURBANCE ACTIVITIES, ALL CONTACTORS INVOLVED IN THOSE ACTIVITIES SHALL NOTIFY THE PENNSYLVANIA ONE CALL SYSTEM INCORPORATED AT 1-800-242-1776 FOR BURIED UTILITIES LOCATIONS.

#### STAGE 1

- 1. INSTALL 30" SILT FENCE AND 18" SILT FENCE AS INDICATED IN THE PLANS.
- 2. INSTALL ROCK CONSTRUCTION ENTRANCE AS INDICATED IN THE PLANS.
- 3. INSTALL INLET PROTECTION ON THE EXISTING INLETS A01, B3, EX1, EX2, EX5, EX6, EX10, AND EX14 AS SHOWN ON THE PLANS.
- 4. PERFORM ADVANCE CLEARING AND GRUBBING OPERATIONS WITHIN STAGE LIMIT OF DISTURBANCE
- 5. CONSTRUCT AND STABILIZE 150' PORTION OF RETAINING WALL ALONG THE PARKING LOT FROM THE NORTHEAST CORNER TO THE EXISTING HEADWALL. TEMPORARY PUMPING MUST BE PROVIDED SHOULD THE FOUNDATION PIT FOR THE PROPOSED WALL BECOME INUNDATED WITH RUNOFF AFTER STORM EVENT. DISCHARGE INTO A SEDIMENT FILTER BAG. CONSTRUCT AND STABILIZE SEDIMENT TRAP I AND SPILLWAY. LIMIT CLEARING AND GRUBBING OPERATIONS TO AREAS NEEDED FOR SEDIMENT TRAP I INSTALLATION. SEDIMENT TRAP TO BE STABILIZED AND FUNCTIONING PROPERLY PRIOR TO ANY FURTHER EARTH DISTURBANCE ACTIVITIES. SEDIMENT TRAP MUST BE PROTECTED FROM UNAUTHORIZED ACTS OF THIRD PARTIES. STABILIZE DISTURBED AREA IMMEDIATELY WITH PROPER SEEDING AND MULCHING. SEE SEEDING AND MULCHING NOTES SHEET.
- 6. CONSTRUCT AND STABILIZED UNDERGROUND STORMWATER MANAGEMENT BASIN SYSTEM A06, A07, A09, A10 AND A11. CONSTRUCT AND STABILIZE STORM SEWER SYSTEM A02, A03, A03A, A04 AND A05 AS SHOWN ON THE PLANS. CONNECT EXISTING 4 9/32 PVC PIPE INTO INLET STRUCTURE A05. TEMPORARILY CAP INLETS A02, A03, A03A, A04 AND A05 TO PREVENT STORMWATER FROM ENTERING SYSTEM. SEE EROSION AND SEDIMENT POLLUTION CONTROL DETAIL.
- 7. CONSTRUCT AND STABILIZE UPPER PORTION OF PARKING LOT UP TO THE TOP OF THE SEDIMENT TRAP LINCLUDING CURBING, PAVEMENT, DRIVEWAYS, LIGHTING AND LANDSCAPING. STABILIZE DISTURBED AREA IMMEDIATELY WITH PROPER SEEDING AND MULCHING. SEE SEEDING AND MULCHING NOTES AND LANDSCAPING NOTES AND PLANS.
- 8. CONSTRUCT AND STABILIZE OFFICE BUILDING. CONSTRUCT GREEN ROOF. SEE BUILDING PLANS FOR GREEN ROOF CONSTRUCTION. STABILIZE GREEN ROOF WITH PERMANENT PLANTING. SEE LANDSCAPING NOTES AND PLANS. CONNECT ROOF DRAIN TO EXISTING STORM SEWER B3.
- 9. CONSTRUCT AND STABILIZE THE RETAINING WALL IN THE BACK OF EXISTING BUILDING (170 SOUTH WARNER ROAD). TEMPORARY PUMPING MUST BE PROVIDED SHOULD THE FOUNDATION PIT FOR THE PROPOSED WALL BECOME INUNDATED WITH RUNOFF AFTER STORM EVENT. DISCHARGE INTO SEDIMENT TRAP 1.
- 10. REMOVE EXISTING INLET EX14 AND CAP THE PIPE AT THE END. CONSTRUCT AND STABILIZE THE PARKING LOT IN THE BACK OF THE EXISTING AND PROPOSED BUILDING INCLUDING CURBING, PAVEMENT, PARKING LOT, LIGHTING AND LANDSCAPING. STABILIZE DISTURBED AREA IMMEDIATELY WITH PROPER SEEDING AND MULCHING. SEE SEEDING AND MULCHING NOTES AND LANDSCAPING NOTES AND PLANS.
- 11. INSTALL ROCK FILTER #1 AS SHOWN ON THE PLANS.
- 12. REMOVE EMBANKMENT SEDIMENT TRAP I. REMOVE DOWNSTREAM EXISTING PIPE FROM INLET A01 AND EXISTING HEADWALL. CONSTRUCT AND STABILIZE STORM SEWER SYSTEM A01 TO A02 AND OUTLET PIPE OF UNDERGROUND STORMWATER MANAGEMENT BASIN A11 AND A12. CONSTRUCT AND STABILIZE THE REMAINING PORTION OF THE RETAINING WALL. INSTALL RIPRAP APRON AT THE OUTLET OF A12.
- 13. CONSTRUCT AND STABILIZE THE REMAINING PORTION OF PARKING LOT INCLUDING CURBING, PAVEMENT, DRIVEWAY, TRASH AREA, LIGHTING AND LANDSCAPING. STABILIZE DISTURBED AREA IMMEDIATELY WITH PROPER SEEDING AND MULCHING. SEE SEEDING AND MULCHING NOTES AND LANDSCAPING NOTES AND PLANS.
- 14. REMOVE TEMPORARY INLET CAPS. REMOVE INLET PROTECTION ON INLETS A01 AND EX14, ROCK CONSTRUCTION ENTRANCE, 18" AND 30" SILT FENCE AND ROCK FILTER \*1 AS SHOWN ON THE PLANS UPON ESTABLISHMENT OF PERMANENT VEGETATION AND SITE STABILIZATION. AREAS DISTURBED DURING THE REMOVAL OF DEVICES MUST BE STABILIZED IMMEDIATELY. SEE SEEDING AND MULCHING NOTES.

#### STAGE 2

- 1. INSTALL WORK FENCE AROUND THE EXISTING TREES AS SHOWN ON THE PLANS.
- 2. INSTALL INLET PROTECTION ON THE EXISTING INLETS EX 8, EX9, EX15, EX16, AND EX17 AS SHOWN ON THE PLANS.
- 3. INSTALL 18" SILT FENCE ALONG THE ENTRANCE DRIVEWAY AS INDICATED IN THE PLANS.
- 4. INSTALL ROCK CONSTRUCTION ENTRANCE AS INDICATED IN THE PLANS.
- 5. PERFORM ADVANCE CLEARING AND GRUBBING OPERATIONS WITHIN STAGE LIMIT OF DISTURBANCE.
- 6. CONTINUE THE CONSTRUCTION OF OFFICE BUILDING.
- 7. CONSTRUCT AND STABILIZE STORM SEWER SYSTEM EX5, B1 AND B2 AS SHOWN ON THE PLANS. INSTALL INLET PROTECTION. CONSTRUCT AND STABILIZE PORTION OF SWALE S1 AND INSTALL PVC LINER AS SHOWN ON THE PLANS. SHOP DRAWINGS FOR THE PVC LINER AND GEOSYNTHETIC FABRIC ARE TO BE SUBMITTED TO THE TOWNSHIP FOR REVIEW PRIOR TO INSTALLATION. A LINER MANUFACTURER REPRESENTATIVE IS TO BE PRESENT TO CERTIFY INSTALLATION OF THE LINER AND THE SEALING OF THE SEAMS.
- 8. REMOVE EXISTING INLET EX7 AND EXISTING PIPE FROM EX7 TO EX5.
- 9. CONSTRUCT AND STABILIZE PARKING LOT INCLUDING CURBING, CURB RAMP, SIDEWALK, CURB CUT CC2, PAVEMENT, DRIVEWAY, LIGHTING AND LANDSCAPING. INSTALL RIPRAP APRON AT THE END OF CURB CUT CC2 AS SHOWN ON THE PLANS. STABILIZE DISTURBED AREA IMMEDIATELY WITH PROPER SEEDING AND MULCHING. SEE SEEDING AND MULCHING NOTES AND LANDSCAPING NOTES AND PLANS.
- 10. REMOVE INLET PROTECTION ON INLETS B1, EX8, EX15, EX16, AND EX17, ROCK CONSTRUCTION ENTRANCE, WORK FENCE FOR EXISTING TREE PROTECTION AND 18" SILT FENCE AS SHOWN ON THE PLANS UPON ESTABLISHMENT OF PERMANENT VEGETATION AND SITE STABILIZATION. AREAS DISTURBED DURING THE REMOVAL OF DEVICES MUST BE STABILIZED IMMEDIATELY. SEE SEEDING AND MULCHING NOTES.

#### STAGE 3

- 1. INSTALL WORK FENCE AROUND THE STAGE LIMIT OF DISTURBANCE.
- 2. INSTALL ROCK FILTER #2 AND #3 AS SHOWN ON THE PLANS.
- 3. INSTALL INLET PROTECTION ON THE EXISTING INLET EX13.
- 4. INSTALL ROCK CONSTRUCTION ENTRANCE AS INDICATED IN THE PLANS.
- 5. CONSTRUCT AND STABILIZE SEDIMENT TRAP II AND SPILLWAY. LIMIT CLEARING AND GRUBBING OPERATION TO AREAS NEEDED FOR SEDIMENT TRAP II INSTALLATION. SEDIMENT TRAP TO BE STABILIZED AND FUNCTIONING PROPERLY PRIOR TO ANY FURTHER EARTH DISTURBANCE ACTIVITIES. SEDIMENT TRAP MUST BE PROTECTED FROM UNAUTHORIZED ACTS OF THIRD PARTIES.
- 6. PERFORM ADVANCE CLEARING AND GRUBBING OPERATIONS WITHIN STAGE LIMIT OF DISTURBANCE
- 7. CONSTRUCT AND STABILIZE STORM SEWER B7 AND B8. INSTALL RIPRAP APRON AT THE END OF HEADWALL B8. CONSTRUCT AND STABILIZE PORTION OF SWALE S6 AND PVC LINER AS SHOWN ON THE PLANS. SHOP DRAWINGS FOR THE PVC LINER AND GEOSYNTHETIC FABRIC ARE TO BE SUBMITTED TO THE TOWNSHIP FOR REVIEW PRIOR TO INSTALLATION. A LINER MANUFACTURER REPRESENTATIVE IS TO BE PRESENT TO CERTIFY INSTALLATION OF THE LINER AND THE SEALING OF THE SEAMS. INSTALL THE TURF REINFORCEMENT MAT AS SHOWN ON THE PLANS. STABILIZE DISTURBED AREA IMMEDIATELY WITH PROPER SEEDING AND MULCH. SEE SEEDING AND MULCHING NOTES.
- 8. REGRADE THE LEFT SIDE OF EXISTING SWALE S8 AS SHOWN ON THE PLANS. STABILIZE DISTURBED AREA IMMEDIATELY WITH PROPER SEEDING AND MULCH. SEE SEEDING AND MULCHING NOTES.
- 9. CONSTRUCT AND STABILIZE THE PARKING LOT INCLUDING CURBING, PAVEMENT, DRIVEWAY, TRASH AREA, LIGHTING AND LANDSCAPING. STABILIZE DISTURBED AREA IMMEDIATELY WITH PROPER SEEDING AND MULCHING. SEE SEEDING AND MULCHING NOTES AND LANDSCAPING NOTES AND PLANS.
- 10. REMOVE INLET PROTECTION ON INLETS EX13 AND ROCK CONSTRUCTION ENTRANCE AS SHOWN ON THE PLANS UPON ESTABLISHMENT OF PERMANENT VEGETATION AND SITE STABILIZATION. AREAS DISTURBED DURING THE REMOVAL OF DEVICES MUST BE STABILIZED IMMEDIATELY. SEE SEEDING AND MULCHING NOTES.

#### STAGE 4

1. INSTALL ROCK CONSTRUCTION ENTRANCE AS INDICATED IN THE PLANS.

- 2. PERFORM ADVANCE CLEARING AND GRUBBING OPERATIONS WITHIN STAGE LIMIT OF DISTURBANCE.
- 3. CONSTRUCT AND STABILIZE THE REMAINING PORTION OF SWALE S1 AND PVC LINER AS SHOWN ON THE PLANS. SHOP DRAWINGS FOR THE PVC LINER AND GEOSYNTHETIC FABRIC ARE TO BE SUBMITTED TO THE TOWNSHIP FOR REVIEW PRIOR TO INSTALLATION. A LINER MANUFACTURER REPRESENTATIVE IS TO BE PRESENT TO CERTIFY INSTALLATION OF THE LINER AND THE SEALING OF THE SEAMS. STABILIZE DISTURBED AREA IMMEDIATELY WITH PROPER SEEDING AND MULCHING NOTES.
- 4. CONSTRUCT AND STABILIZE PARKING LOT INCLUDING CURBING, CURB RAMP, SIDEWALK, CURB CUT CC3, PAVEMENT, DRIVEWAY, LIGHTING AND LANDSCAPING. INSTALL RIPRAP APRON AT THE END OF CURB CUT CC3. STABILIZE DISTURBED AREA IMMEDIATELY WITH PROPER SEEDING AND MULCHING. SEE SEEDING AND MULCHING NOTES AND LANDSCAPING NOTES AND PLANS.
- 5. REMOVE INLET PROTECTION ON INLETS B2, EX1, EX2, EX5, EX6, EX9 AND EX10, AND ROCK CONSTRUCTION ENTRANCE AS SHOWN ON THE PLANS UPON ESTABLISHMENT OF PERMANENT VEGETATION AND SITE STABILIZATION. AREAS DISTURBED DURING THE REMOVAL OF DEVICES MUST BE STABILIZED IMMEDIATELY. SEE SEEDING AND MULCHING NOTES.

#### STAGE 4


- 1. INSTALL ROCK CONSTRUCTION ENTRANCE AS INDICATED IN THE PLANS.
- 2. PERFORM ADVANCE CLEARING AND GRUBBING OPERATIONS WITHIN STAGE LIMIT OF DISTURBANCE.
- 3. REMOVE EXISTING INLET EX12 AND THE EXISTING DOWNSTREAM PIPE. CONSTRUCT AND STABILIZE STORM SEWER SYSTEM B3, B4 AND B5 AS SHOWN ON THE PLANS. CONNECT PIPE FROM B5 TO THE EXISTING EX12 INVERT. RE-CONNECT ROOF DRAIN TO B3. CONNECT PROPOSED PIPE FROM B5 TO EXISTING MANHOLE MH2. INSTALL INLET PROTECTION.
- CONSTRUCT AND STABILIZE THE REMAINING PORTION OF SWALE S6 AND PVC LINER AS SHOWN ON THE PLANS. SHOP DRAWINGS FOR THE PVC LINER AND 4. GEOSYNTHETIC FABRIC ARE TO BE SUBMITTED TO THE TOWNSHIP FOR REVIEW PRIOR TO INSTALLATION. A LINER MANUFACTURER REPRESENTATIVE IS TO BE PRESENT TO CERTIFY INSTALLATION OF THE LINER AND THE SEALING OF THE SEAMS. INSTALL TURF REINFORCEMENT MAT AS SHOWN ON THE PLANS. CONSTRUCT AND STABILIZE STORM SEWER SYSTEM B6A AND B6. INSTALL RIPRAP AT THE END OF THE HEADWALL B6. CONSTRUCT AND STABILIZE SWALE S4 S5 AND PVC LINER. SHOP DRAWINGS FOR THE PVC LINER AND GEOSYNTHETIC FABRIC ARE TO BE SUBMITTED TO THE TOWNSHIP FOR REVIEW PRIOR TO
- 5. INSTALLATION. A LINER MANUFACTURER REPRESENTATIVE IS TO BE PRESENT TO CERTIFY INSTALLATION OF THE LINER AND THE SEALING OF THE SEAMS. STABILIZE DISTURBED AREA IMMEDIATELY WITH PROPER SEEDING AND MULCH. SEE SEEDING AND MULCHING NOTES.

CONSTRUCT AND STABILIZE PARKING LOT INCLUDING CURBING, CURB RAMP, SIDEWALK, CURB CUT CC4, PAVEMENT, DRIVEWAY, LIGHTING AND LANDSCAPING. INSTALL RIPRAP APRON AT THE END OF CURB CUT CC4. STABILIZE DISTURBED AREA IMMEDIATELY WITH PROPER SEEDING AND MULCHING. SEE SEEDING AND MULCHING NOTES AND LANDSCAPING NOTES AND PLANS.

UPON OBTAINING 70% UNIFORM STABILIZATION WITHIN THE DRAINAGE AREA OF SEDIMENT TRAP II, CONVERT SEDIMENT TRAP II TO PERMANENT STORMWATER MANAGEMENT BASIN. TEMPORARY PUMPING MUST BE PROVIDED FOR THE RUNOFF AFTER STORM EVENT. DISCHARGE INTO A SEDIMENT FILTER BAG. INSTALL SEDIMENT FOREBAY BERM, PERMEABLE BLOCK PAVERS, PVC LINER, AND BASIN PLANTINGS. CONTRACTOR IS RESPONSIBLE TO DETERMINE THE TYPE OF EXISTING PERMANENT LINING UNDER THE EXISTING BASIN. ALTERNATIVE LINING FOR PROPOSED BASIN MUST BE SUBMITTED TO UPPER MERION TOWNSHIP FOR APPROVAL. SHOP DRAWINGS FOR THE PVC LINER AND GEOSYNTHETIC FABRIC ARE TO BE SUBMITTED TO THE TOWNSHIP FOR REVIEW PRIOR TO INSTALLATION. A LINER MANUFACTURER REPRESENTATIVE IS TO BE PRESENT TO CERTIFY INSTALLATION OF THE LINER AND THE SEALING OF THE SEAMS. STABILIZE DISTURBED AREA IMMEDIATELY WITH PROPER SEEDING AND MULCHING. SEE SEEDING AND MULCHING NOTES AND LANDSCAPING NOTES AND PLANS.

REMOVE ALL TEMPORARY EROSION AND SEDIMENT CONTROL DEVICES UPON ESTABLISHMENT OF PERMANENT VEGETATION AND SITE STABILIZATION. AREAS DISTURBED DURING THE REMOVAL OF DEVICES MUST BE STABILIZED IMMEDIATELY. SEE SEEDING AND MULCHING NOTES.



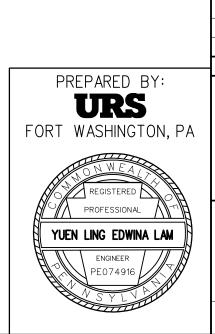

REVISIONS

EROSION & SEDIMENT POLLUTION
CONTROL CONSTRUCTION SEQUENCE
LIBERTY PROPERTY TRUST

180 SOUTH WARNER ROAD
UPPER MERION TOWNSHIP, MONTGOMERY COUNTY, PENNSYLVANIA

URS CORPORATION

Consulting Engineers

335 Commerce Drive • Suite 300 • Fort Washington • PA • 19034-2623

 (215) 367-2500 · Fax (215) 367-1000
 21386989


 SCALE
 DATE
 DRAWN BY
 CHECKED BY
 SHEET NO.


 AS NOTED
 SML
 7 OF 38


21386989

FIELD BOOK

21386989\CADD\Civil\also\e\_s\ConSeq. 30/2008 6:22:38 AM steve

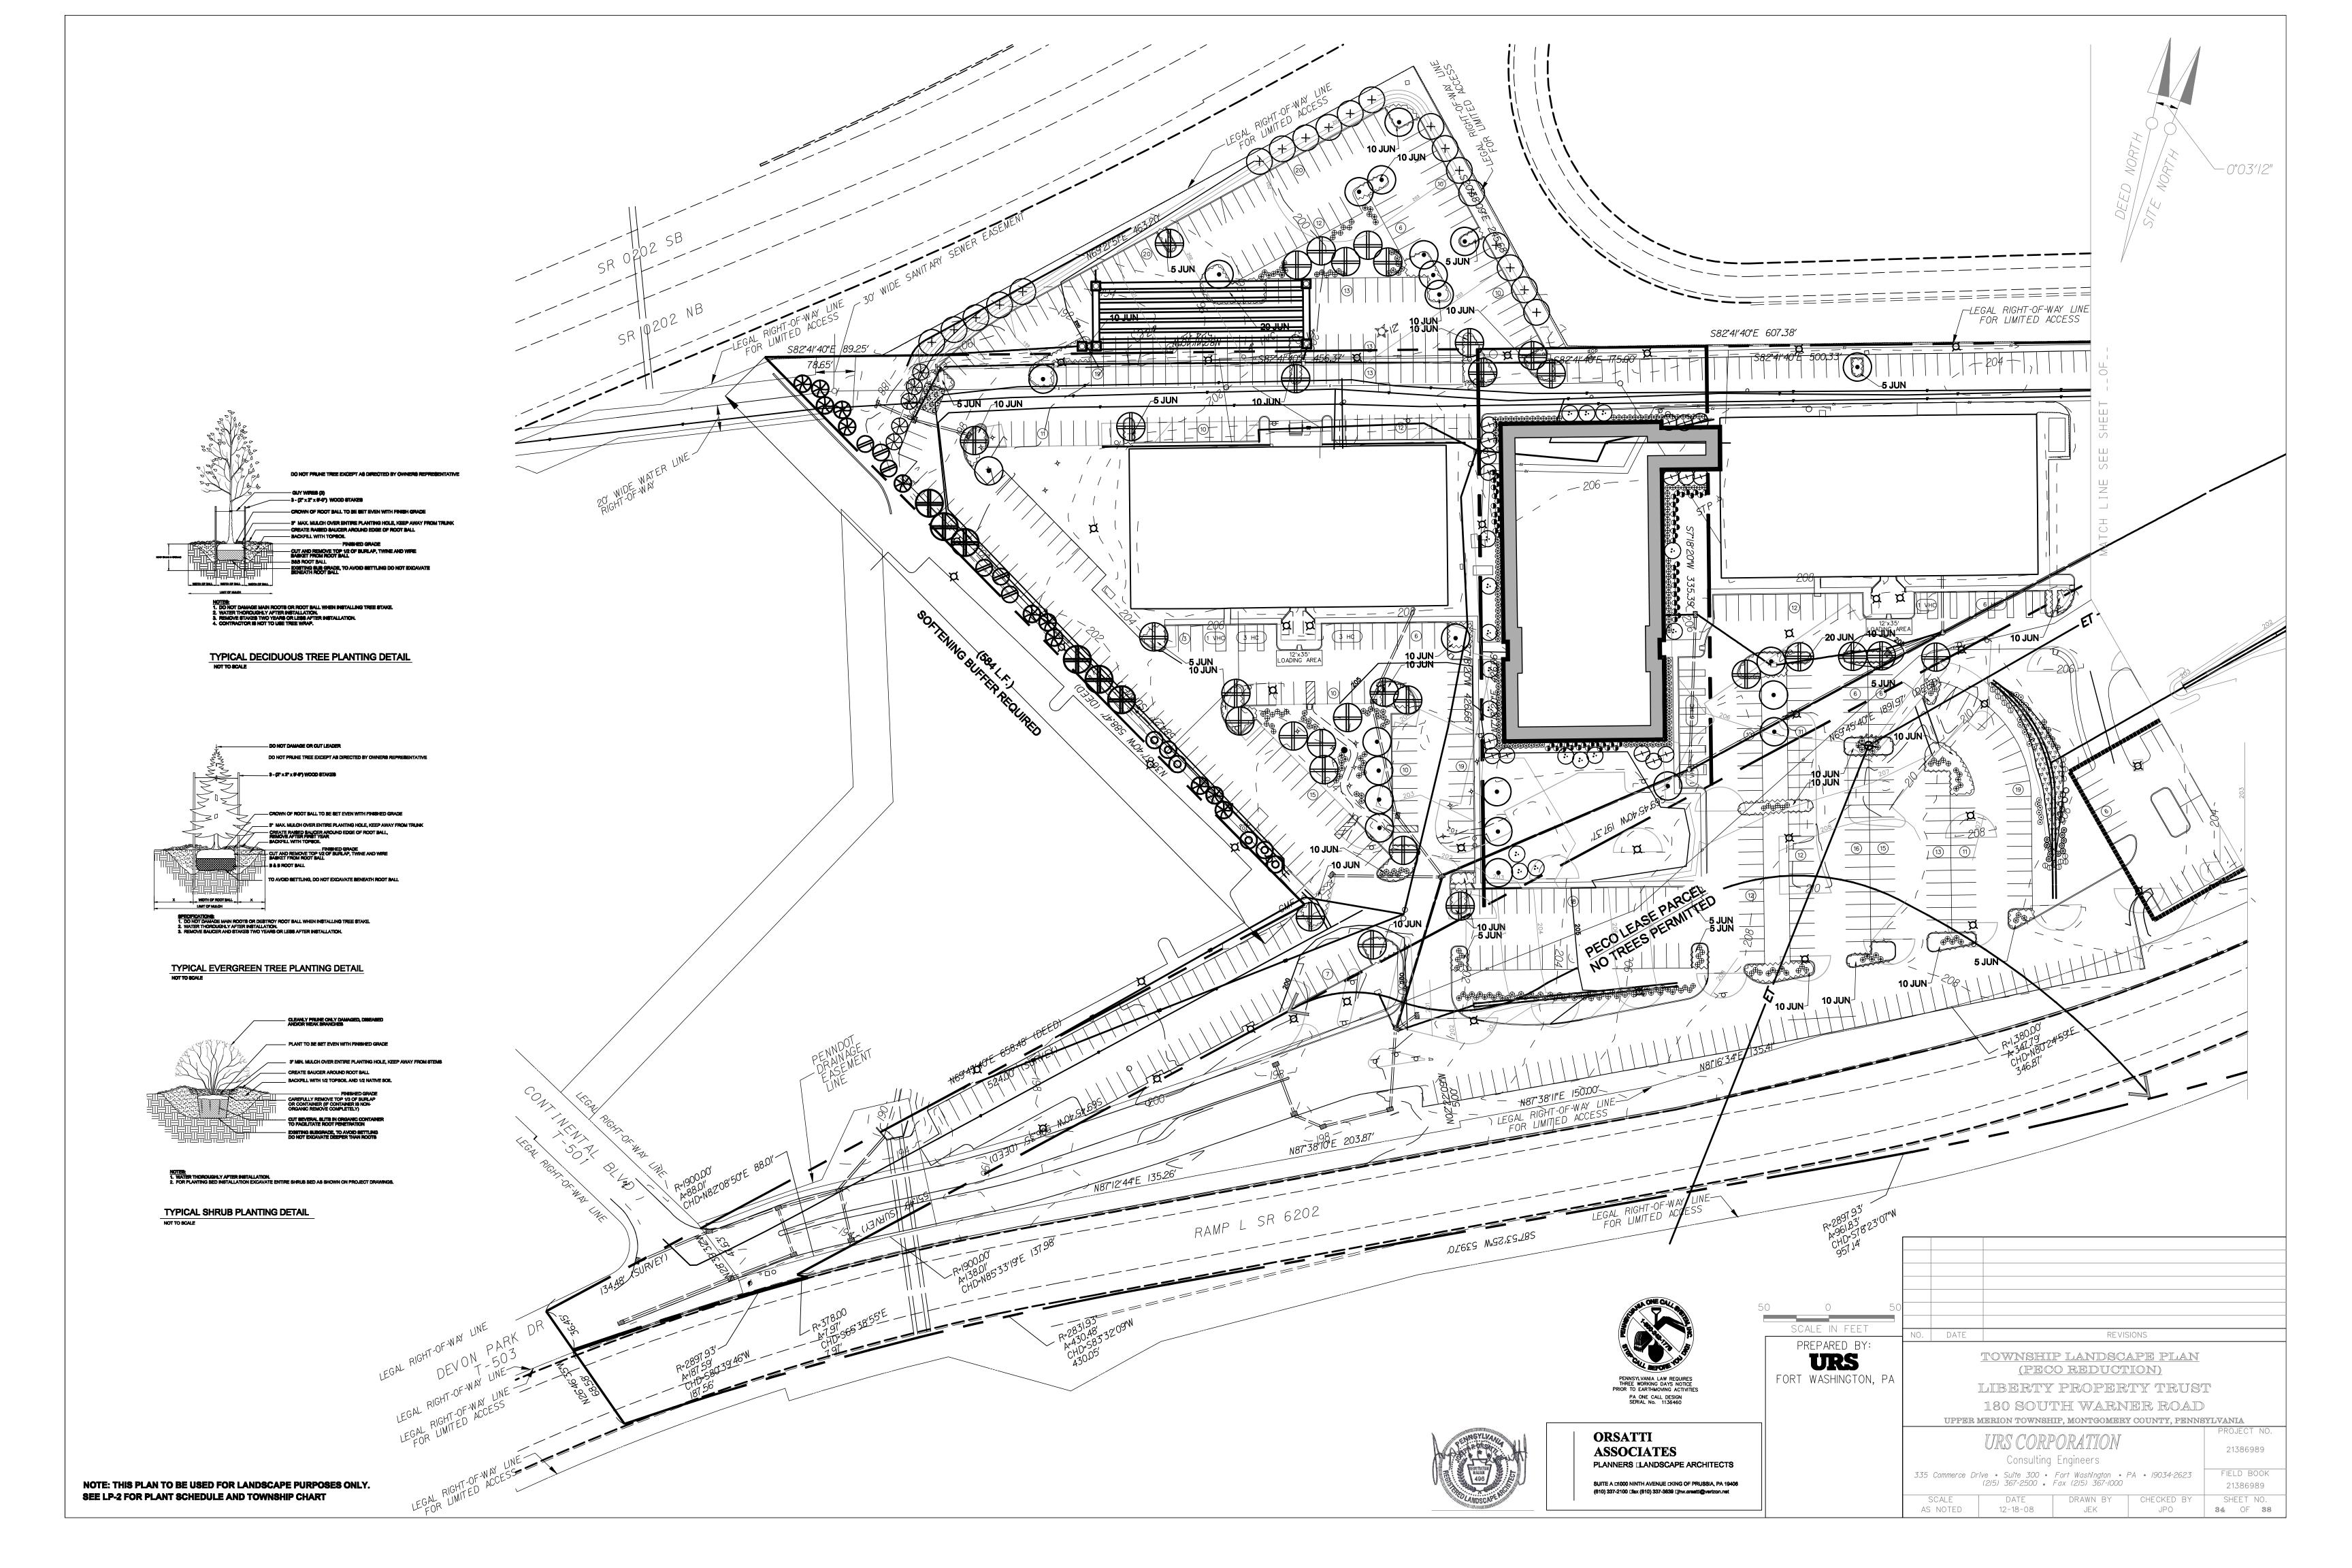

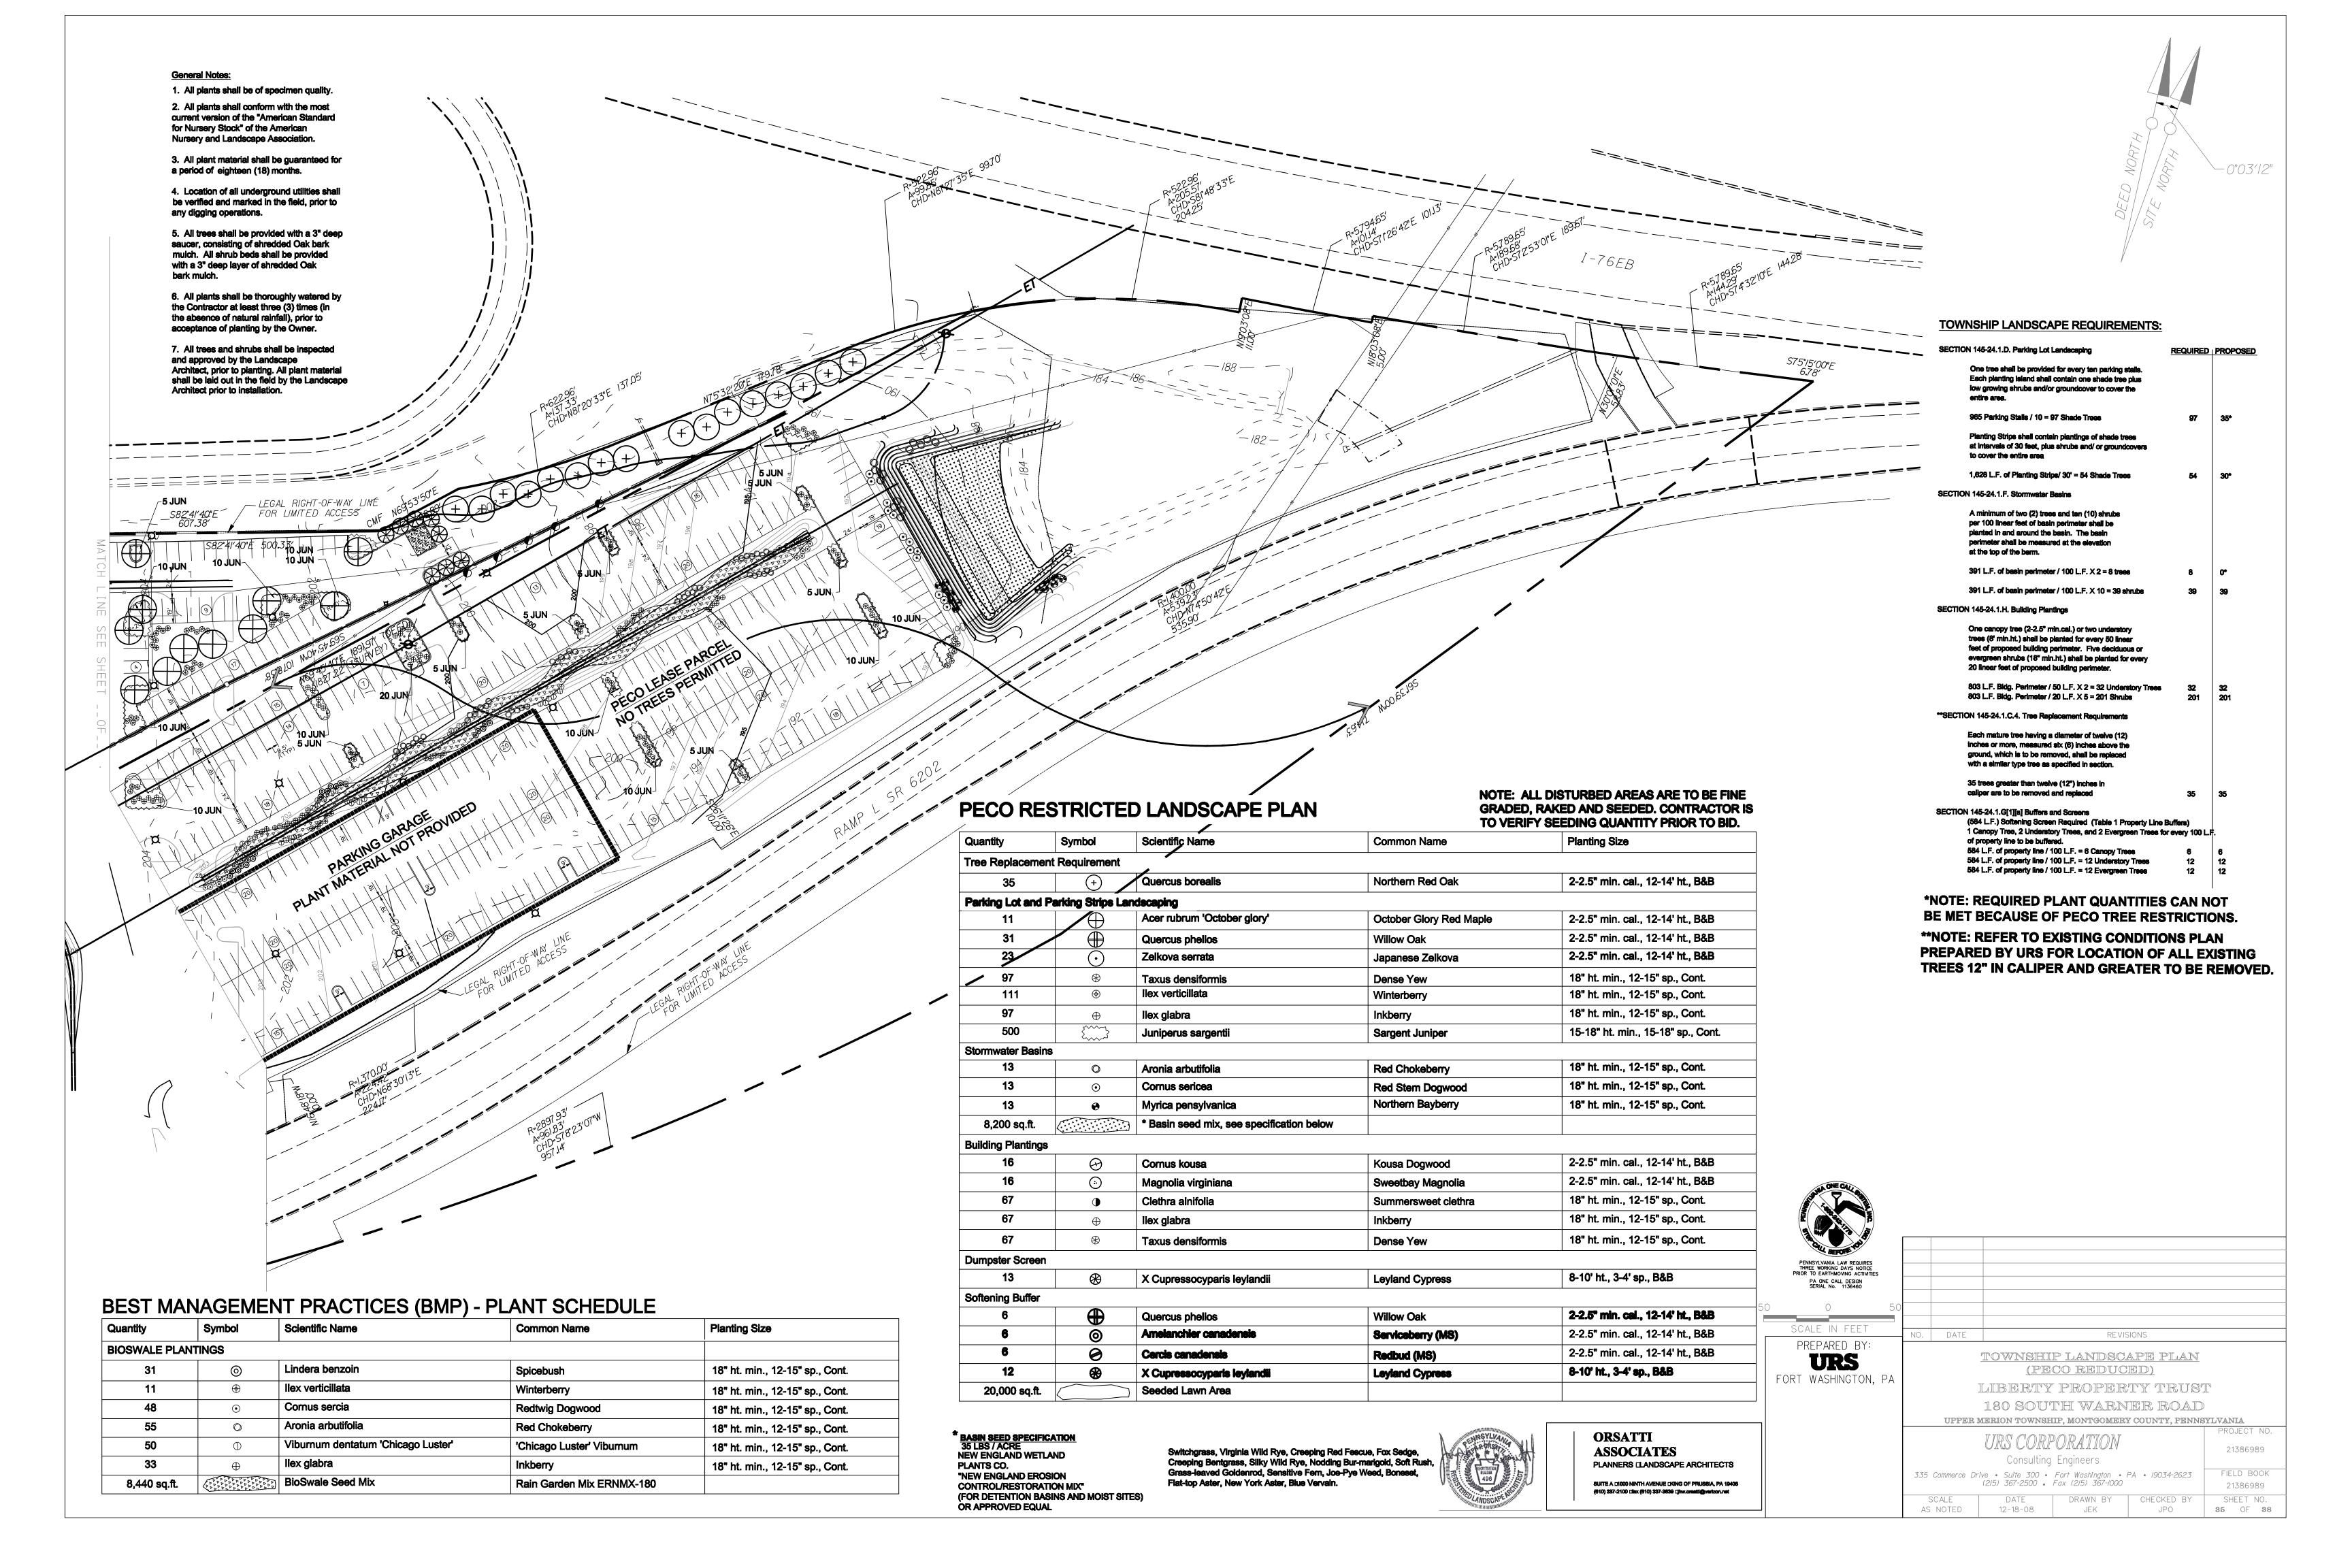

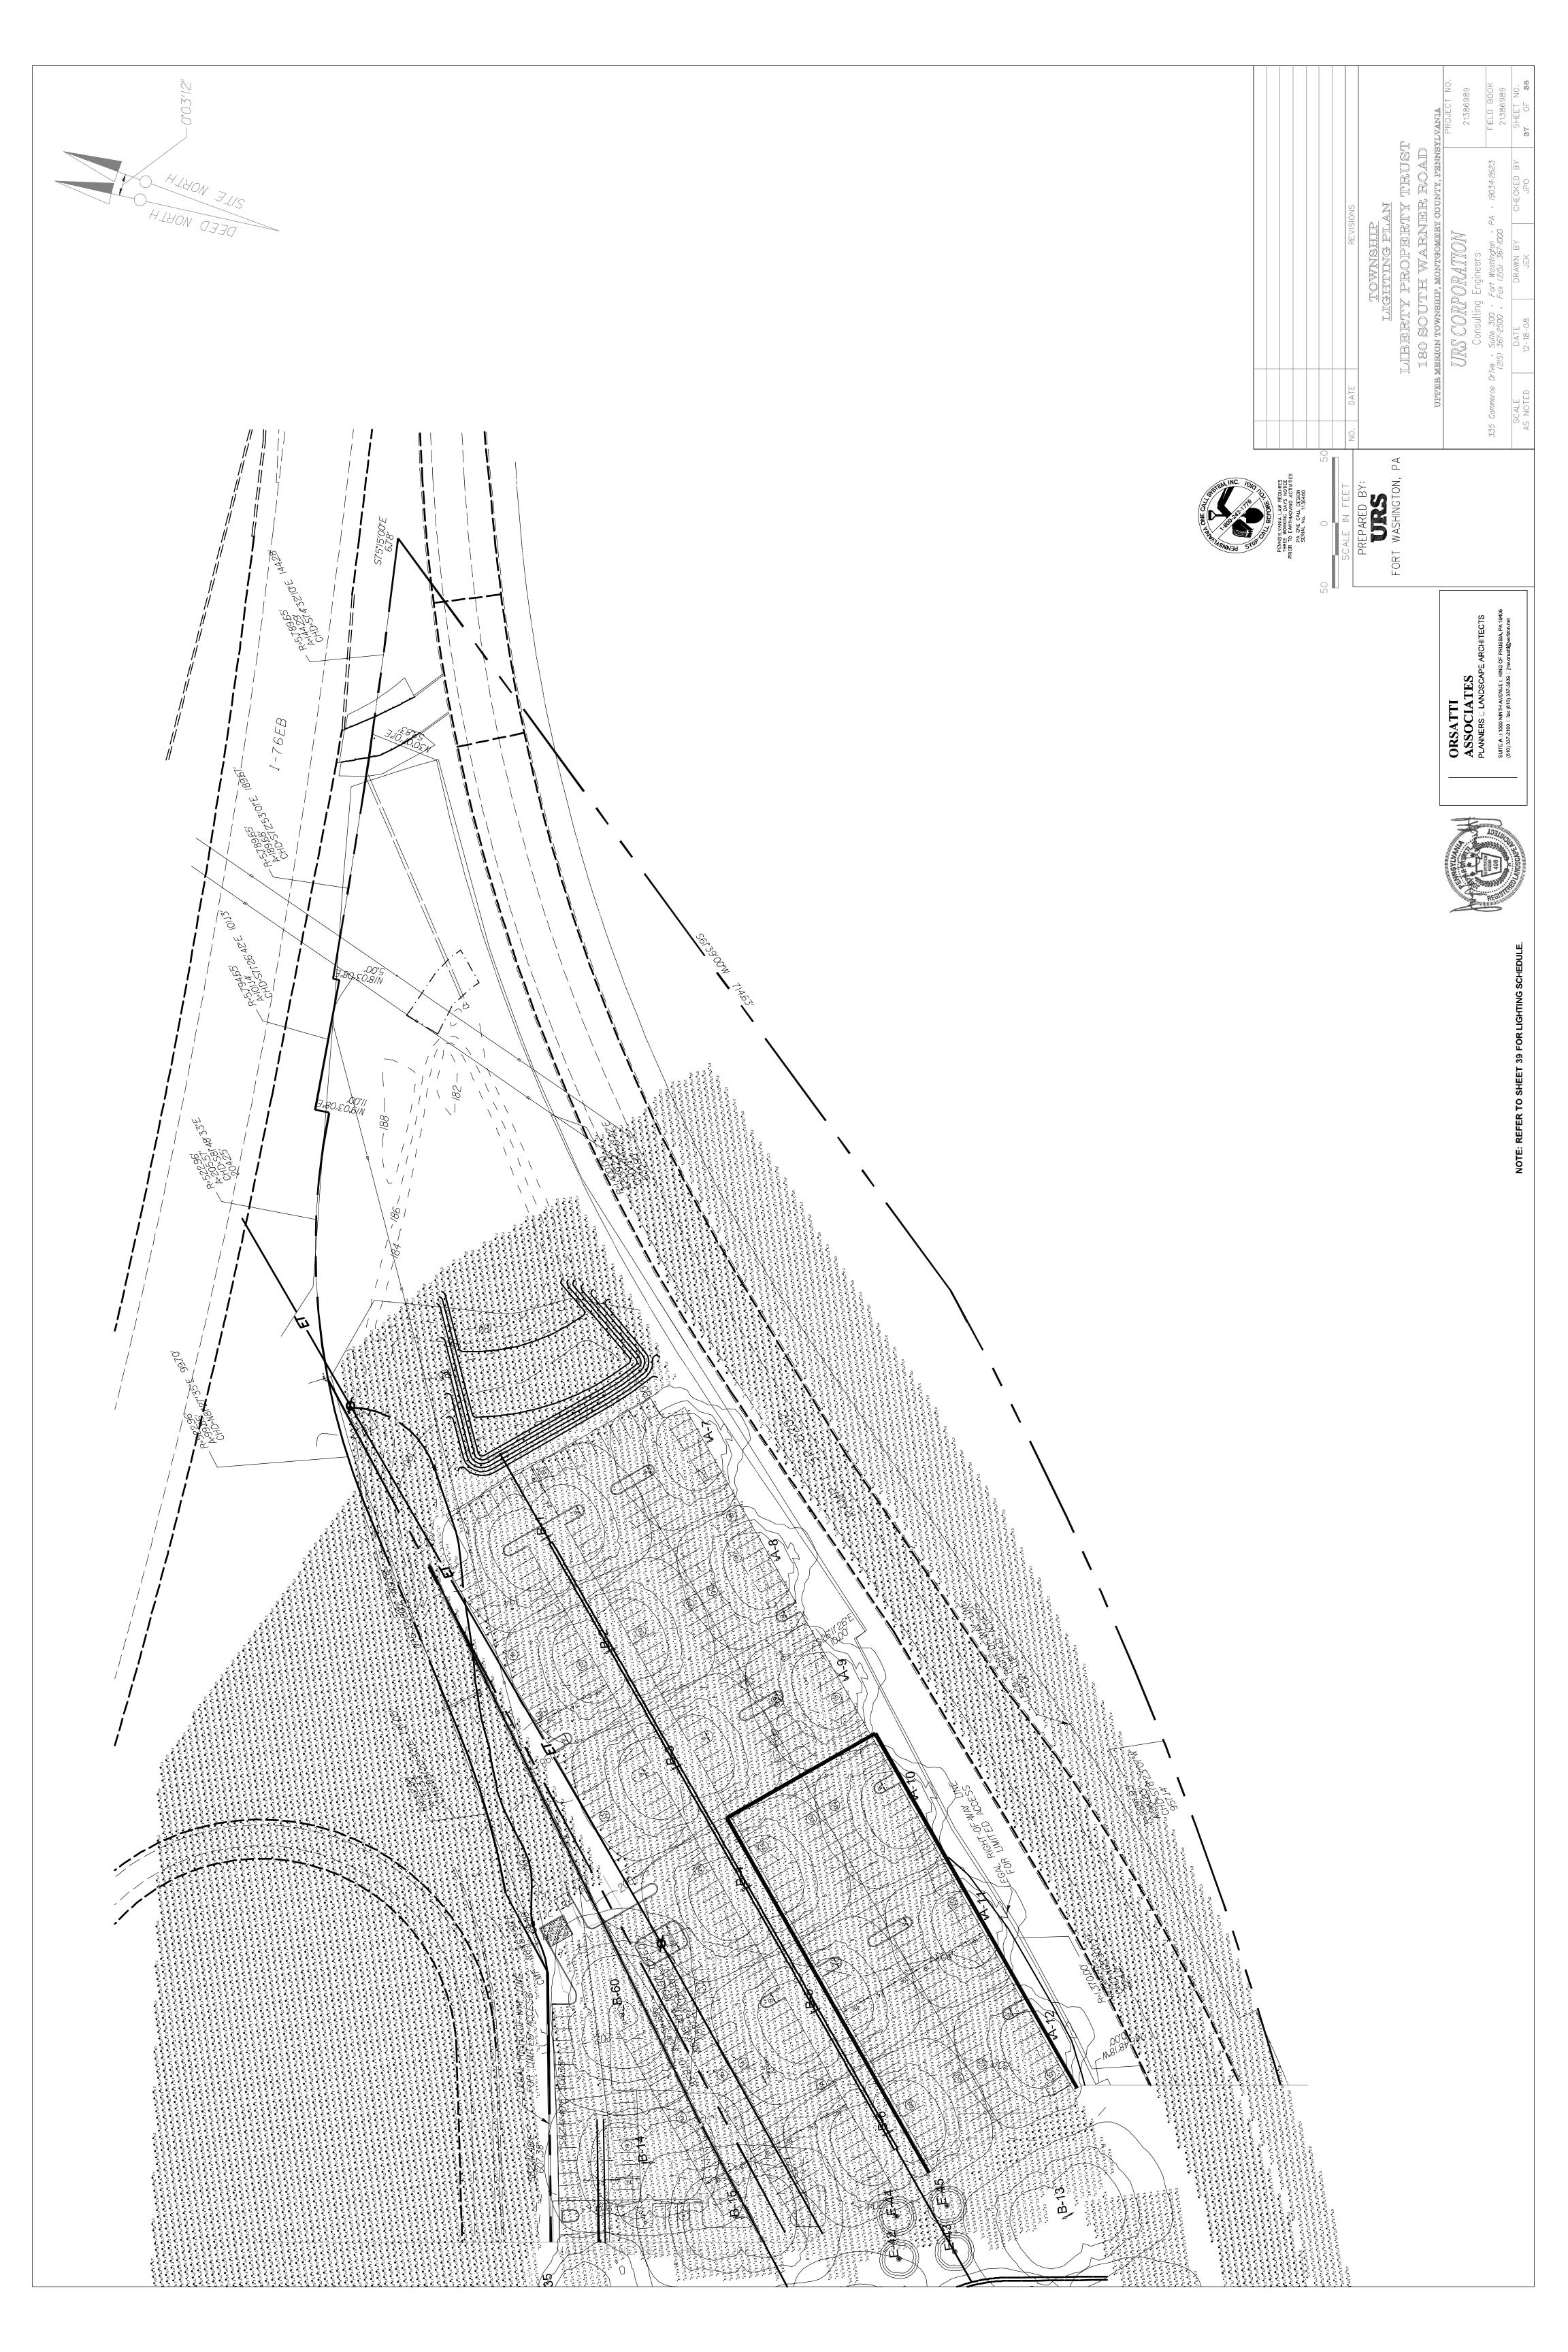


LOMIN	LUMINAIRE SCHEDULE	SCHEL	JULE							
Symbol	Label	Qty	Catalog Number	Description	Lamp	File	Lumens	LLF	Watts	
٠٥٠	∢		G250MH00LFFXXX SINGLE	MONGOOSE 25 FT POLE HEIGHT	250W CLEAR MH	51452.IES	21000	0.72	250	
<b>∙</b> ≎•≎•	В	28	G250MH00LFFXXX TWIN HEAD@180 DEGREES	MONGOOSE 25 FT POLE HEIGHT	250W CLEAR MH	51452.IES	21000	0.72	200	
*O•O*	O	5	G250MH00LSFXXX TWIN HEAD@180 DEGREES	MONGOOSE 25 FT POLE	250W CLEAR MH	51046.IES	21000	0.72	500	
Ó.	Q	13	G175MH00LFF SD- 321 SINGLE REAR HOUSE SODE SHIELD	MONGOOSE 25 FT POLE	250 CLEAR MH PRORATED FROM 175W CLEAR MH	102224.IES	21000	0.72	250	
<b>⟨</b> □	ш	<u></u>	H101/H102-100M- SYM LIGHTED BOLLARD 4 FT HIGH	H101 LOUVER BOLLARD, SYMMETRIC DISTRIBUTION WITH COATED 100W MH ED-17	100 W CLEAR MH	H101&H102- 100MSYM.IES	7900	0.72	133.4	

MH Orienta 25.0 -22.2 25.0 -22.2 25.0 -20.2 25.0 -20.2 25.0 -20.2 25.0 -20.2 25.0 -21.2 25.0 -21.2 25.0 -21.2 25.0 -21.2 25.0 -21.2 25.0 -21.2 25.0 -21.2 25.0 -24.2 25.0 -24.2 25.0 -24.2 25.0 -24.2 25.0 -25.0 -24.2 25.0 -25.0 -24.2 25.0 -25.0 -24.2 25.0 -25.0 -22.2 25.0 -25.0 -22.2 25.	MH         Orientation         Tilt           25.0         -22.3         0.0           25.0         -22.3         0.0           25.0         -19.7         0.0           25.0         -19.7         0.0           25.0         -20.1         0.0           25.0         -20.1         0.0           25.0         -20.3         0.0           25.0         -20.3         0.0           25.0         -20.3         0.0           25.0         -20.3         0.0           25.0         -20.3         0.0           25.0         -20.3         0.0           25.0         -20.3         0.0           25.0         -20.3         0.0           25.0         -18.7         0.0           25.0         -18.7         0.0           25.0         -18.7         0.0           25.0         -18.7         0.0           25.0         -18.7         0.0           25.0         -18.9         0.0           25.0         -18.2         0.0           25.0         -18.2         0.0           25.0         -18.2         0.0	Orientation  -22.3  -19.7  -19.7  -20.1  -20.1  -20.3  -20.3  -20.3  -21.1  -20.3  -21.1  -21.2  -18.7  -18.7  -18.7  -18.7  -18.7  -18.8  -84.9  -84


A Holophane "Mongoose" 250 W MH Forward Thro Full Cut-Off Single Head 25 ft pole

Description         Symbol         Avg         M           Adjacent Property@5 ft above grade         +         0.0 fc         0.3           Adjacent Road@5 ft above         +         0.0 fc         0.3           Britance         +         0.9 fc         2.4           Main Access Road & +         1.0 fc         4.6           Parking         Opposite Right of Way@5 ft         +         1.0 fc         0.0           Parking Center Lot New         +         1.3 fc         5.6           Parking Main Front Access         +         1.4 fc         5.5           Parking Main Front Access         +         1.4 fc         5.5				
Property@5 ft	vg Max	Min	Max/Min Av	Avg/Min
Road@5 ft above	) fc 0.3 fc	0.0 fc	N/ A	A / Z
bess Road & + 0.9 fc  bess Road & + 1.0 fc  ade  Center Lot New + 1.3 fc  East Lot + 1.2 fc  Main Front Access + 1.4 fc	) fc 0.3 fc	0.0 fc	N/A	A / N
bess Road & + 1.0 fc  ### Hight of Way@5 ft	9 fc 2.4 fc	0.3 fc	8.0:1	3.0:1
+ 0.0 fc + 1.3 fc + 1.2 fc + 1.4 fc	) fc 4.6 fc	0.1 fc	146.0:1	10.0:1
+ 1.3 fc + 1.2 fc + 1.4 fc	) fc 0.0 fc	0.0 fc	N/A	N/A
+ 1.2 fc + 1.4 fc	3 fc 5.0 fc	0.3 fc	16.7:1	4.3.1
+ 1.4 fc	2 fc 5.3 fc	0.3 fc	17.7.1	4.0:1
	4 fc 5.1 fc	0.3 fc	17.0:1	4.7:1
Parking Rear Loading & + 1.4 fc 5.0 Access Road	4 fc 5.0 fc	0.3 fc	16.7:1	471
Parking Rear New Lot $+$ 1.5 fc 5.2	5 fc 5.2 fc	0.3 fc	17.3.1	5.0:1
Parking West Lot	5 fc 4.8 fc	0.3 fc	16.0:1	5.0:1

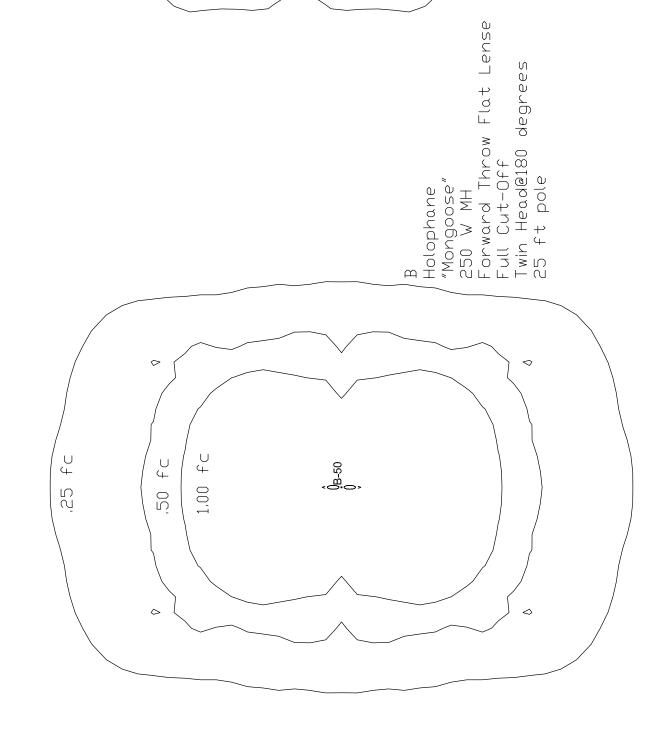

.50 fc

1,00

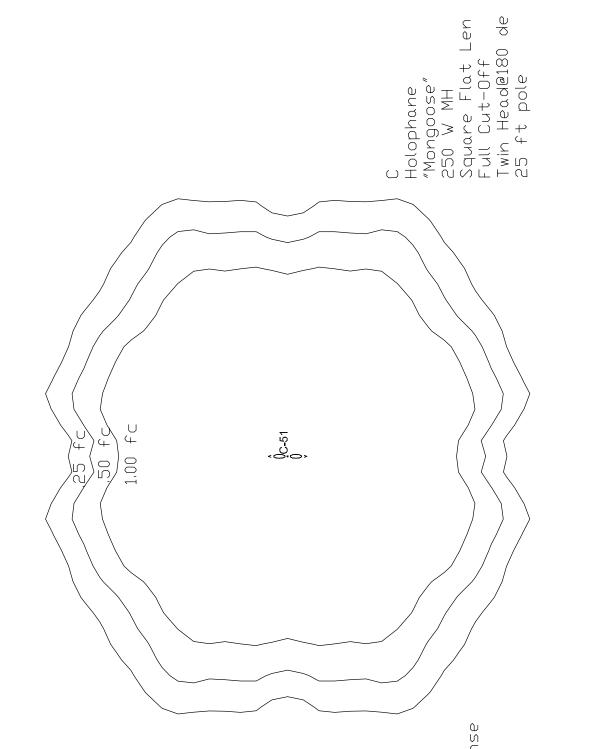

# NOTES

1. All Luminaires are UL Listed & CSA certified

2. Suitable for Wet Location Use 3. 80 mph pole wind loading

4. IESNA Classification "Full-Cut-Off"



E Holophane H-Scapes Lighted Bollard 100 W MH Type V Optic Internal Louvers 42 inch high

Side Shield

D Holophane "Mongoose" 250 W MH Forward Throw Flat Lense Full Cut-Off Single Head Single Head SD-321 Rear House Side Shie 25 ft pole

1,00 fc

.50 fc

 $\bigcirc$ 

,25 fc



PREPARED BY:

URS

FORT WASHINGTON, PA

SUITE A E 1000 NINTH AVENUE | KING OF PRUSSIA, PA 19406 (610) 337-2100 | fax (610) 337-3639 | jnw.orsati@vertzon.net

ORSATTI
ASSOCIATES
PLANNERS - LANDSCAPE ARCHITECTS

335 Com

SYLVANIA PROJECT