

RECORDING ACKNOWLEDGEMENTS

CORPORATE CERTIFICATION OF INTENT

KNOW TO ALL TO WHOM THESE PRESENTS MAY COME, THAT I, _____, BEING AN OFFICER FOR SMITHKLINE BEECHAM PHARMACEUTICALS, A PENNSYLVANIA CORPORATION, FOR ITSELF, ITS SUCCESSORS AND ASSIGNS, DO HEREBY ADOPT THIS AS OUR PLAN OF LOTS AND STREETS AND/OR LAND DEVELOPMENT PLAN OF OUR PROPERTY, SITUATE IN THE TOWNSHIP OF UPPER MERION, COUNTY OF MONTGOMERY, COMMONWEALTH OF PENNSYLVANIA, AND IT IS OUR DESIRE THAT THIS PLAN BE RECORDED ACCORDING TO LAW.

COMMONWEALTH OF PENNSYLVANIA: COUNTY OF MONTGOMERY: ON THE _____ DAY OF _____, 20____, BEFORE ME, THE UNDERSIGNED OFFICER, PERSONALLY APPEARED _____ WHOSE NAME IS SUBSCRIBED TO THE WITHIN INSTRUMENT AND ACKNOWLEDGE THAT HE EXECUTED THE SAME FOR THE PURPOSES THEREIN CONTAINED.

MCPC CERTIFICATION

MCPC No. _____ PROCESSED AND REVIEWED. A report has been prepared by the Montgomery County Planning Commission in accordance with the Municipalities Planning Code. Certified this date _____ For the Director Montgomery County Planning Commission

TOWNSHIP ENGINEER'S REVIEW

THIS SUBDIVISION AND/OR LAND DEVELOPMENT PLAN WAS REVIEWED BY THE TOWNSHIP ENGINEER FOR THE TOWNSHIP OF UPPER MERION ON THIS _____ DAY OF _____, 20____.

BOARD OF SUPERVISORS' APPROVAL

THIS SUBDIVISION AND/OR LAND DEVELOPMENT PLAN WAS APPROVED BY RESOLUTION OF THE BOARD OF SUPERVISORS OF THE TOWNSHIP OF UPPER MERION THIS _____ DAY OF _____, 20____.

DESIGN ENGINEER CERTIFICATION

TO THE BEST OF MY KNOWLEDGE, THE PLANS ARE IN CONFORMITY WITH ENGINEERING, ZONING, BUILDING, SANITATION AND OTHER APPLICABLE UPPER MERION TOWNSHIP ORDINANCES AND REGULATIONS.

SURVEYOR'S CERTIFICATION

I HEREBY CERTIFY THAT I, (NAME), AM A REGISTERED PROFESSIONAL AND SURVEYOR, LICENSED IN COMPLIANCE WITH THE LAWS OF THE COMMONWEALTH OF PENNSYLVANIA: THAT THIS IS A TRUE AND ACCURATE SURVEY MADE ON THE GROUND COMPLETED BY ME ON THE _____ DAY OF _____, 20____ THAT ALL THE MARKERS SHOWN THEREON ACTUALLY EXIST, THAT THEIR LOCATION, SIZE, TYPE AND MATERIAL ARE ACCURATELY SHOWN; AND THAT NO ENCROACHMENTS, RIGHT-OF-WAY, OR EASEMENTS EXIST, EXCEPT AS SHOWN HEREON.

RECORDING

RECORDED IN THE OFFICE OF THE RECORDER OF DEEDS FOR MONTGOMERY COUNTY IN NORRISTOWN, PA, THIS _____ DAY OF _____, 20____ IN PLAN BOOK _____ PAGE _____

ZONING INFORMATION

ENTIRE TRACT IS IN THREE ZONING DISTRICTS: LI (LIMITED INDUSTRIAL), R-1 (RESIDENTIAL), AND HI (HEAVY INDUSTRIAL). PROPOSED IMPROVEMENTS LIE SOLELY WITHIN THE HI ZONING DISTRICT.

DATA OBTAINED FROM "UPPER MERION TOWNSHIP CODE, CHAPTER 165, ZONING & GENERAL REFERENCES" DATED 2004.

LIMITED INDUSTRIAL DISTRICT (LI)

Table with columns: ZONING REQUIREMENTS, EXISTING, PROPOSED. Rows include TRACT SIZE, MAXIMUM BUILDING COVERAGE, BUILDING HEIGHT LIMITS, YARD REQUIREMENTS, MINIMUM FRONT YARD, MINIMUM REAR YARD, MINIMUM SIDE YARD.

GREEN SPACE CALCULATIONS

(PER ARTICLE XXIX, SECTION 165-198) REQUIRED MINIMUM GREEN AREA = NET AREA OF TRACT X 15% = 252.92 ACRES X 15% = 38.73 ACRES. EXISTING GREEN SPACE AREA = 187.08 ACRES (74.0%). PROPOSED GREEN SPACE AREA = 186.57 ACRES (73.8%).

PARKING INFORMATION

EXISTING (TOTAL) PARKING SPACE STUDY COMPLETED FEBRUARY 2008 (EAST/WEST CAMPUS) 2,309

UNDERGROUND FACILITY OWNER LIST

Table with columns: OWNER NAME, PHONE NUMBER, OWNER NAME, PHONE NUMBER. Lists various utility providers like Verizon, Comcast, and PECO Energy.

ADJACENT OWNER INFORMATION

Table with columns: PROP. No., PARCEL, NAME/ADDRESS. Lists adjacent property owners and their details.

PLAN SHEET INDEX



Table with columns: SHEET NO., DRAWING NO., DESCRIPTION. Lists drawing sheets and their descriptions.

GENERAL NOTES

- 1. THE PURPOSE OF THIS PLAN IS TO DEPICT A PROPOSED CENTRAL UTILITY PLANT AND OTHER ASSOCIATED IMPROVEMENTS FOR GLAXOSMITHKLINE. THE ULTIMATE FOOTPRINT OF THE BUILDING WILL BE 35,660 SQUARE FEET. 2. BOUNDARY INFORMATION FROM BOUNDARY SURVEY BY ANDERSEN ENGINEERING ASSOCIATES, INC. 2007. DATUM BASED UPON USGS (NAD88). 3. THE PROPERTY OWNER SHALL HAVE THE RESPONSIBILITY FOR THE PERPETUAL MAINTENANCE OF THE PERMANENT STORMWATER MANAGEMENT FACILITIES. NO CHANGES SHALL BE MADE TO THE STORMWATER MANAGEMENT FACILITIES OR FINISH GRADING WITHOUT PRIOR WRITTEN APPROVAL FROM THE TOWNSHIP. THE TOWNSHIP HAS THE RIGHT, BUT NOT THE OBLIGATION, TO ENTER THE PROPERTY TO PERFORM ANY REQUIRED MAINTENANCE WHICH HAS NOT BEEN PROPERLY PERFORMED IN A TIMELY MANNER. THE PROPERTY OWNER SHALL BE RESPONSIBLE FOR THE COST OF ANY MAINTENANCE WHICH IS PERFORMED BY THE TOWNSHIP. THE TOWNSHIP SHALL LIEN THE PROPERTY FOR SAID COSTS UNTIL THE TOWNSHIP HAS BEEN REIMBURSED IN FULL. 4. PUBLIC WATER AND PUBLIC SEWER PROPOSED

SUBDIVISION AND LAND DEVELOPMENT WAIVERS*

FROM SECTION 145-24.1(A)(B): TO ALLOW ANDERSEN ENGINEERING ASSOCIATES TO PREPARE A LANDSCAPING PLAN INSTEAD OF A PROFESSIONAL LANDSCAPE ARCHITECT OR LANDSCAPE DESIGNER. (WAIVER GRANTED ON APRIL 16, 2009.)

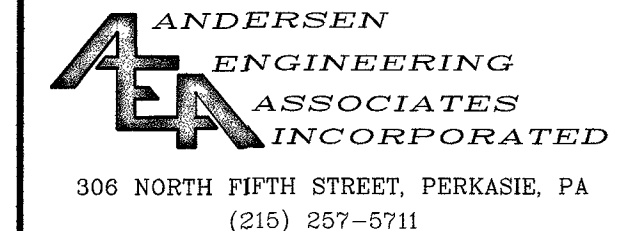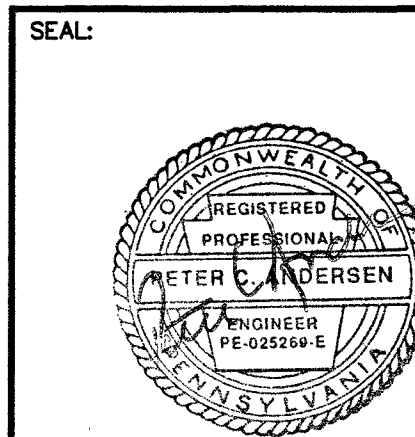

FIELD BK/PG: -/- AEA JOB NO.: 5365 AEA FILE NO.: 5365SITE

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Table with columns: NOTES, REFERENCE DRAWINGS, LEGEND. Includes drawing title and sheet information.

Table with columns: PAGE No., DRAWING No., TITLE. Includes drawing title and sheet information.

KEY PLAN

Table with columns: REVISION, DATE REVISED, CONTROL NUMBER. Includes revision history.

GENERAL NOTES

1. THE PURPOSE OF THIS PLAN IS TO DEPICT A PROPOSED CENTRAL UTILITY PLANT AND OTHER ASSOCIATED IMPROVEMENTS FOR GLAXOSMITHKLINE. THE ULTIMATE FOOTPRINT OF THE BUILDING WILL BE 35,660 SQUARE FEET. 2. BOUNDARY INFORMATION FROM BOUNDARY SURVEY BY ANDERSEN ENGINEERING ASSOCIATES, INC. 2007. DATUM BASED UPON USGS (NAD88). 3. THE PROPERTY OWNER SHALL HAVE THE RESPONSIBILITY FOR THE PERPETUAL MAINTENANCE OF THE PERMANENT STORMWATER MANAGEMENT FACILITIES. NO CHANGES SHALL BE MADE TO THE STORMWATER MANAGEMENT FACILITIES OR FINISH GRADING WITHOUT PRIOR WRITTEN APPROVAL FROM THE TOWNSHIP. THE TOWNSHIP HAS THE RIGHT, BUT NOT THE OBLIGATION, TO ENTER THE PROPERTY TO PERFORM ANY REQUIRED MAINTENANCE WHICH HAS NOT BEEN PROPERLY PERFORMED IN A TIMELY MANNER. THE PROPERTY OWNER SHALL BE RESPONSIBLE FOR THE COST OF ANY MAINTENANCE WHICH IS PERFORMED BY THE TOWNSHIP. THE TOWNSHIP SHALL LIEN THE PROPERTY FOR SAID COSTS UNTIL THE TOWNSHIP HAS BEEN REIMBURSED IN FULL. 4. PUBLIC WATER AND PUBLIC SEWER PROPOSED



UPPER MERION R&D FACILITIES CAPITAL PROJECTS, ENGINEERING AND DESIGN 709 SWEDELAND ROAD KING-OF-PRUSSIA, PA 19406 (610) 270-5881

PROJECT REF: UPPER MERION CENTRAL UTILITIES PLANT

TITLE: PROPOSED CENTRAL UTILITIES PLANT (CUP) BUILDING SHEET TITLE: LAND DEVELOPMENT PLAN

Table with columns: DRN BY, DRN BY DATE, FILE REFERENCE, CHD BY, CHD BY DATE, DRAWING STATUS. Includes project metadata.

LEGACY GSK DRAWING DWG NO. (SEE NOTE ABOVE) 1" = 400' 1 OF 21

DCS DRAWING NO.: 00-00-001



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Serial #

PENNSYLVANIA ACT 287 OF 1974 AS AMENDED BY ACT 121 OF 2008


REQUIRES NOTIFICATION OF EXCAVATORS, DESIGNERS, OR ANY PERSON PREPARING TO DISTURB THE EARTH'S SURFACE ANYWHERE IN THE COMMONWEALTH.

CAUTION

LOCATION, DEPTH AND ALIGNMENT OF EXISTING WATER, GAS MAINS, SEWER LINES, STORM DRAINS, TELEPHONE, ELECTRIC OR OTHER UNDERGROUND UTILITIES, FACILITIES OR APPURTENANCES ARE NOT PRECISELY KNOWN, BUT ARE SHOWN APPROXIMATELY BASED ON SUCH INFORMATION THAT IS AVAILABLE. THE CONTRACTOR IS TO VERIFY THIS INFORMATION IN THE FIELD PRIOR TO NEW CONSTRUCTION.


WRITTEN DIMENSIONS HAVE PRIORITY OVER SCALED DIMENSIONS. ALL DIMENSIONS, ELEVATIONS, LOCATIONS AND CONDITIONS, SHALL BE VERIFIED BY THE CONTRACTOR PRIOR TO CONSTRUCTION. THE OWNER AND ANDERSEN ENGINEERING ASSOCIATES, INC. SHALL BE NOTIFIED OF ANY VARIANCE FROM THE INFORMATION SHOWN ON THE DRAWINGS.

ALL IDEAS, DESIGNS, CONCEPTS AND ARRANGEMENTS PRESENTED HERE WERE DEVELOPED FOR USE AND IN CONNECTION WITH THIS SPECIFIC PROJECT, PREPARED FOR AND TO BE PAID FOR BY THE OWNER. THESE PLANS MAY NOT BE REPRODUCED OR ALTERED WITHOUT THE EXPRESSED WRITTEN PERMISSION OF ANDERSEN ENGINEERING ASSOCIATES, INC.

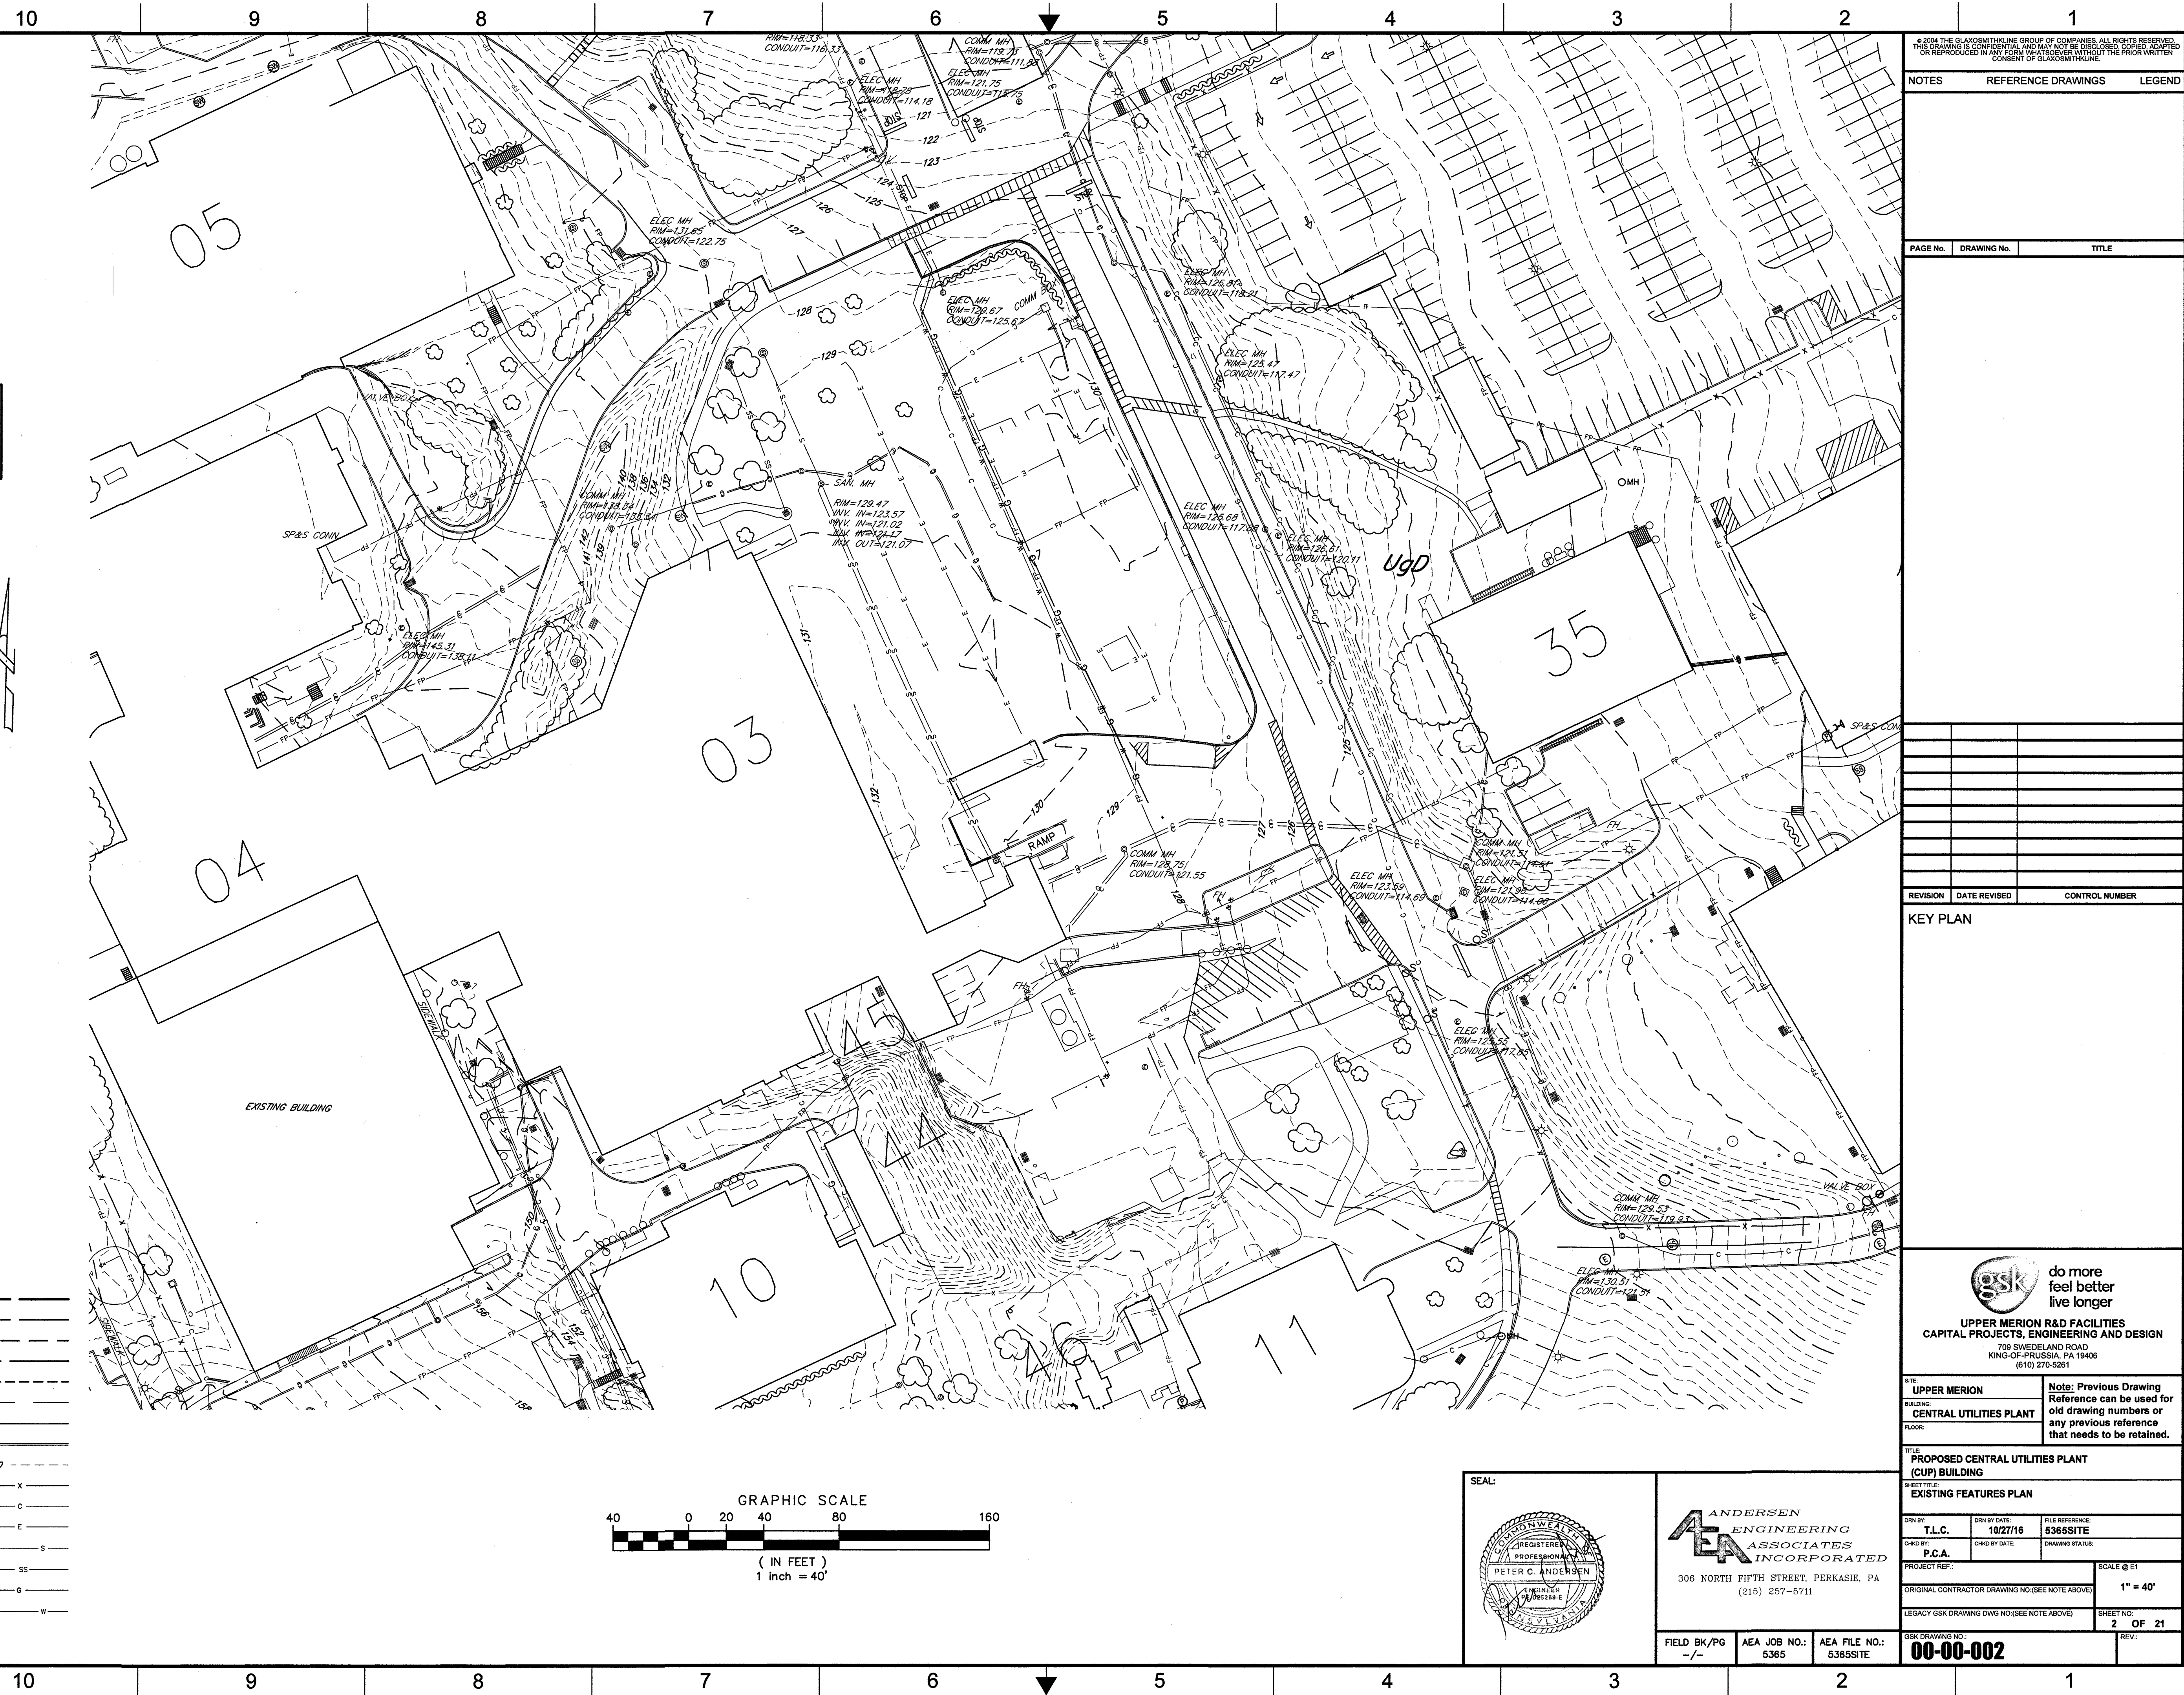

LINETYPE LEGEND

- EXISTING PROPERTY LINE
- ADJOINERS PROPERTY LINE
- ZONING BOUNDARY
- EXISTING RIGHT-OF-WAY LINE
- EXISTING EASEMENT LINE
- BUILDING SET BACK LINE
- EXISTING EDGE OF ROAD
- EXISTING CURB
- EXISTING CONTOUR LINE
- EXISTING FENCE
- EXISTING UNDERGROUND COMMUNICATIONS
- EXISTING UNDERGROUND ELECTRIC
- EXISTING SANITARY SEWER
- EXISTING STORM SEWER
- EXISTING UNDERGROUND GAS LINE
- EXISTING WATER LINE

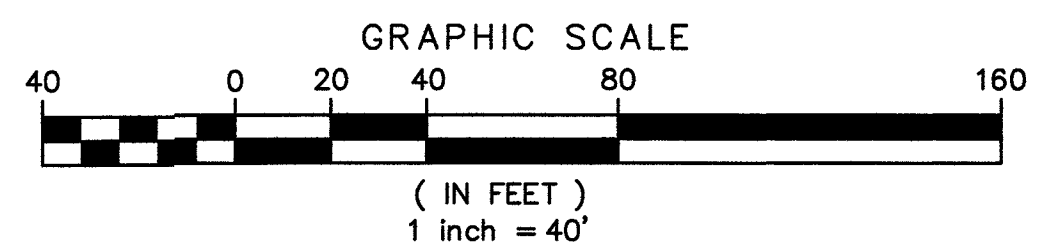

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NOTES	REFERENCE DRAWINGS	LEGEND

PAGE No.	DRAWING No.	TITLE

REVISION	DATE REVISED	CONTROL NUMBER

KEY PLAN

do more feel better live longer

UPPER MERION R&D FACILITIES CAPITAL PROJECTS, ENGINEERING AND DESIGN
709 SWEDLAND ROAD
KING-OF-PRUSSIA, PA 19406
(610) 270-5281


SITE: UPPER MERION
BUILDING: CENTRAL UTILITIES PLANT
FLOOR:

Note: Previous Drawing Reference can be used for old drawing numbers or any previous reference that needs to be retained.

TITLE: PROPOSED CENTRAL UTILITIES PLANT (CUP) BUILDING

SHEET TITLE: EXISTING FEATURES PLAN



DRN BY: T.L.C.	DRN BY DATE: 10/27/16	FILE REFERENCE: 5365SITE
DRN BY: P.C.A.	DRN BY DATE:	DRAWING STATUS:
PROJECT REF:	SCALE @ E1	1" = 40'
ORIGINAL CONTRACTOR DRAWING NO.(SEE NOTE ABOVE)	LEGACY GSK DRAWING DWG NO.(SEE NOTE ABOVE)	SHEET NO. 2 OF 21

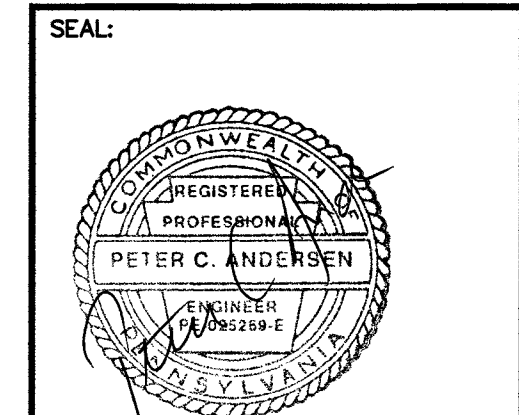

ANDERSEN ENGINEERING ASSOCIATES INCORPORATED
306 NORTH FIFTH STREET, PERKASIE, PA (215) 257-5711

FIELD BK/Pg: -/-
AEA JOB NO.: 5365
AEA FILE NO.: 5365SITE

GSK DRAWING NO.: **00-00-002**

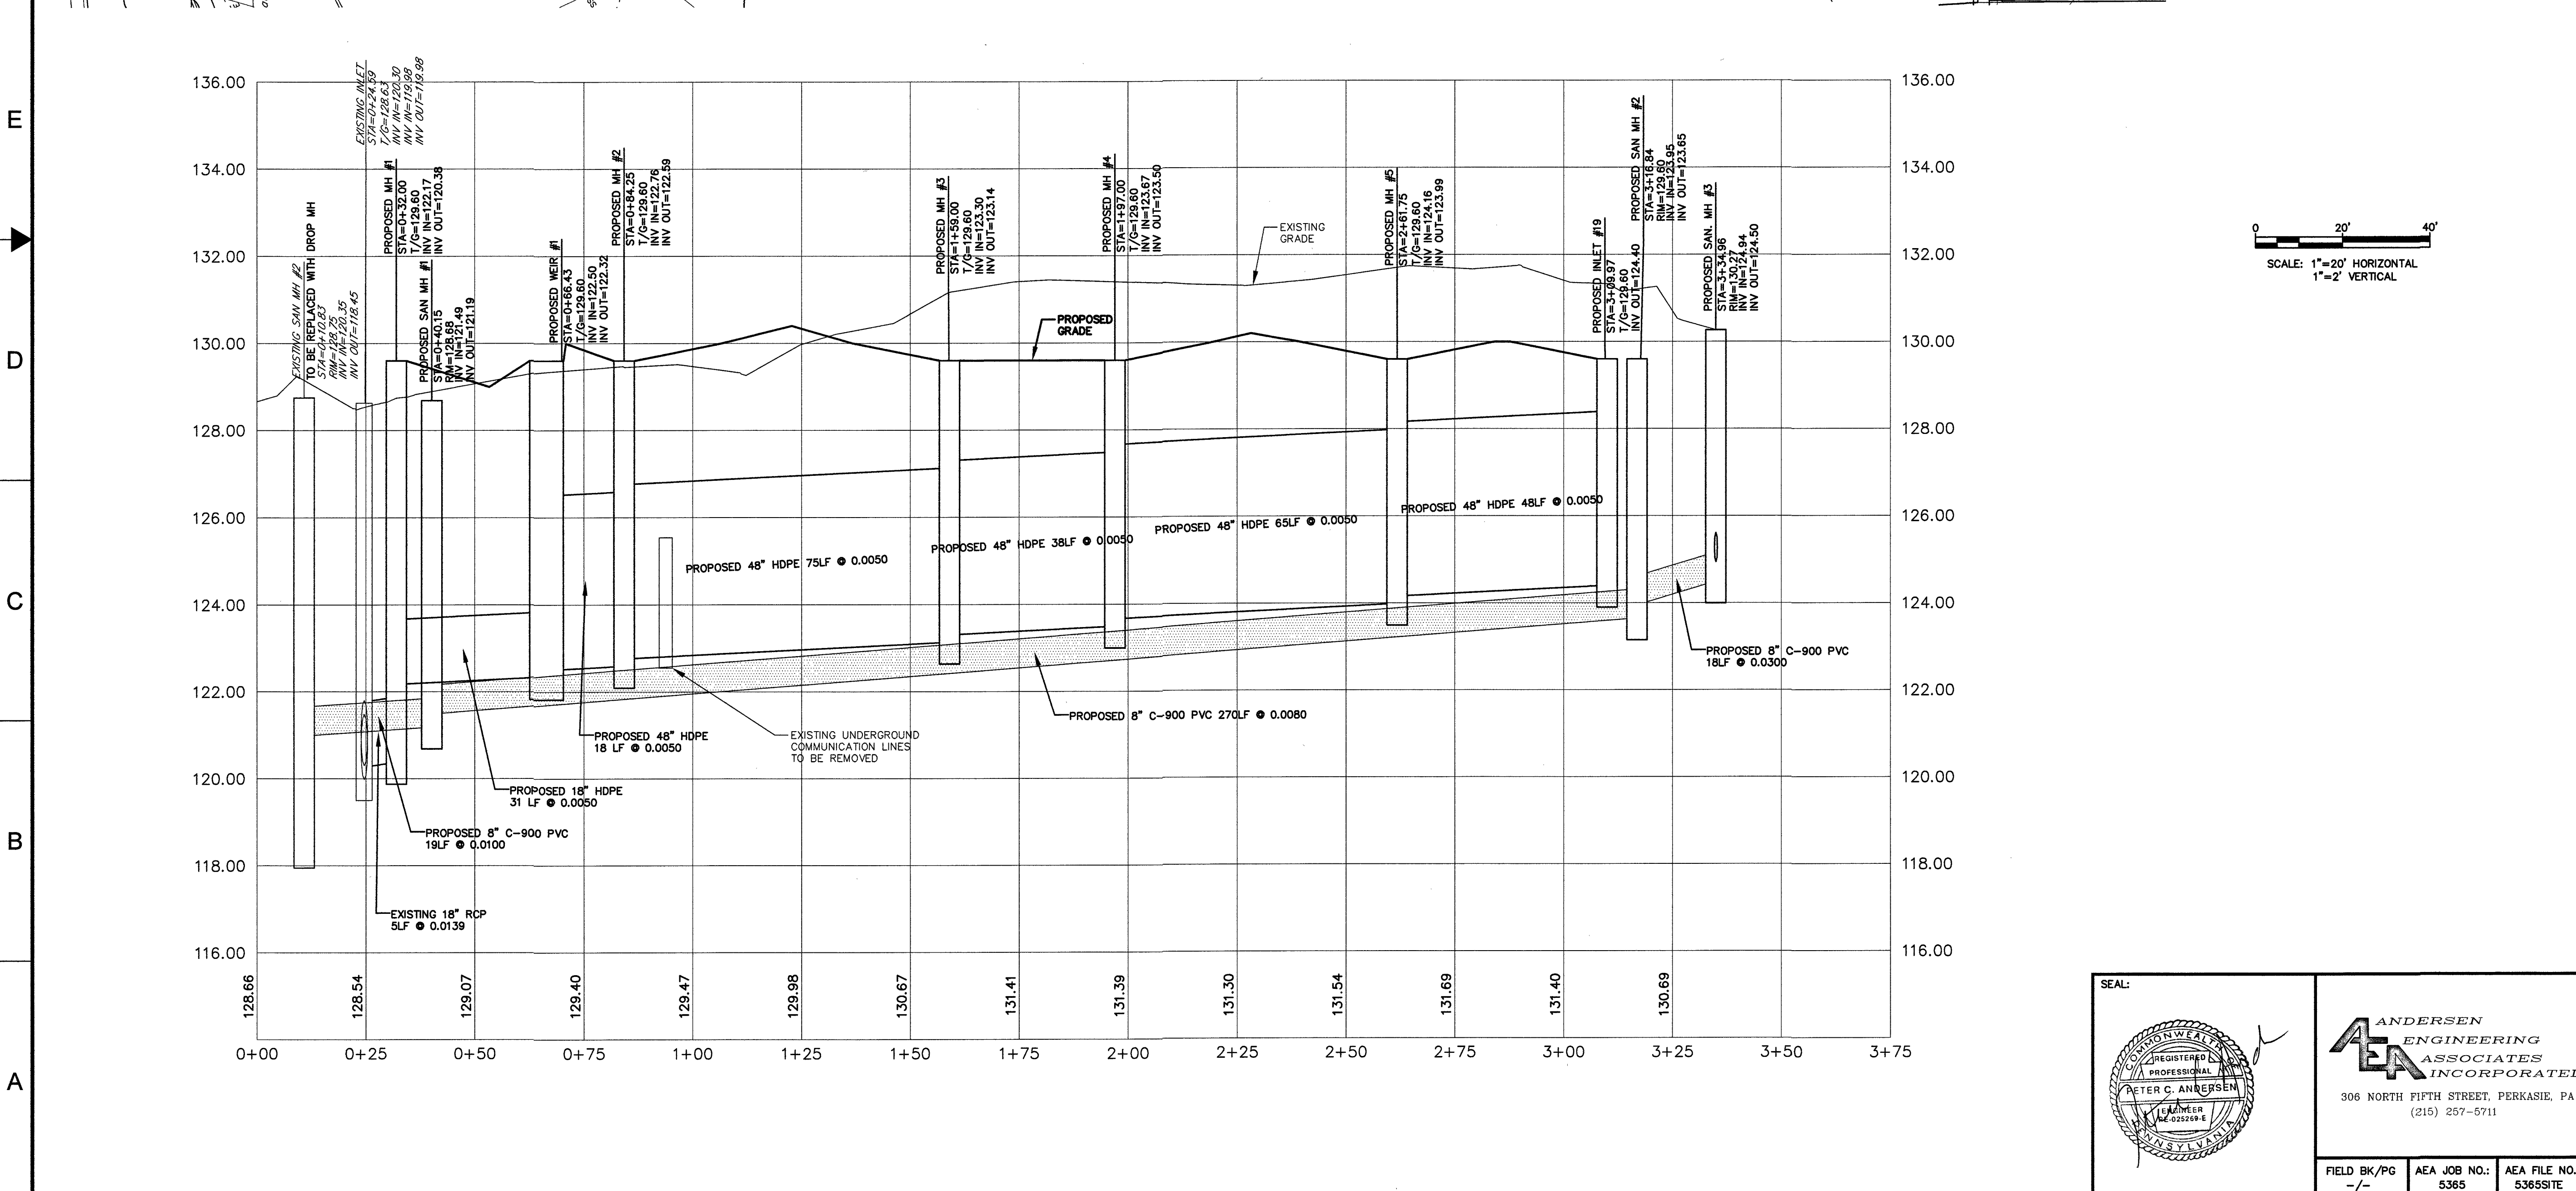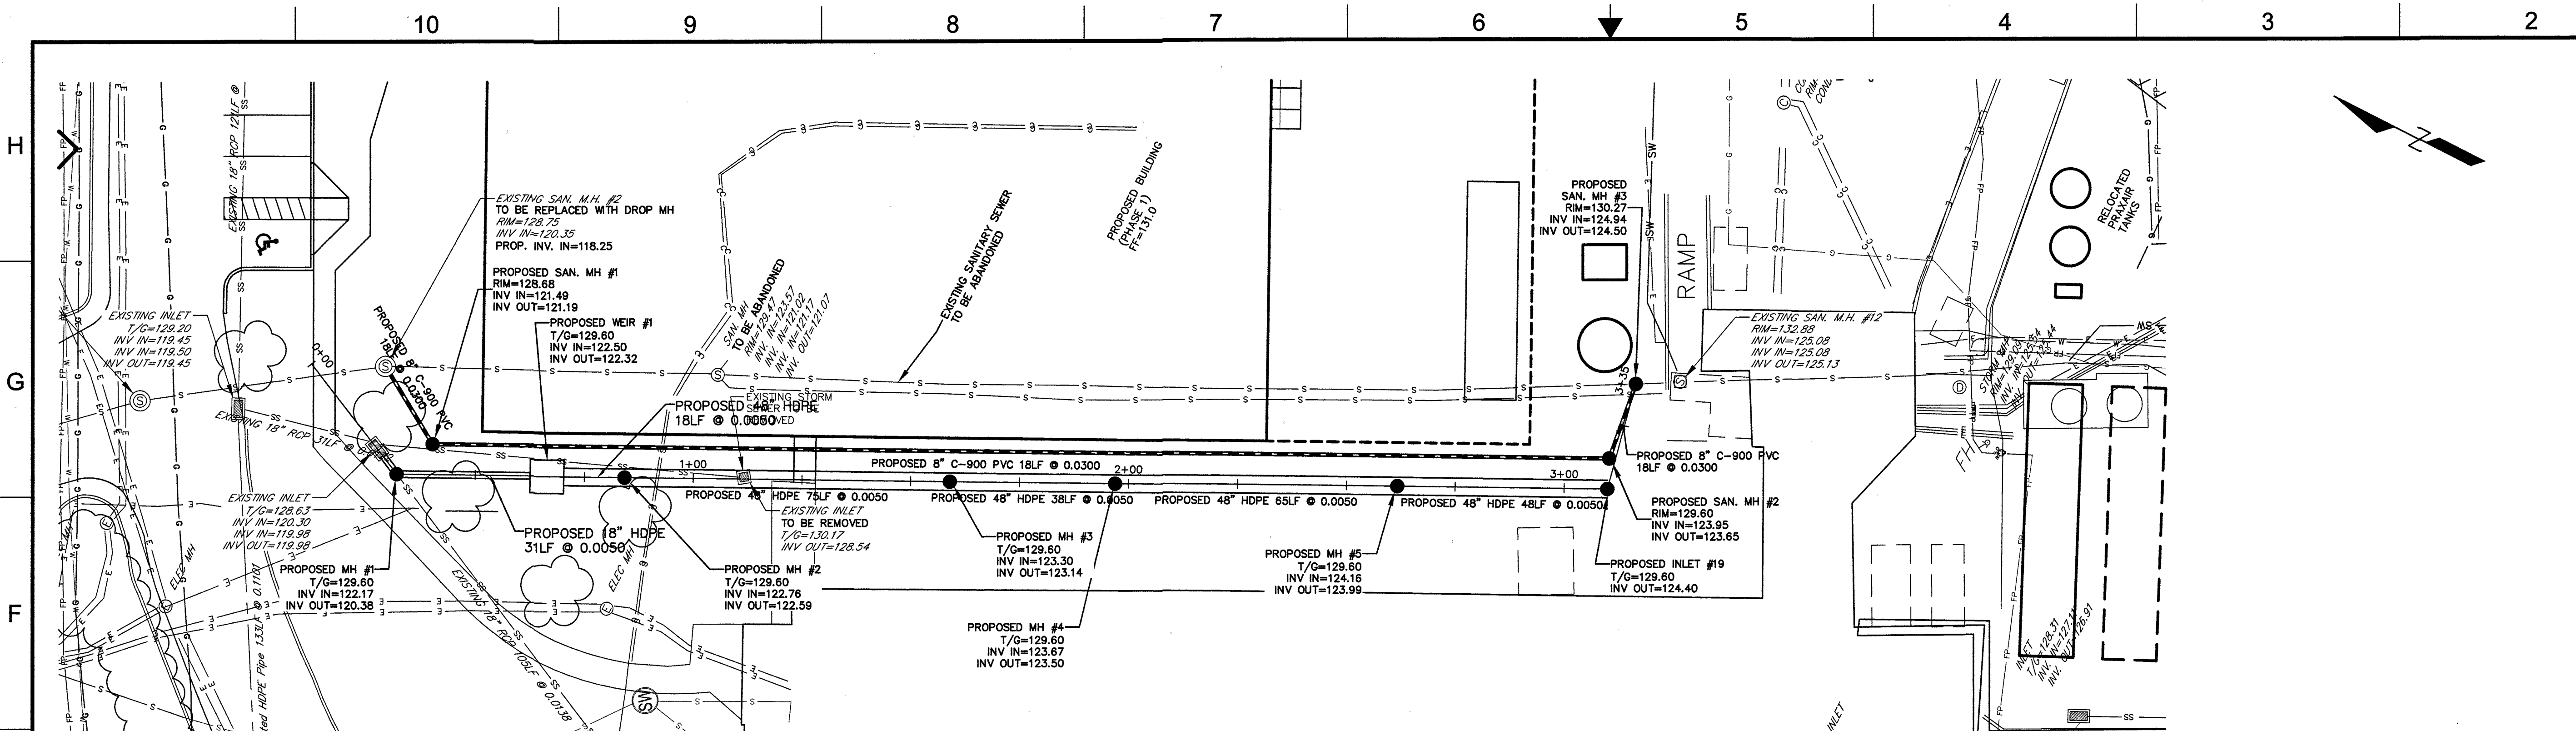

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PAGE No.	DRAWING No.	TITLE

REVISION	DATE REVISED	CONTROL NUMBER

KEY PLAN

gsk do more feel better live longer

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 KING-OF-PRUSSIA, PA 19406
 (610) 270-5281

SITE: UPPER MERION	Note: Previous Drawing Reference can be used for old drawing numbers or any previous reference that needs to be retained.
BUILDING: CENTRAL UTILITIES PLANT	
FLOOR:	
TITLE: PROPOSED CENTRAL UTILITIES PLANT (CUP) BUILDING	
PROJECT TITLE: PLAN AND PROFILE	
DRN BY: T.L.C.	DRN BY DATE: 10/27/16
CHKD BY: P.C.A.	CHKD BY DATE:
PROJECT REF:	SCALE @ E1: 1" = 20'
LEGACY GSK DRAWING DWG NO. (SEE NOTE ABOVE):	SHEET NO. 7 OF 21
LEGACY GSK DRAWING DWG NO. (SEE NOTE ABOVE):	REV:


SEAL:

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FIELD BK/Pg: -/-	AEA JOB NO.: 5365	AEA FILE NO.: 5365SITE
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- LEGEND:**
- - - - - 5/10 - - - - - EXISTING CONTOURS
 - --- --- EXISTING WOODS
 - --- --- EXISTING BRUSH
 - - - - - EXISTING RIGHT-OF-WAY LINE
 - - - - - EXISTING FENCE
 - - - - - PROPOSED FENCE
 - - - - - EXISTING EDGE OF PAVEMENT
 - ☼ EXISTING LIGHT
 - - - - - EXISTING UNDERGROUND COMMUNICATIONS
 - - - - - EXISTING UNDERGROUND ELECTRIC
 - - - - - EXISTING UNDERGROUND GAS LINE
 - - - - - EXISTING WATER LINE
 - - - - - PROPOSED CONTOUR
 - - - - - EXISTING CURB
 - - - - - PROPOSED CURB
 - - - - - PROPOSED FLUSH CURB
 - - - - - EXISTING PAINT STRIPING
 - - - - - PROPOSED PAINT STRIPING
 - - - - - EXISTING SANITARY SEWER
 - - - - - EXISTING STORM SEWER, MANHOLE AND INLET
 - - - - - M.H. PROPOSED STORM SEWER, MANHOLE AND INLET
 - - - - - EXISTING SIDEWALK
 - - - - - PROPOSED SIDEWALK
 - - - - - 12" ss COMPOST SILT SOCK WITH SIZE
 - - - - - WATERSHED/STORMWATER MANAGEMENT LINE
 - - - - - LIMIT OF DISTURBANCE
 - - - - - NPDES BOUNDARY LINE
 - - - - - SOILS BOUNDARY LINE
 - ○ ○ ○ ○ EXISTING PAVEMENT TO BE REPLACED
 - ■ ■ ■ ■ PROPOSED PAVEMENT
 - ▨ ▨ ▨ ▨ ▨ EXISTING PAVEMENT CONVERTED TO LANDSCAPING

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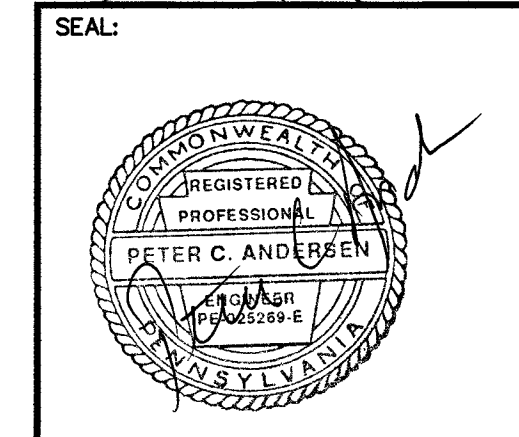
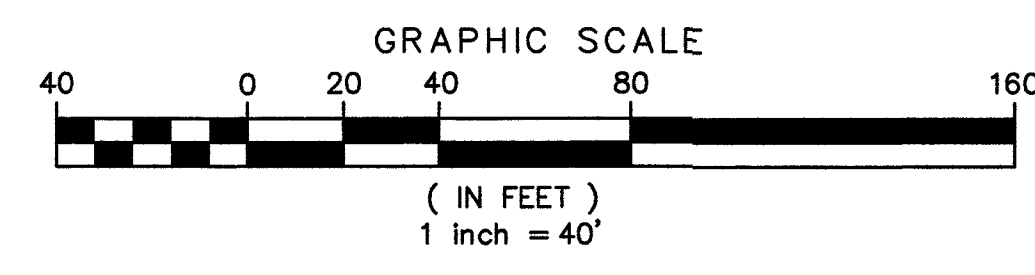
KEY PLAN

gsk do more feel better live longer

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 (810) 270-5261

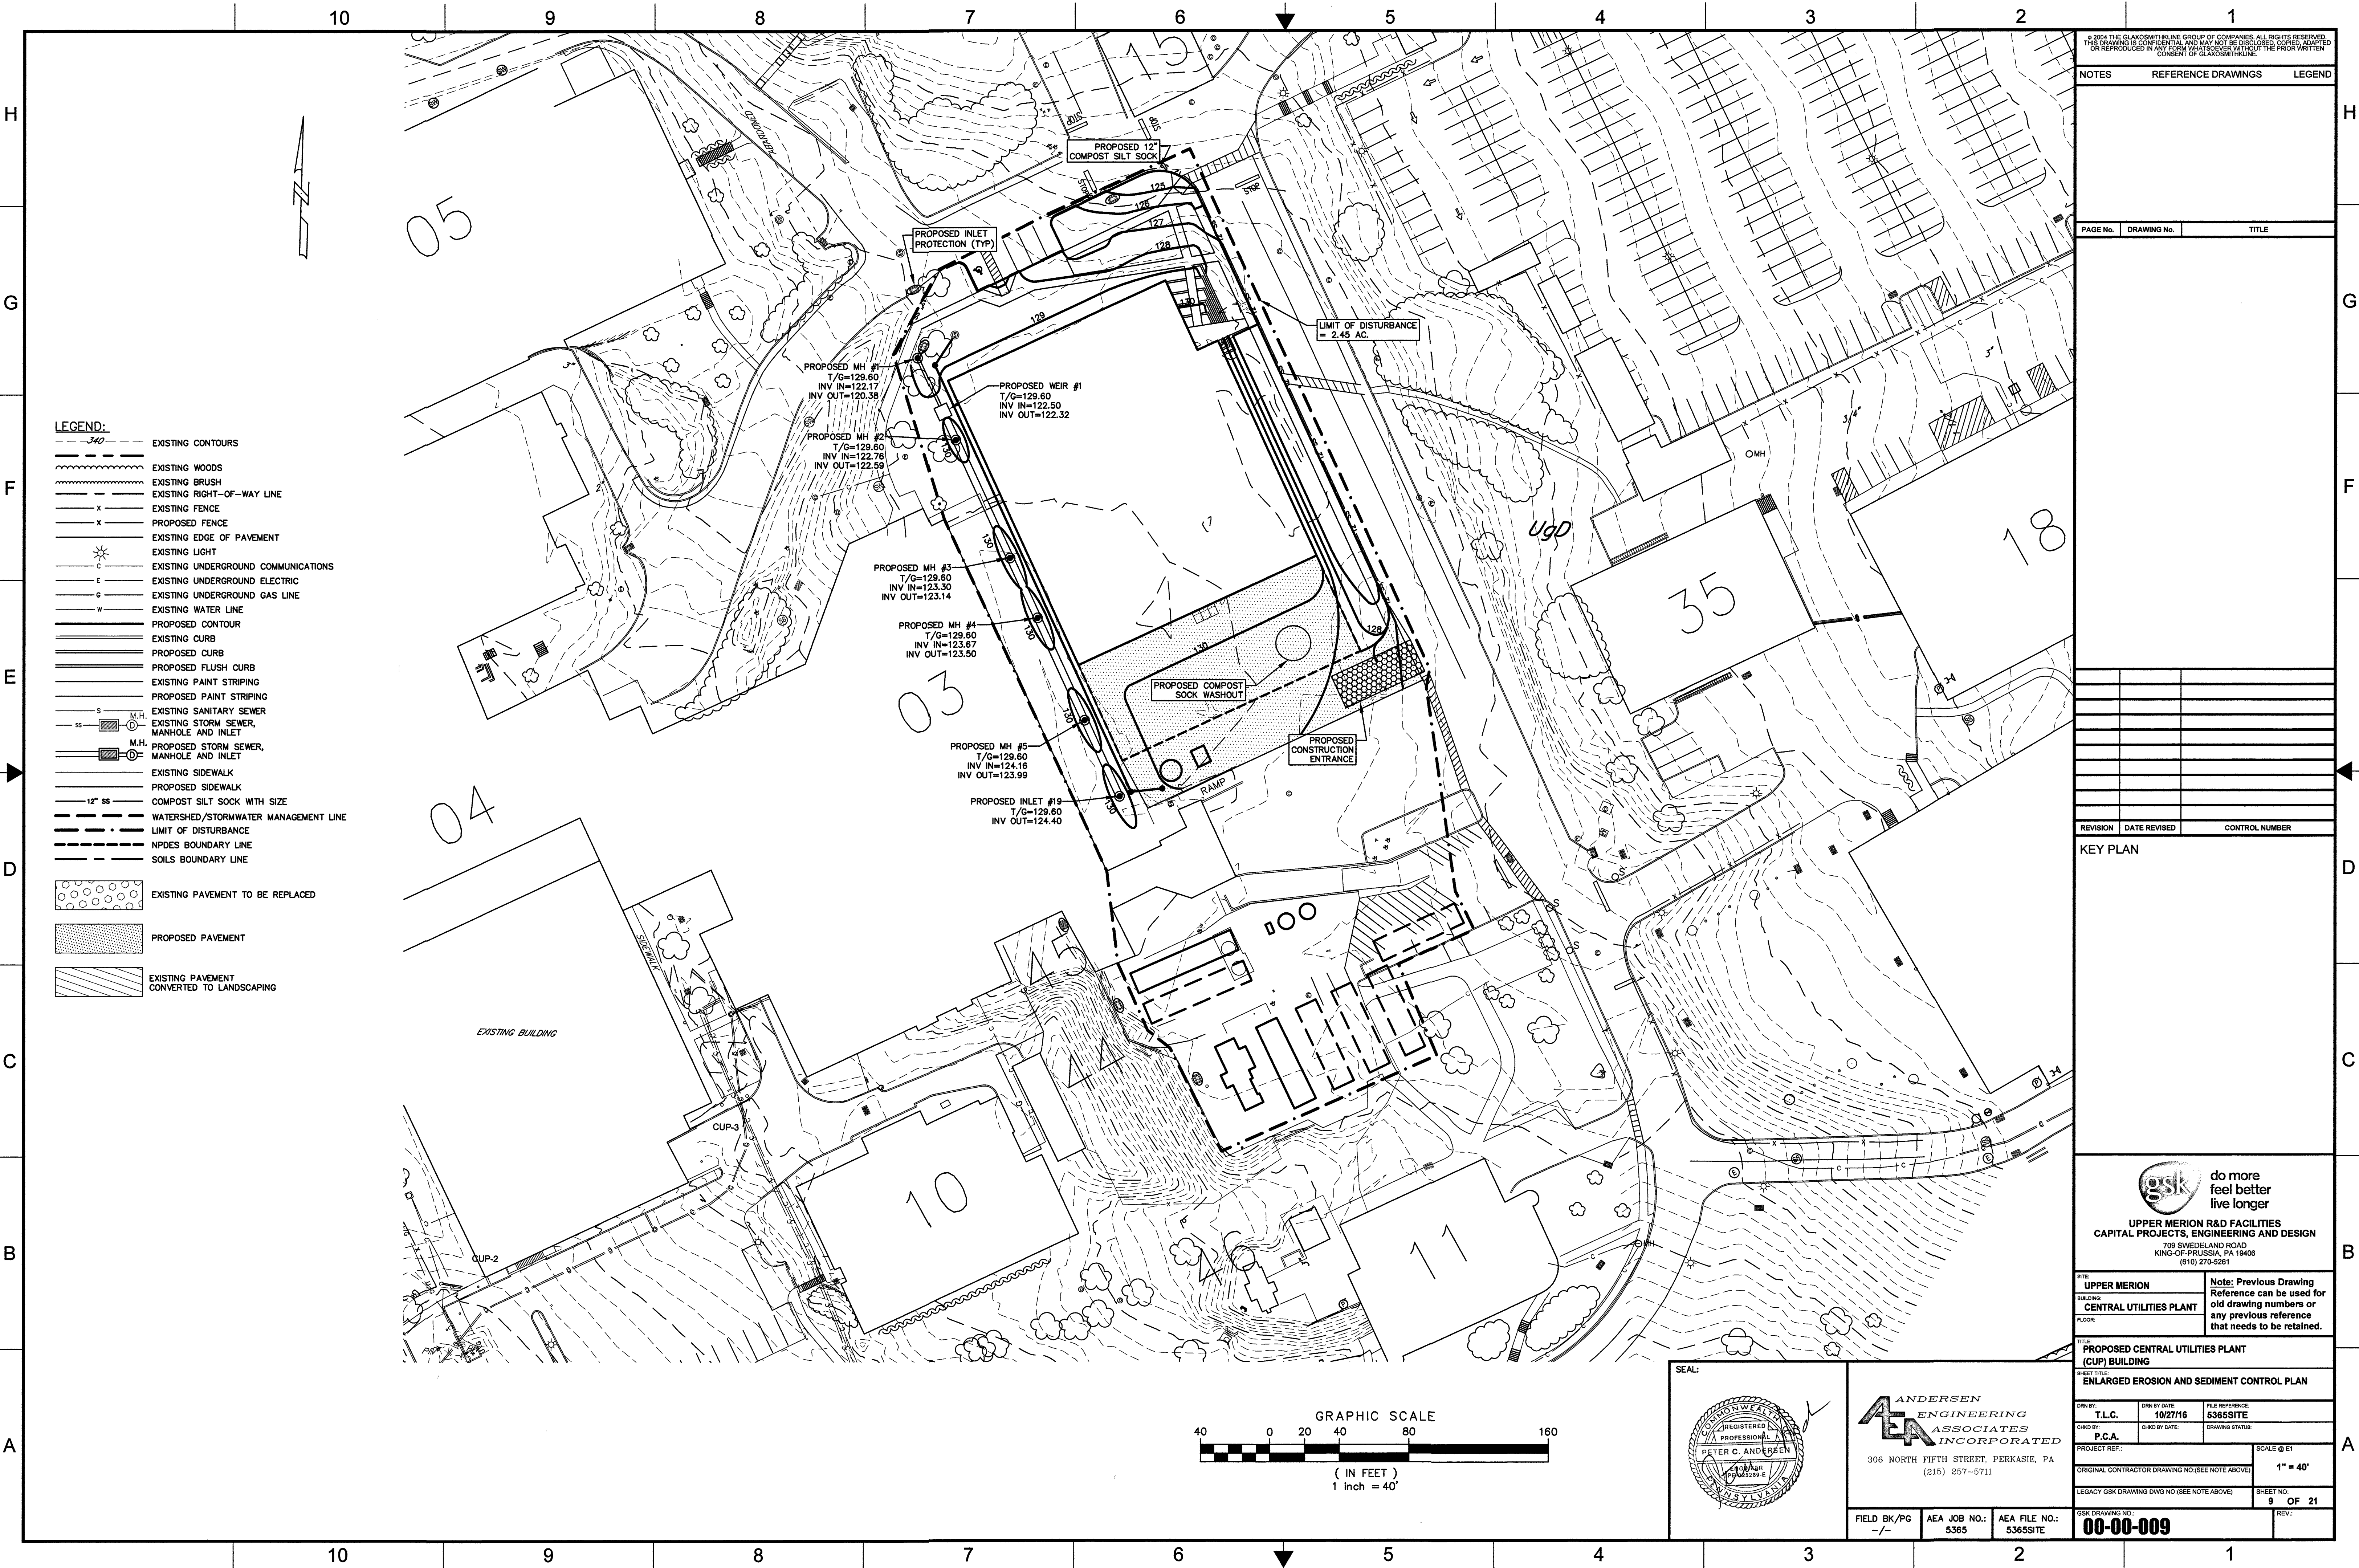SITE: UPPER MERION	Notes: Previous Drawing Reference can be used for old drawing numbers or any previous reference that needs to be retained.
BUILDING: CENTRAL UTILITIES PLANT	
FLOOR:	
TITLE: PROPOSED CENTRAL UTILITIES PLANT (CUP) BUILDING	
SHEET TITLE: ENLARGED EROSION AND SEDIMENT CONTROL PLAN	

DRN BY: T.L.C.	DRN BY DATE: 10/27/16	FILE REFERENCE: 5365SITE
CHKD BY: P.C.A.	CHKD BY DATE:	DRAWING STATUS:
PROJECT REF:		SCALE @ 81: 1" = 40'
ORIGINAL CONTRACTOR DRAWING NO. (SEE NOTE ABOVE)		
LEGACY GSK DRAWING DWG NO. (SEE NOTE ABOVE)		SHEET NO. 9 OF 21
GSK DRAWING NO.: 00-00-009		REV:



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FIELD BK/Pg: -/-	AEA JOB NO.: 5365	AEA FILE NO.: 5365SITE
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STANDARD E&S CONTROL PLAN NOTES

1. ALL EARTH DISTURBANCES, INCLUDING CLEARING AND GRUBBING TO A MINIMUM DEPTH OF 3 TO 5 INCHES - PRIOR TO PLACEMENT OF TOPSOIL. AREAS TO BE VEGETATED SHALL HAVE A MINIMUM 4 INCHES OF TOPSOIL IN PLACE PRIOR TO SEEDING AND MULCHING. FILL OPERATIONS SHALL HAVE A MINIMUM OF 2 INCHES OF TOPSOIL.
2. ALL FILLS SHALL BE COMPACTED AS REQUIRED TO REDUCE EROSION, SLIPPAGE, SETTLEMENT, SUBSIDENCE OR OTHER RELATED PROBLEMS. FILL INTENDED TO SUPPORT BUILDINGS, STRUCTURES AND CONDUITS, ETC. SHALL BE COMPACTED IN ACCORDANCE WITH LOCAL REQUIREMENTS OR CODES.
21. ALL EARTHEN FILLS SHALL BE PLACED IN COMPACTED LAYERS NOT TO EXCEED 9 INCHES IN THICKNESS.
22. FILL MATERIALS SHALL BE FREE OF FROZEN PARTICLES, BRUSH, ROOTS, SOIL, OR OTHER FOREIGN OR OBJECTIVE MATERIALS THAT WOULD INTERFERE WITH OR PREVENT CONSTRUCTION OF SATISFACTORY FILLS.
23. FROZEN MATERIALS OR SOFT, MUCKY, OR HIGHLY COMPRESSIBLE MATERIALS SHALL NOT BE INCORPORATED INTO FILLS.
24. FILL SHALL NOT BE PLACED ON SATURATED OR FROZEN SURFACES.
25. SEEPS OR SPRINGS ENCOUNTERED DURING CONSTRUCTION SHALL BE HANDLED IN ACCORDANCE WITH THE STANDARD AND SPECIFICATION FOR SUBSURFACE DRAIN OR OTHER APPROVED METHOD.
26. ALL GRADED AREAS SHALL BE PERMANENTLY STABILIZED IMMEDIATELY UPON REACHING FINISHED GRADE. CUT SLOPES IN COMPLETE BEDROCK AND ROCK FILLS NEED NOT BE VEGETATED. SEED AREAS WITHIN 50 FEET OF A SURFACE WATER, OR AS OTHERWISE SHOWN ON THE PLAN DRAWINGS, SHALL BE BLANKETED ACCORDING TO THE STANDARDS OF THIS PLAN.
27. IMMEDIATELY AFTER EARTH DISTURBANCE ACTIVITIES CEASE IN ANY AREA OR SUBAREA OF THE PROJECT, THE OPERATOR SHALL STABILIZE ALL DISTURBED AREAS. DURING NON-GERMINATING MONTHS, MULCH OR PROTECTIVE BLANKETING SHALL BE APPLIED AS DESCRIBED IN THE PLAN. AREAS NOT AT FINISHED GRADE, WHICH WILL BE REACTIVATED WITHIN 1 YEAR, MAY BE STABILIZED IN ACCORDANCE WITH THE TEMPORARY STABILIZATION SPECIFICATIONS. THOSE AREAS WHICH WILL NOT BE REACTIVATED WITHIN 1 YEAR SHALL BE STABILIZED IN ACCORDANCE WITH THE PERMANENT STABILIZATION SPECIFICATIONS.
28. PERMANENT STABILIZATION IS DEFINED AS A MINIMUM UNIFORM, PERENNIAL 70% VEGETATIVE COVER OR OTHER PERMANENT NON-VEGETATIVE COVER WITH A DENSITY SUFFICIENT TO RESIST ACCELERATED EROSION, CUT AND FILL SLOPES SHALL BE CAPABLE OF RESISTING FAILURE DUE TO SLUMPING, SLIDING, OR OTHER MOVEMENTS.
29. E&S BMP'S SHALL REMAIN FUNCTIONAL AS SUCH UNTIL ALL AREAS TRIBUTARY TO THEM ARE PERMANENTLY STABILIZED OR UNTIL THEY ARE REPLACED BY ANOTHER BMP APPROVED BY THE LOCAL CONSERVATION DISTRICT OR THE DEPARTMENT.
30. UPON COMPLETION OF ALL EARTH DISTURBANCE ACTIVITIES AND PERMANENT STABILIZATION OF ALL DISTURBED AREAS, THE OWNER AND/OR OPERATOR SHALL CONTACT THE LOCAL CONSERVATION DISTRICT FOR AN INSPECTION PRIOR TO REMOVAL/CONVERSION OF THE E&S BMP'S.
31. AFTER FINAL SITE STABILIZATION HAS BEEN ACHIEVED, TEMPORARY EROSION AND SEDIMENT BMP'S SHALL BE REMOVED OR CONVERTED TO PERMANENT POST CONSTRUCTION STORMWATER MANAGEMENT BMP'S. AREAS DISTURBED DURING REMOVAL OR CONVERSION OF THE BMP'S SHALL BE STABILIZED IMMEDIATELY IN ORDER TO ENSURE RAPID REVEGETATION OF DISTURBED AREAS, SUCH REMOVAL/CONVERSIONS ARE TO BE DONE ONLY DURING THE GERMINATING SEASON.
32. UPON COMPLETION OF ALL EARTH DISTURBANCE ACTIVITIES AND PERMANENT STABILIZATION OF ALL DISTURBED AREAS, THE OWNER AND/OR OPERATOR SHALL CONTACT THE LOCAL CONSERVATION DISTRICT TO SCHEDULE A FINAL INSPECTION.
33. FAILURE TO CORRECTLY INSTALL E&S BMP'S, FAILURE TO PREVENT SEDIMENT-LADEN RUNOFF FROM LEAVING THE CONSTRUCTION SITE OR FAILURE TO TAKE IMMEDIATE CORRECTIVE ACTION TO RESOLVE FAILURE OF E&S BMP'S MAY RESULT IN ADMINISTRATIVE, CIVIL, AND/OR CRIMINAL PENALTIES BEING INSTITUTED BY THE DEPARTMENT AS DEFINED IN SECTION 602 OF THE PENNSYLVANIA CLEAN STREAMS LAW. THE CLEAN STREAMS LAW PROVIDES FOR UP TO \$10,000 PER DAY IN CIVIL PENALTIES, UP TO \$10,000 IN SUMMARY CRIMINAL PENALTIES, AND UP TO \$25,000 IN MISDEMEANOR CRIMINAL PENALTIES FOR EACH VIOLATION.

17. SEDIMENT TRACKED ONTO ANY PUBLIC ROADWAY OR SIDEWALK SHALL BE RETURNED TO THE CONSTRUCTION SITE BY THE END OF EACH WORK DAY AND DISPOSED IN THE MANNER DESCRIBED IN THIS PLAN. IN NO CASE SHALL THE SEDIMENT BE WASHED, SHOVELED, OR SWEPT INTO ANY ROADSIDE DITCH, STORM SEWER, OR SURFACE WATER.
18. ALL SEDIMENT REMOVED FROM BMP'S SHALL BE DISPOSED OF IN THE MANNER DESCRIBED ON THE PLAN DRAWINGS.

PROPOSED AREA OF DISTURBANCE = 5.51 AC.

RESPONSIBILITIES FOR FILL MATERIAL

THE CONTRACTOR SHALL BE RESPONSIBLE TO PERFORM ENVIRONMENTAL DUE DILIGENCE AND DETERMINE THAT ALL FILL IMPORTED TO THE SITE MEETS THE DEP DEFINITION OF CLEAN FILL. THE RESPONSIBILITIES OF DUE DILIGENCE INVOLVES INVESTIGATIVE TECHNIQUES, INCLUDING, BUT NOT LIMITED TO, VISUAL PROPERTY INSPECTIONS, ELECTRONIC DATA BASE SEARCHES, REVIEW OF OWNERSHIP AND USE HISTORY OF PROPERTY, SANBORN MAPS, ENVIRONMENTAL QUESTIONNAIRES, TRANSACTION SCREENS, ANALYTICAL TESTING, ENVIRONMENTAL ASSESSMENTS OR AUDITS. CLEAN FILL SHALL BE UNCONTAMINATED, NON-WATER-SOLUBLE, NON-DECOMPOSED INERT SOLID MATERIAL. CLEAN FILL INCLUDES SOIL, ROCK, STONE DREDGED MATERIAL, USED ASPHALT, AND BRICK, BLOCK OR CONCRETE FROM CONSTRUCTION AND DEMOLITION ACTIVITIES THAT IS SEPARATE FROM OTHER WASTE AND RECOGNIZED AS SUCH. (25 PA CODE §§ 271.101 AND 287.101) THE TERM DOES NOT INCLUDE MATERIALS PLACED IN OR ON THE WATERS OF THE COMMONWEALTH UNLESS OTHERWISE NOTED.

RECEIVING WATERS CLASSIFICATION

THE RECEIVING WATERS FOR ALL DRAINAGE AREAS OF THE PROPOSED PROJECT ARE TO A TRIBUTARY TO THE SCHUYKILL RIVER. THE PA DEP CHAPTER 93 CLASSIFICATION IS WWF, MF.

NOTIFICATION REGARDING MAINTENANCE OF PUBLIC STREETS DURING CONSTRUCTION ACTIVITY

MUD SEDIMENT AND/OR DEBRIS TRACKED FROM THE SITE ONTO PUBLIC CARTWAY SHALL BE IMMEDIATELY REMOVED BY BROOMING AND/OR MECHANICAL MEANS TO THE SATISFACTION OF THE TOWNSHIP. USE OF A BRUSHED BUCKET TO SCRAPE SURFACE IS PROHIBITED. WHERE MUD AND/OR SEDIMENT IS CAUSING SLICK AND/OR HAZARDOUS CONDITIONS, ROADWAY SURFACE SHALL BE IMMEDIATELY PRESSURE WASHED TO REMOVE CONTAMINATION. ALL SEDIMENT LADEN WATER MUST BE FILTERED IN A MANNER SATISFACTORY TO THE LOCAL CONSERVATION DISTRICT BEFORE ENTERING STORM SEWERS AND/OR DRAINAGE CHANNELS.

OPTIONAL NOTES

- THE FOLLOWING NOTES SHOULD BE ADDED TO PLAN DRAWINGS AS APPLICABLE.
1. CONCRETE WASH WATER SHALL BE HANDLED IN THE MANNER DESCRIBED ON THE PLAN DRAWINGS. IN NO CASE SHALL IT BE ALLOWED TO ENTER ANY SURFACE WATERS OR UNDERGROUND SYSTEMS.
 2. ALL CHANNELS SHALL BE KEPT FREE OF OBSTRUCTIONS INCLUDING BUT NOT LIMITED TO FILL, ROCKS, LEAVES, WOODY DEBRIS, ACCUMULATED SEDIMENT, EXCESS VEGETATION, AND CONSTRUCTION MATERIAL/WASTES.
 3. UNDERGROUND UTILITIES CUTTING THROUGH ANY ACTIVE CHANNEL SHALL BE IMMEDIATELY BACKFILLED AND THE CHANNEL RESTORED TO ITS ORIGINAL CROSS-SECTION AND PROTECTIVE LINING. ANY BASE FLOW WITHIN THE CHANNEL SHALL BE CONVEYED PAST THE WORK AREA IN THE MANNER DESCRIBED IN THIS PLAN UNTIL SUCH RESTORATION IS COMPLETE.
 4. CHANNELS HAVING RIPRAP, RENO MATTRESS, OR CABION LININGS MUST BE SUFFICIENTLY OVER-EXCAVATED TO THAT THE DESIGN DIMENSIONS WILL BE PROVIDED AFTER PLACEMENT OF THE PROTECTIVE LINING.
 5. SEDIMENT BASINS AND/OR TRAPS SHALL BE KEPT FREE OF ALL CONSTRUCTION WASTE, WASH WATER, AND OTHER DEBRIS HAVING POTENTIAL TO CLOG THE BASIN/TRAP OUTLET STRUCTURES AND/OR POLLUTE THE SURFACE WATERS.
 6. SEDIMENT BASINS SHALL BE PROTECTED FROM UNAUTHORIZED ACTS BY THIRD PARTIES.
 7. ANY DAMAGE THAT OCCURS IN WHOLE OR IN PART AS A RESULT OF BASIN OR TRAP DISCHARGE SHALL BE IMMEDIATELY REPAIRED BY THE PERMITTEE IN A PERMANENT MANNER SATISFACTORY TO THE MUNICIPALITY, LOCAL CONSERVATION DISTRICT, AND THE OWNER OF THE DAMAGED PROPERTY.
 8. UPON REQUEST, THE APPLICANT OR HIS CONTRACTOR SHALL PROVIDE AS-BUILT (RECORD DRAWING) FOR ANY SEDIMENT BASIN OR TRAP TO THE MUNICIPAL INSPECTOR, LOCAL CONSERVATION DISTRICT OR THE DEPARTMENT.
 9. EROSION CONTROL BLANKETING SHALL BE INSTALLED ON ALL SLOPES 3:1V OR STEEPER WITHIN 50 FEET OF A SURFACE WATER AND ALL OTHER DISTURBED AREAS SPECIFIED ON THE PLAN MAPS AND/OR DETAIL SHEETS.
 10. FILL MATERIAL FOR EMBANKMENTS SHALL BE FREE OF ROOTS, OR OTHER WOODY VEGETATION, ORGANIC MATERIAL, LARGE STONES, AND OTHER OBJECTIONABLE MATERIALS. LARGE STONES, AND OTHER OBJECTIONABLE MATERIALS, WHEN LAYERS SHALL BE COMPACTED IN MAXIMUM LAYERED LIFTS AT _____ % DENSITY.

RESPONSES TO SOIL LIMITATIONS:

- *USE SUFFICIENT AND PROPER BEST MANAGEMENT PRACTICES TO MINIMIZE EROSION.
- *DO NOT PERFORM TRENCHING, BACKFILLING OR COMPACTING WHEN WEATHER CONDITIONS OR THE CONDITION OF MATERIAL IS SUCH THAT WHICH IS BEING IMPLEMENTED AND MAINTAINED ACCORDING TO CHAPTER 102 REGULATIONS. ALL PAVING DEBRIS AND ROCKS REMOVE DURING FINAL LANDSCAPE RESTORATION SHALL BE COMPLETELY REMOVED FROM SITE AND DISPOSED OF IN THE PROPER MANNER. THERE SHALL BE NO ON-SITE BURIAL OR BURNING OF ANY MATERIAL.
- *DO NOT USE BACKFILL MATERIALS CONTAINING MOISTURE IN EXCESS OF THE AMOUNT NECESSARY FOR COMPACTION.
- *PLAN WORK SO AS TO PROVIDE ADEQUATE PROTECTION DURING STORMS WITH PROVISIONS AVAILABLE FOR PREVENTING FLOOD DAMAGE.
- *KEEP EXCAVATIONS FREE FROM WATER DURING THE PERFORMANCE OF WORK PROVIDE AND OPERATE PUMPS WITH SUFFICIENT CAPACITY FOR Dewatering THE EXCAVATIONS. PONDED WATER TO BE PUMPED THROUGH A FILTER BAG.
- *USE SOIL SUITED FOR SITE CONDITIONS; PROVIDE SUFFICIENT TOPSOIL PREPARATION AND MULCHING.
- *WORK DURING WARM WEATHER MONTHS TO ACHIEVE THESE ENDS.

E&S CONSTRUCTION SEQUENCE

NOTE: ALL EARTH DISTURBANCE ACTIVITIES SHALL PROCEED IN ACCORDANCE WITH THE FOLLOWING SEQUENCE. EACH STAGE SHALL BE COMPLETED BEFORE ANY FOLLOWING STAGE IS INITIATED. CLEARING AND GRUBBING SHALL BE LIMITED ONLY TO THOSE AREAS DESCRIBED IN EACH STAGE. A PROFESSIONAL OR DESIGNER WILL BE PRESENT ON SITE DURING INSTALLATION OF STORMWATER BMP'S THAT ARE LISTED AS CRITICAL STAGES.

1. DELINEATE THE LIMIT OF DISTURBANCE WITH CONSTRUCTION FENCE. (TOTAL 1 DAY)
2. INSTALL EROSION AND SEDIMENT CONTROL BMP'S IN THE FOLLOWING ORDER:
 1. CONSTRUCTION ENTRANCE
 2. COMPOST FILTER SOCK (TOTAL 2 DAYS)
3. CONSTRUCT SEDIMENTATION TRAP. (4 DAYS) - CRITICAL STAGE
4. DEMOLISH EXISTING STRUCTURES AS NECESSARY.
5. CLEAR AND GRUB AREA TO BE GRADED FOR PROPOSED IMPROVEMENTS (2 DAYS).
6. ROUGH GRADE AREA FOR PROPOSED IMPROVEMENTS.
7. TEMPORARILY STABILIZE DISTURBED AREA.
8. INSTALL STORM SEWER, SANITARY SEWER (10 DAYS) CRITICAL STAGE
9. CONSTRUCT PROPOSED PARKING AND BUILDING. STABILIZE DISTURBED AREAS OF EACH AS THEY ARE COMPLETED (180 DAYS)
10. CONVERT SEDIMENTATION TRAP TO RAIN GARDEN/DETENTION BASIN (5 DAYS)
11. INSTALL OUTLET STRUCTURE, UNDER DRAIN AND OUTLET PIPE. (5 DAYS)
12. FINE GRADE. (2 DAYS)
13. PERMANENTLY STABILIZE DISTURBED AREAS. (2 DAYS)
14. ONCE PERMANENT STABILIZATION HAS BEEN ACHIEVED, REMOVE ALL EROSION AND SEDIMENT CONTROL BMP'S AND RE-STABILIZE AFFECTED AREAS.

SEEDING SPECIFICATIONS:

- TEMPORARY SEEDING AND MULCHING SPECIFICATIONS**
- A) LIME: PULVERIZED AGRICULTURAL LIMESTONE. APPLICATION RATE: 80 LBS. PER 1000 S.F. (DETERMINE ACTUAL NEED FOR LIME WITH SOIL TEST)
 - B) FERTILIZER: 10-20-20 ANALYSIS COMMERCIAL FERTILIZER APPLICATION RATE: 192 LBS. PER 1000 S.F.
 - C) SEED: ANNUAL RYE GRASS APPLICATION RATE: 3 LBS. PER 1000 S.F.
 - D) MULCH: STRAW OR UNROTTED SALT HAY TO BE APPLIED AFTER SEEDING APPLICATION RATE: 3 TONS PER ACRE OR 138 LBS. PER 1000 S.F.

- PERMANENT SEEDING AND MULCHING SPECIFICATIONS**
- A) LIME: PULVERIZED AGRICULTURAL LIMESTONE. APPLICATION RATE: 50 LBS. PER 1000 S.F. (DETERMINE ACTUAL NEED FOR LIME WITH SOIL TEST)
 - B) FERTILIZER: 10-8-4 ANALYSIS COMMERCIAL FERTILIZER APPLICATION RATE: 35 LBS. PER 1000 S.F.
 - C) SEED: 60% KENTUCKY BLUEGRASS 30% CREEPING RED FESCUE 10% FINE LEAF RYE APPLICATION RATE: 6 LBS. PER 1000 S.F.
 - D) MULCH: STRAW OR UNROTTED SALT HAY TO BE APPLIED AFTER SEEDING APPLICATION RATE: 3 TONS PER ACRE OR 138 LBS. PER 1000 S.F.

LAND USE

EXISTING LAND USE IS INDUSTRIAL - RESEARCH AND DEVELOPMENT. THE LAND USE IN THE PAST 50 YEARS WAS AGRICULTURAL.

THERMAL IMPACTS

IT IS ANTICIPATED THAT THE INFILTRATION BMP'S WILL ACT TO ATTENUATE THERMAL IMPACTS.

MEASURES FOR RECYCLING/DISPOSAL OF WASTES

BEFORE DISPOSING OF SOIL OR RECEIVING BORROW FOR THE SITE, THE OPERATOR MUST ASSURE THAT EACH SUCH BORROW OR RECEIVING AREA HAS AN EROSION AND SEDIMENT CONTROL PLAN APPROVED BY THE COUNTY CONSERVATION DISTRICT AND WHICH IS BEING IMPLEMENTED AND MAINTAINED ACCORDING TO CHAPTER 102 REGULATIONS. ALL PAVING DEBRIS AND ROCKS REMOVE DURING FINAL LANDSCAPE RESTORATION SHALL BE COMPLETELY REMOVED FROM SITE AND DISPOSED OF IN THE PROPER MANNER. THERE SHALL BE NO ON-SITE BURIAL OR BURNING OF ANY MATERIAL.

CONSTRUCTION WASTES EXPECTED TO BE CREATED DURING THE PROJECT

CONSTRUCTION WASTES EXPECTED TO BE CREATED DURING THE PROJECT CONSIST OF WOOD DEBRIS, OLD FILL MATERIAL, VEGETATIVE MATERIAL, EXCESS CONCRETE AND BUILDING MATERIAL.

NPDES GENERAL SITE NOTES

1. THIS PROJECT WAS DESIGNED TO MINIMIZE EXTENT AND DURATION OF EARTH DISTURBANCE, BY STABILIZING ANY DISTURBED AREAS AS SOON AS POSSIBLE.
2. THIS PROJECT WAS DESIGNED TO PROTECT EXISTING DRAINAGE FEATURES AND EXISTING VEGETATION BY LIMITING LAND CLEARING AND GRADING.
3. THIS PROJECT WAS DESIGNED TO MINIMIZE SOIL COMPACTION, BY LIMITING THE USE OF EQUIPMENT IN AREAS OF DISTURBANCE AND AREAS THAT ARE OUTSIDE OF THE DISTURBED AREA.
4. THIS PROJECT UTILIZES SOIL AMENDMENTS, INFILTRATION, LANDSCAPING, INFILTRATION BASIN AND DETENTION FACILITIES TO MINIMIZE CHANGES IN STORMWATER RUNOFF.
5. THERE ARE NO KNOWN GEOLOGIC OR SOIL CONDITIONS THAT MAY HAVE THE POTENTIAL TO CAUSE POLLUTION.
6. IT IS NOT ANTICIPATED THAT ANY MATERIAL THAT COULD CAUSE POLLUTION WILL BE ENCOUNTERED.
7. THERE AREN'T ANY EXISTING OR PROPOSED RIPARIAN BUFFERS OR PROPOSED INFILTRATION BASINS LOCATED OUTSIDE OF THE LIMITS OF DISTURBANCE OR OUTSIDE OF THE PROPOSED GRADING AREAS.
8. THERE AREN'T ANY RIPARIAN FOREST BUFFERS INSIDE OR OUTSIDE OF THE LIMIT OF DISTURBANCE.
9. THERE AREN'T ANY RIPARIAN BUFFERS OFFSET.
10. NO RIPARIAN BUFFER IS PROPOSED AS PART OF THIS PROJECT.
11. NO NON-DISCHARGE AND/OR ABACT BMP'S PROPOSED.
12. THIS PLAN PRESERVES THE INTEGRITY OF STREAM CHANNELS AND MAINTAINS AND PROTECTS THE PHYSICAL, BIOLOGICAL AND CHEMICAL QUALITIES OF THE RECEIVING STREAM, BY MAINTAINING THE WATER QUALITY FROM THE AREAS OF CONSTRUCTION.
13. THIS PROJECT WAS DESIGNED TO MINIMIZE GENERATION OF INCREASED STORMWATER RUNOFF, BY LIMITING THE AMOUNT OF IMPERVIOUS SURFACE.
14. THIS PROJECT WAS DESIGNED TO MINIMIZE NEW IMPERVIOUS AREAS, BY LIMITING THE NUMBER OF PARKING SPACES TO BE MINIMUM REQUIRED BY THE BOROUGH ZONING ORDINANCE. FURTHERMORE, SOME OF THE PARKING WILL NOT BE INSTALLED UNTIL IT IS REQUIRED.
15. THIS PROJECT WAS DESIGNED TO PROTECT EXISTING DRAINAGE FEATURES BY RESTRICTING THE AMOUNT OF DISTURBANCE.
16. THIS PROJECT IS NOT IN A HQ OR EV WATERSHED.
17. NO WETLANDS WILL BE DISTURBED. THERE ARE NO WETLANDS ON THIS SITE.
18. NO PROPRIETARY BMP SYSTEMS ARE PROPOSED.
19. ALL SEDIMENT REMOVED FROM BMP'S SHALL BE DISPOSED OF IN THE MANNER DESCRIBED ON THE PLANS. SEDIMENT REMOVED FROM BMP'S SHALL BE DISPOSED OF IN LANDSCAPED AREAS OUTSIDE OF STEEP SLOPES, WETLANDS, FLOODPLAINS, OR DRAINAGE SWALES AND IMMEDIATELY STABILIZED, OR PLACED IN TOPSOIL STOCKPILES.

SEEDING NOTES:

1. ANY DISTURBED AREA ON WHICH ACTIVITY HAS CEASED AND WHICH WILL REMAIN EXPOSED MUST BE SEED AND MULCHED IMMEDIATELY. DURING NON-GERMINATING PERIODS, MULCH MUST BE APPLIED AT THE RECOMMENDED RATES. DISTURBED AREAS WHICH ARE NOT AT FINISHED GRADE AND WHICH WILL BE REDISTURBED WITHIN 1 YEAR MAY BE SEED AND MULCHED WITH A QUICK GROWING TEMPORARY SEEDING MIXTURE AND MULCH. DISTURBED AREAS WHICH ARE EITHER AT FINISHED GRADE OR WITH A PERMANENT SEED MIXTURE AND MULCH.
2. SWALES, DETENTION BASINS, SEDIMENT TRAPS, STOCKPILES AND OTHER STRUCTURAL EROSION CONTROL DEVICES MUST BE SEED AND MULCHED IMMEDIATELY.

- SOUTHEAST RAIN GARDEN MIX
ERNAX # ERNAX-100-2
SEEDING RATE 20 LB PER ACRE
MIX TYPE Storm Water Management Facility Sites
- 21% Beaked Panicgrass, SC Ectype (Panicum anceps, SC Ectype)
 - 18% Little Bluestem, 'Camper' (Schizachyrium scaparium, 'Camper')
 - 16% Virginia Wildrye, GA Ectype (Elymus virginicus, GA Ectype)
 - 15% River Oats, Coastal Plain NC Ectype (Chasmanthium latifolium (Uniola latifolia), Coastal Plain NC Ectype)
 - 4% Purple Coneflower (Echinacea purpurea)
 - 4% Partridge Pea, FL Ectype (Chamaecrista fasciculata (Cassia f.), FL Ectype)
 - 3% Blackeyed Susan, Coastal Plain NC Ectype (Rudbeckia hirta, Coastal Plain NC Ectype)
 - 2% Greenwhite Sedge, Coastal Plain NC Ectype (Carex abolutescens (C. longii), Coastal Plain NC Ectype)
 - 2% Mistleflower, FL Ectype (Eupatorium coelestinum (Conoclinium c.), FL Ectype)
 - 2% Slender Woodoats, NC Ectype (Chasmanthium laxum (Uniola laxa), NC Ectype)
 - 1.5% Lanceleaf Coreopsis, Coastal Plain NC Ectype (Coreopsis lanceolata, Coastal Plain NC Ectype)
 - 1.5% Largeflower Tickseed, Piedmont GA Ectype (Coreopsis grandiflora, Piedmont GA Ectype)
 - 1% Tall Ironweed, SC Ectype (Veronica angustifolia, SC Ectype)
 - 1% Showy Aster, NC Ectype (Aster spectabilis, NC Ectype)
 - 1% Spotted Beebalm, Coastal Plain SC Ectype (Monarda punctata, Coastal Plain SC Ectype)
 - 1% Scaly Blazing Star, VA Ectype (Liatris squarrosa, VA Ectype)
 - 1% White Wild Indigo, SC Ectype (Baptisia alba, SC Ectype)
 - 1% Leathery Rush, Coastal Plain NC Ectype (Junca torricarica, Coastal Plain NC Ectype)
 - 1% Slender Bushclover, VA Ectype (Lespedeza virginica, VA Ectype)
 - 1% Rattlesnake-master, FL Ectype (Eryngium yuccifolium, FL Ectype)
 - 1% Euette Lake Beardtongue, 'Suther'-NC Ectype (Penstemon australis, 'Suther'-NC Ectype)
 - 0.5% Gray Goldenrod, VA Ectype (Solidago nemoralis, VA Ectype)
 - 0.5% Anise Goldenrod, GA Ectype (Solidago odora, GA Ectype)
- Total: 100%

E&S BMP'S INSPECTION, REPORTING, AND MONITORING:

- A. EXCEPT FOR DATA DETERMINED TO BE CONFIDENTIAL UNDER SECTION 607 OF THE CLEAN STREAMS LAW (35 P.S. §691.607), ALL REPORTS PREPARED IN ACCORDANCE WITH THE TERMS OF THIS PERMIT SHALL BE AVAILABLE FOR PUBLIC INSPECTION AT THE OFFICES OF THE DEPARTMENT OR AUTHORIZED CONSERVATION DISTRICT. AS REQUIRED BY THE CLEAN WATER ACT, THE CLEAN STREAMS LAWS, AND 25 PA. CODE, AND THE DEPARTMENT'S REGULATIONS, PERMIT APPLICATIONS, PERMITS, AND OTHER DOCUMENTS RELATED TO THIS PERMIT SHALL NOT BE CONSIDERED CONFIDENTIAL.
- B. THE PERMITTEE AND CO-PERMITTEE(S) SHALL RETAIN RECORDS OF ALL MONITORING INFORMATION INCLUDING COPIES OF ALL MONITORING AND INSPECTION REPORTS REQUIRED BY THIS PERMIT, AND RECORDS OF DATA USED TO COMPLETE THE NOTICE OF INTENT FOR THIS PERMIT, FOR A PERIOD OF THREE YEARS FROM THE DATE OF THE TERMINATION OF COVERAGE UNDER THE PERMIT.
- C. THE PERMITTEE AND CO-PERMITTEE(S) MUST ENSURE THAT VISUAL SITE INSPECTIONS ARE CONDUCTED WEEKLY, AND WITHIN 24 HOURS AFTER EACH STORM WATER EVENT THROUGHOUT THE DURATION OF CONSTRUCTION AND UNTIL THE RECEIPT AND ACKNOWLEDGEMENT OF THE NOT BY THE DEPARTMENT OR AUTHORIZED CONSERVATION DISTRICT. THE VISUAL SITE INSPECTIONS AND REPORTS SHALL BE COMPLETED IN A FORMAT PROVIDED BY THE DEPARTMENT, AND CONDUCTED BY QUALIFIED PERSONNEL TRAINED AND EXPERIENCED IN EROSION AND SEDIMENT CONTROL. TO ASCERTAIN THAT E&S BMP'S AND PCSM BMP'S ARE PROPERLY CONSTRUCTED AND MAINTAINED TO EFFECTIVELY PREVENT POLLUTION TO THE WATERS OF THIS COMMONWEALTH, A WRITTEN REPORT OF EACH INSPECTION SHALL BE KEPT AND INCLUDE AT A MINIMUM:
 - (1) A SUMMARY OF SITE CONDITIONS, E&S BMP AND PCSM BMP, IMPLEMENTATION AND MAINTENANCE AND COMPLIANCE ACTIONS; AND
 - (2) THE DATE, TIME, NAME AND SIGNATURE OF THE PERSON CONDUCTING THE INSPECTION.
- D. WHERE E&S OR PCSM BMP'S ARE FOUND TO BE INOPERATIVE OR INEFFECTIVE DURING AN INSPECTION, OR ANY OTHER TIME, THE PERMITTEE AND CO-PERMITTEE(S) SHALL IMMEDIATELY CONTACT THE DEPARTMENT OR AUTHORIZED CONSERVATION DISTRICT, BY PHONE OR PERSONAL CONTACT, FOLLOWED BY THE SUBMISSION OF A WRITTEN REPORT WITHIN 5 DAYS OF THE INITIAL CONTACT. NONCOMPLIANCE REPORTS SHALL INCLUDE THE FOLLOWING INFORMATION:
 - (1) ANY CONDITION ON THE PROJECT SITE WHICH MAY ENDANGER PUBLIC HEALTH, SAFETY, OR THE ENVIRONMENT, OR INVOLVE INCIDENTS WHICH CAUSE OR THREATEN POLLUTION;
 - (2) THE PERIOD OF NONCOMPLIANCE, INCLUDING EXACT DATES AND TIMES AND/OR ANTICIPATED TIME WHEN THE ACTIVITY WILL RETURN TO COMPLIANCE;
 - (3) STEPS BEING TAKEN TO REDUCE, ELIMINATE, AND PREVENT RECURRENCE OF THE NONCOMPLIANCE; AND
 - (4) THE DATE OR SCHEDULE OF DATES, AND IDENTIFYING REMEDIES FOR CORRECTING NONCOMPLIANCE CONDITIONS.

MEASURES FOR RECYCLING OR DISPOSAL OF MATERIALS

BEFORE DISPOSING OF SOIL OR RECEIVING BORROW FOR THE SITE, THE OPERATOR MUST ASSURE THAT EACH SUCH BORROW OR RECEIVING AREA HAS AN EROSION AND SEDIMENT CONTROL PLAN APPROVED BY THE COUNTY CONSERVATION DISTRICT AND WHICH IS BEING IMPLEMENTED AND MAINTAINED ACCORDING TO CHAPTER 102 REGULATIONS. ALL PAVING DEBRIS AND ROCKS REMOVE DURING FINAL LANDSCAPE RESTORATION SHALL BE COMPLETELY REMOVED FROM SITE AND DISPOSED OF IN THE PROPER MANNER. THERE SHALL BE NO ON-SITE BURIAL OR BURNING OF ANY MATERIAL.

SOIL TYPES AND LIMITATIONS

MAP SYMBOL & SOIL NAME	STREETS/ROAD	LAWNS & LANDSCAPING	PONDS	
			RESERVOIR AREAS	EMBANKMENTS
UgD URBAN LAND				

RESOLUTION TO SOIL LIMITATIONS

MAP SYMBOL & SOIL NAME	STREETS/ROAD	LAWNS & LANDSCAPING	PONDS	
			RESERVOIR AREAS	EMBANKMENTS
UgD URBAN LAND	PUMP PONDED WATER TO SEDIMENT BASIN OR THROUGH A DIRT BAG	NO LIMITATIONS	NO LIMITATIONS	USE FOR CORE OF EMBANKMENT

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NOTES REFERENCE DRAWINGS LEGEND

PAGE NO.	DRAWING NO.	TITLE

REVISION DATE REVISION CONTROL NUMBER

KEY PLAN

do more feel better live longer

UPPER MERION R&D FACILITIES CAPITAL PROJECTS, ENGINEERING AND DESIGN

709 SWEDELAND ROAD KING-OF-PRUSSIA, PA 19406 (610) 276-5261

SEAL: PETER C. ANDERSEN REGISTERED PROFESSIONAL ENGINEER PE-025264-E

ANDERSEN ENGINEERING ASSOCIATES INCORPORATED 306 NORTH FIFTH STREET, PERKASIE, PA (215) 257-6711

PROJECT REF: T.L.C. 10/27/16 5365SITE P.C.A. FILE REFERENCE: 5365SITE DRAWING STATUS: PROJECT REF: SCALE @ 1/8" = 1'-0"



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LEGACY GSK DRAWING DWG NO. (SEE NOTE ABOVE) SHEET 11 OF 21




GSK DRAWING NO: 00-00-011

FIELD BK/Pg: -/- AEA JOB NO.: 5365 AEA FILE NO.: 5365SITE

- NOTES:**
1. THE DEPTH OF THE INVERT CHANNEL SHALL BE EQUAL TO 3/4 OF THE DIAMETER OF THE SEWER.
 2. THE SHELVE SHALL SLOPE TOWARD THE INVERT CHANNEL AT A RATE OF 1" PER FOOT.
 3. TYPE "B" MANHOLES (SHALLOW TYPE) TO BE PROVIDED WHERE REQUIRED BY DEPTH CONDITIONS. ALL OTHER MANHOLES TO BE TYPE "A".
 4. THE WALL THICKNESS IN A 4'-0" DIA. PRECAST BASE SHALL BE AS FOLLOWS: FOR PIPES 16" AND SMALLER, -5" WALL, FOR PIPES 18" AND LARGER, -8" WALL.
 5. ALL MANHOLE FRAMES FOR "OFF THE ROAD" MANHOLES SHALL BE BOLTED TO THE CONE SECTION OR CONCRETE SLAB WITH TWO 3/4" DIA. BOLTS WITH WASHERS AND NUTS. BOLTS TO BE AT 180° ON A 36" DIA. BOLT CIRCLE.
 6. FOR MANHOLES HAVING A 5'-0" OR 6'-0" DIA BASES REDUCTION IN DIAMETER TO 4'-0" SHALL START AT THE FIRST JOINT ABOVE THE UPPERMOST PIPE CONNECTION, WHERE DEPTH IS SUFFICIENT.
 7. EXTERIOR COATING OF ALL MANHOLES TO HAVE TWO COATS (16 mil DRY THICKNESS) OF KOPPERS SUPER SERVICE BLACK OR APPROVED EQUAL. INTERIOR COATING SHALL BE DOUBLE COATED WITH A WATERPROOF CORROSION RESISTANT COATING SUCH AS SIKAGARD 62 OR APPROVED EQUAL AND ACCORDING TO MANUFACTURER'S INSTRUCTIONS.


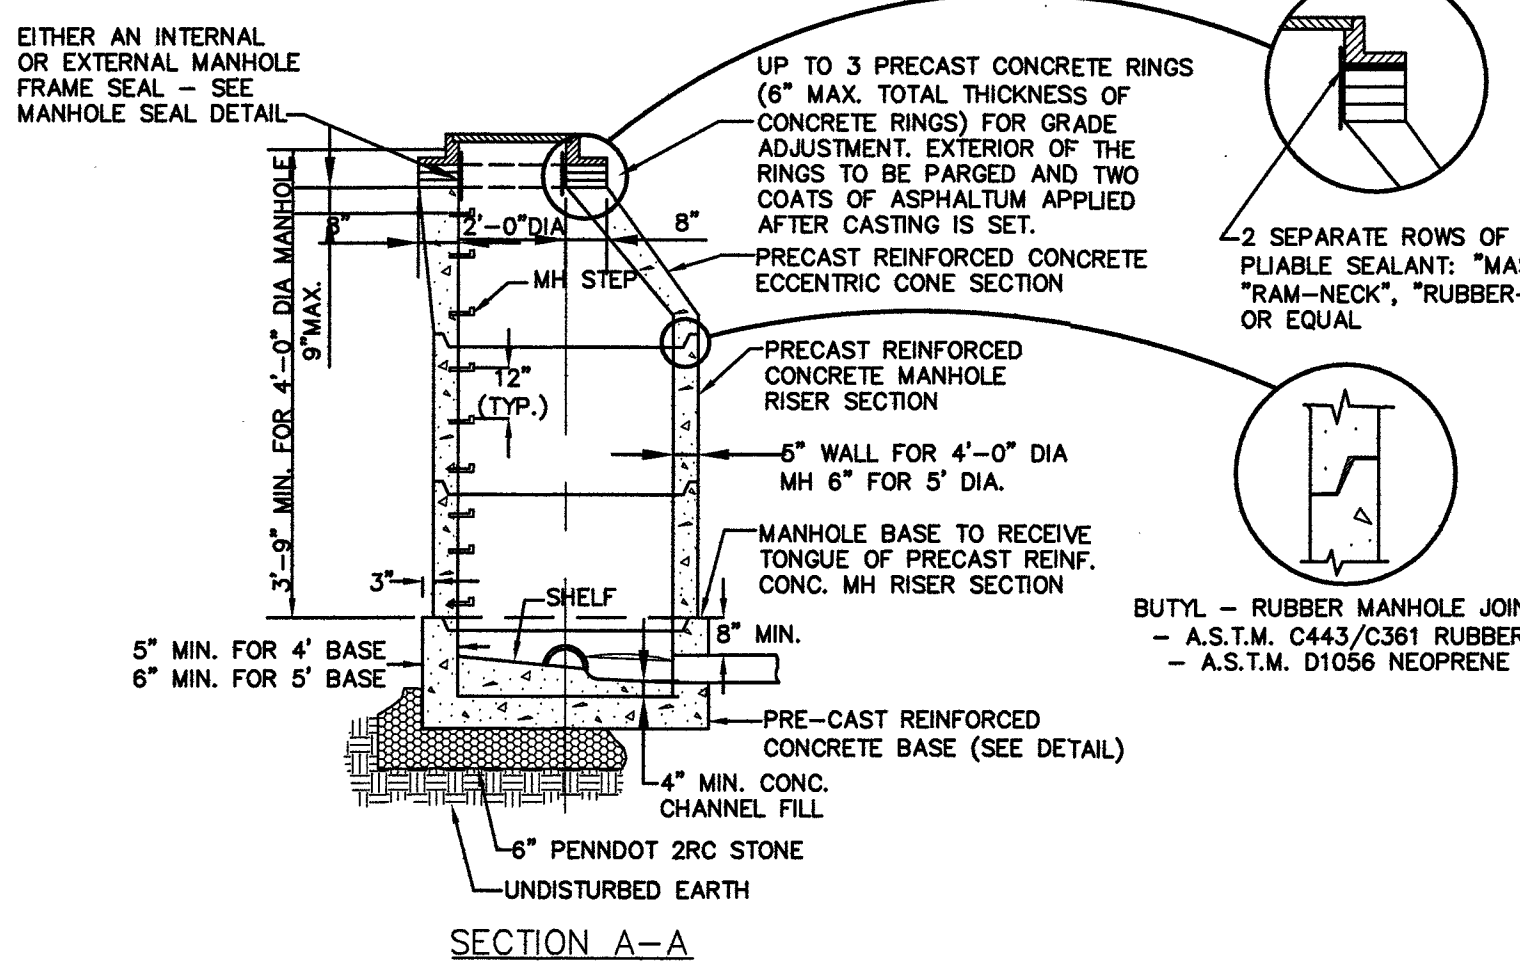
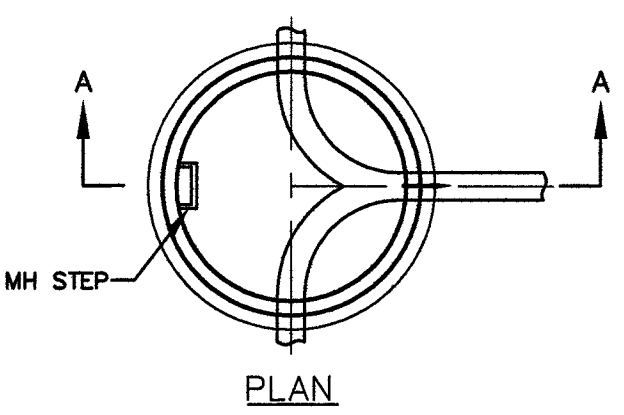


TYPE "A" STANDARD MANHOLE DETAIL
NOT TO SCALE

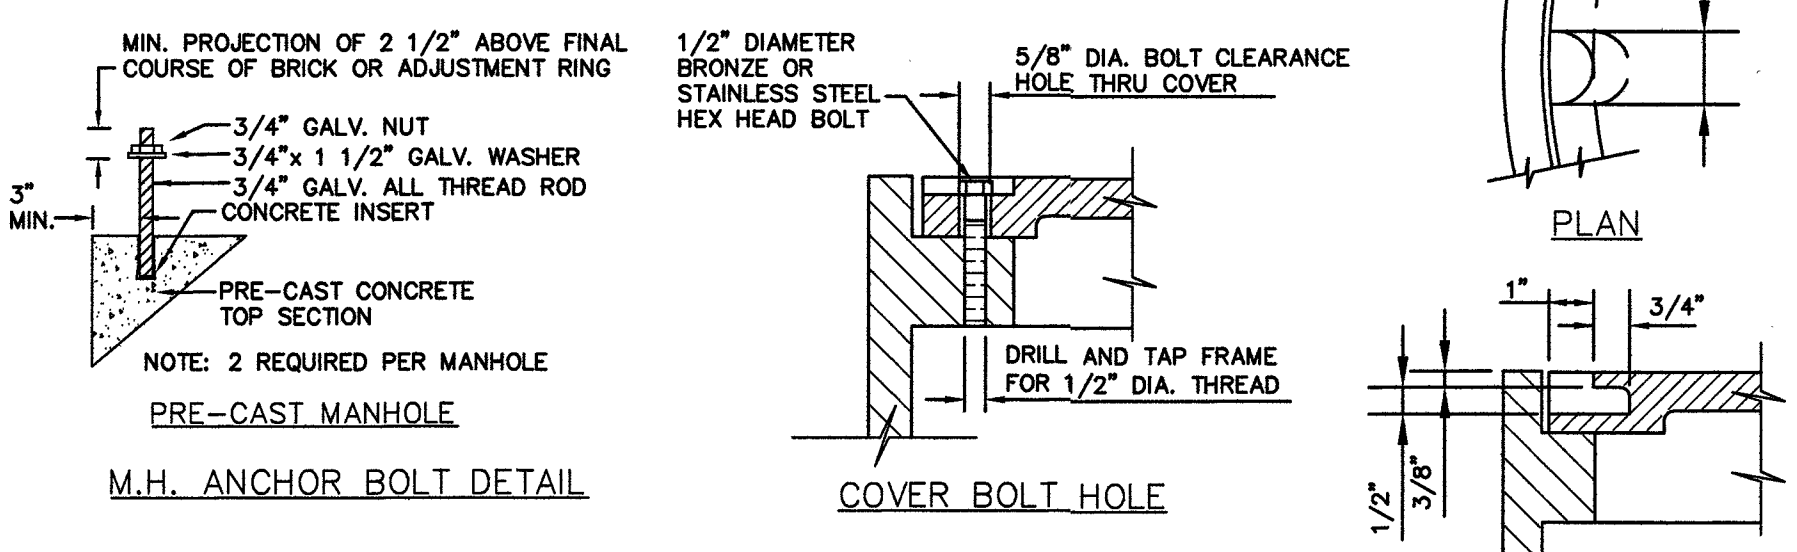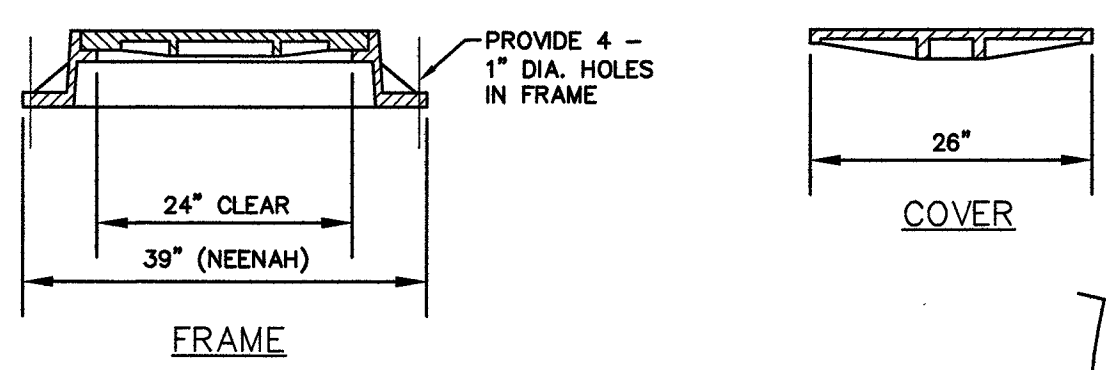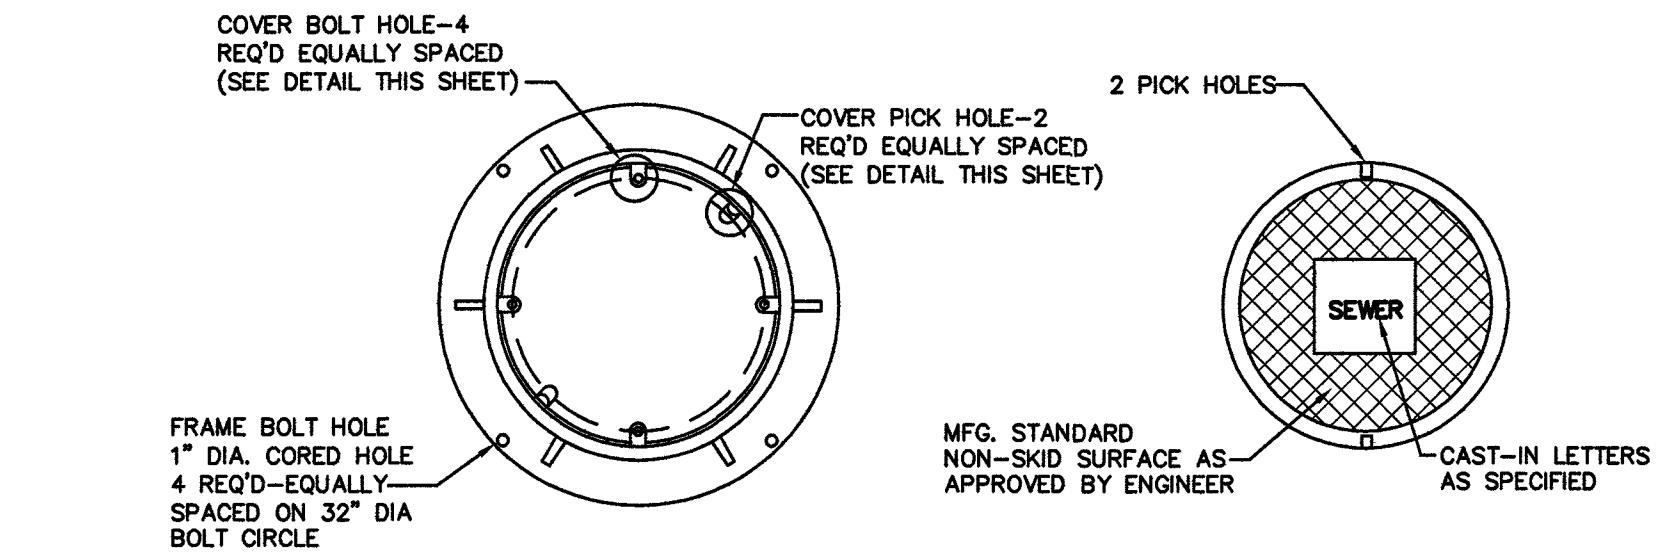


- SPECIFICATIONS:**
- ALL MATERIAL GRAY CAST IRON, A.S.T.M. A-48, CL30 SUITABLE FOR HIGHWAY LOADING
 - ALL FRAMES & COVERS SHALL BE COATED WITH COAL TAR PITCH VARNISH
 - COVER SHALL HAVE THE WORDS "PRA SEWER" CAST THEREON
 - FRAMES SHALL BE WATERPROOF AND COVER SHALL BE BOLTED WITH FOUR (4) 1/2" COUNTERSUNK STAINLESS STEEL BOLTS MAKING A SEAL WITH A RUBBER "O" RING GASKET, OR EQUAL
 - PROVIDE FOUR (4) ANCHOR BOLT HOLES, 1" DIA. MIN.

WATERPROOF MANHOLE FRAME AND COVER
NOT TO SCALE

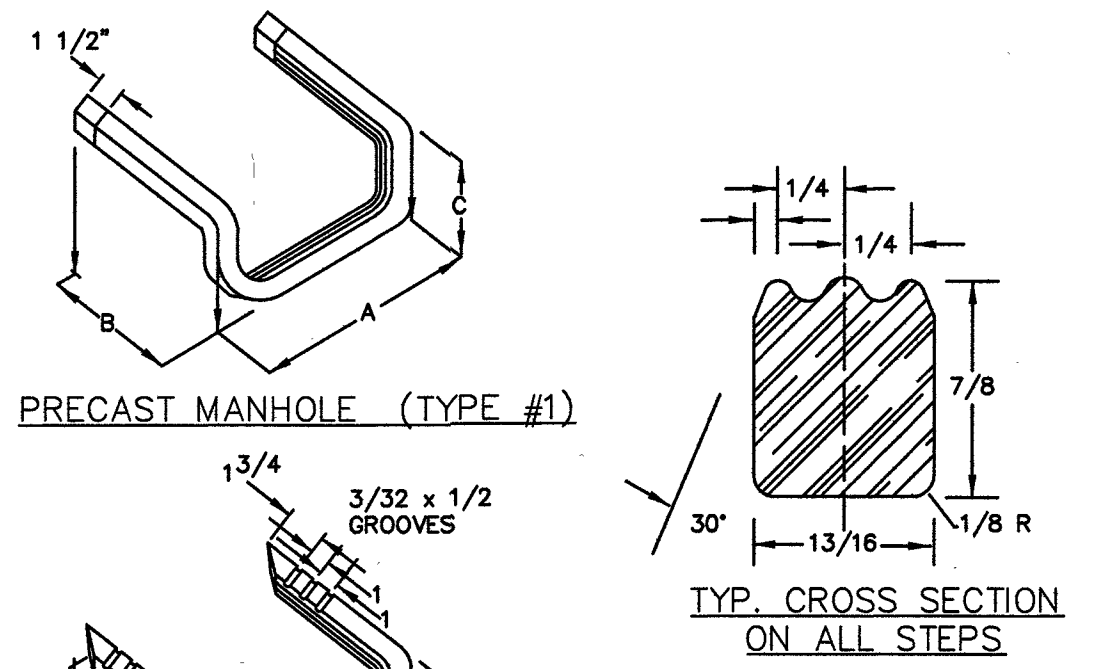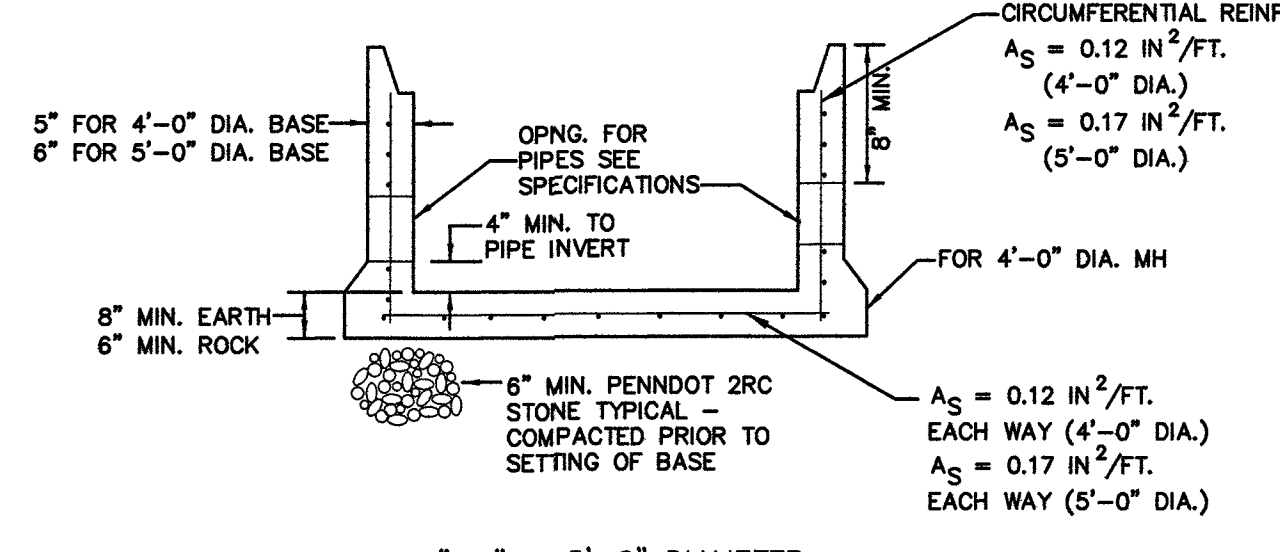
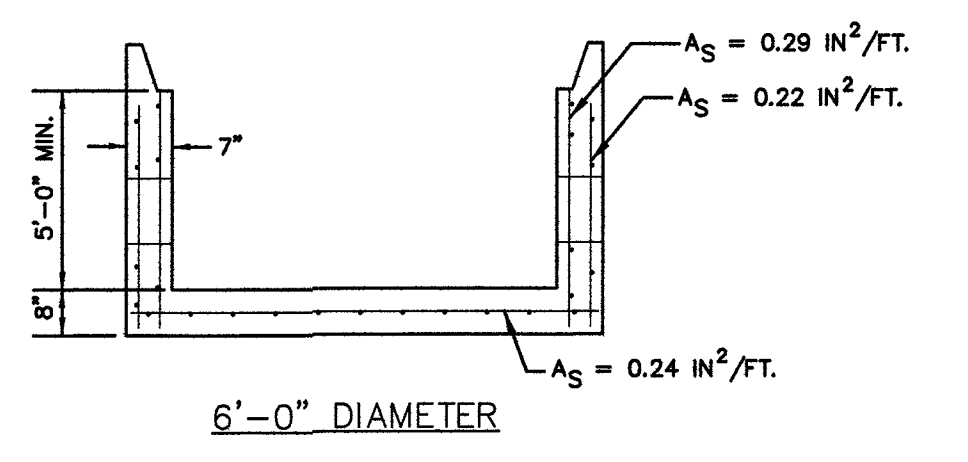


APPLICATION	DIMENSION (IN.)			
	A	B	C	D
PRECAST M.H. (TYPE 1)	13 3/4	10	3 3/4	-
PRECAST M.H. (TYPE 2)	13 3/4	11	3 3/4	-




PRECAST MANHOLE STEPS DETAILS
NOT TO SCALE

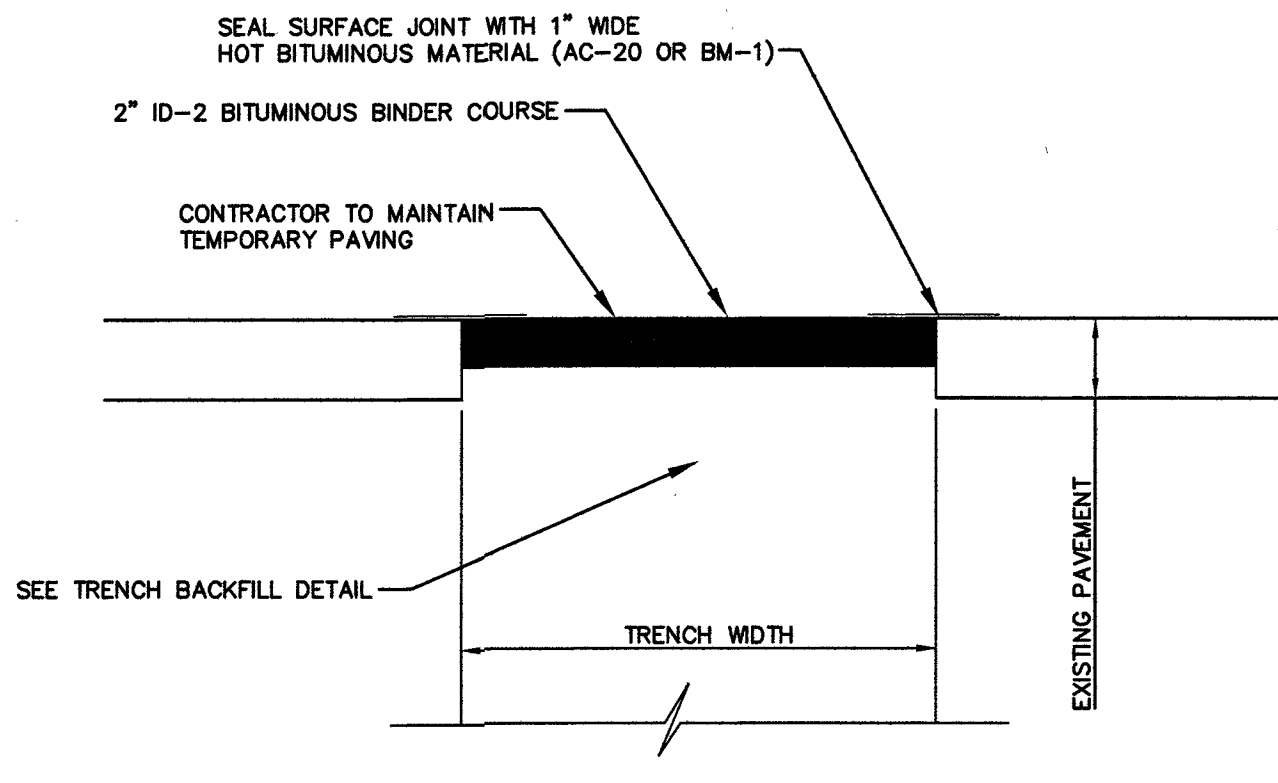

TEMPORARY TRENCH RESTORATION
NO SCALE

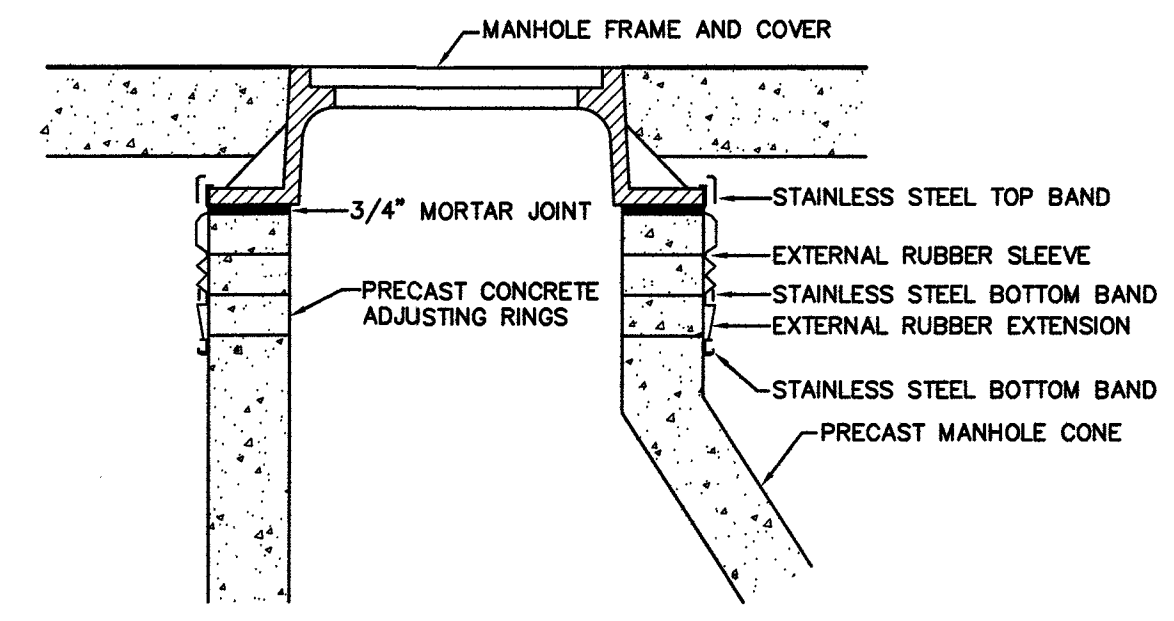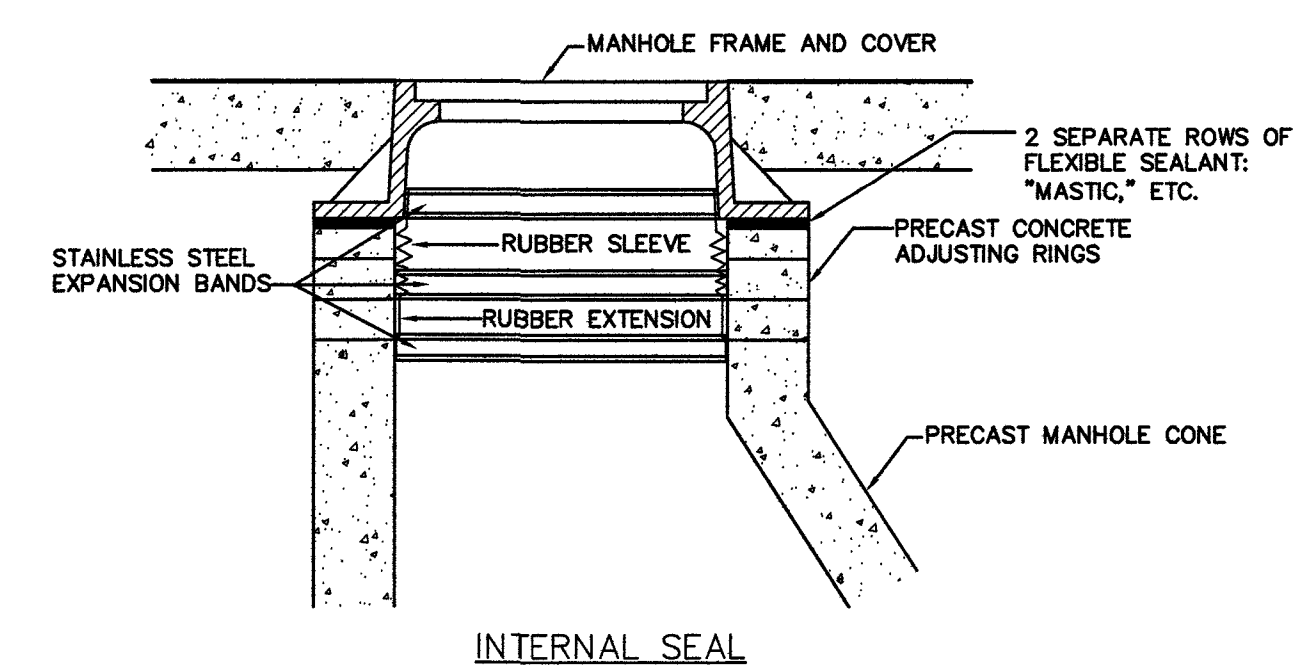


MANUFACTURED CHIMNEY TO FRAME SEAL
NOT TO SCALE

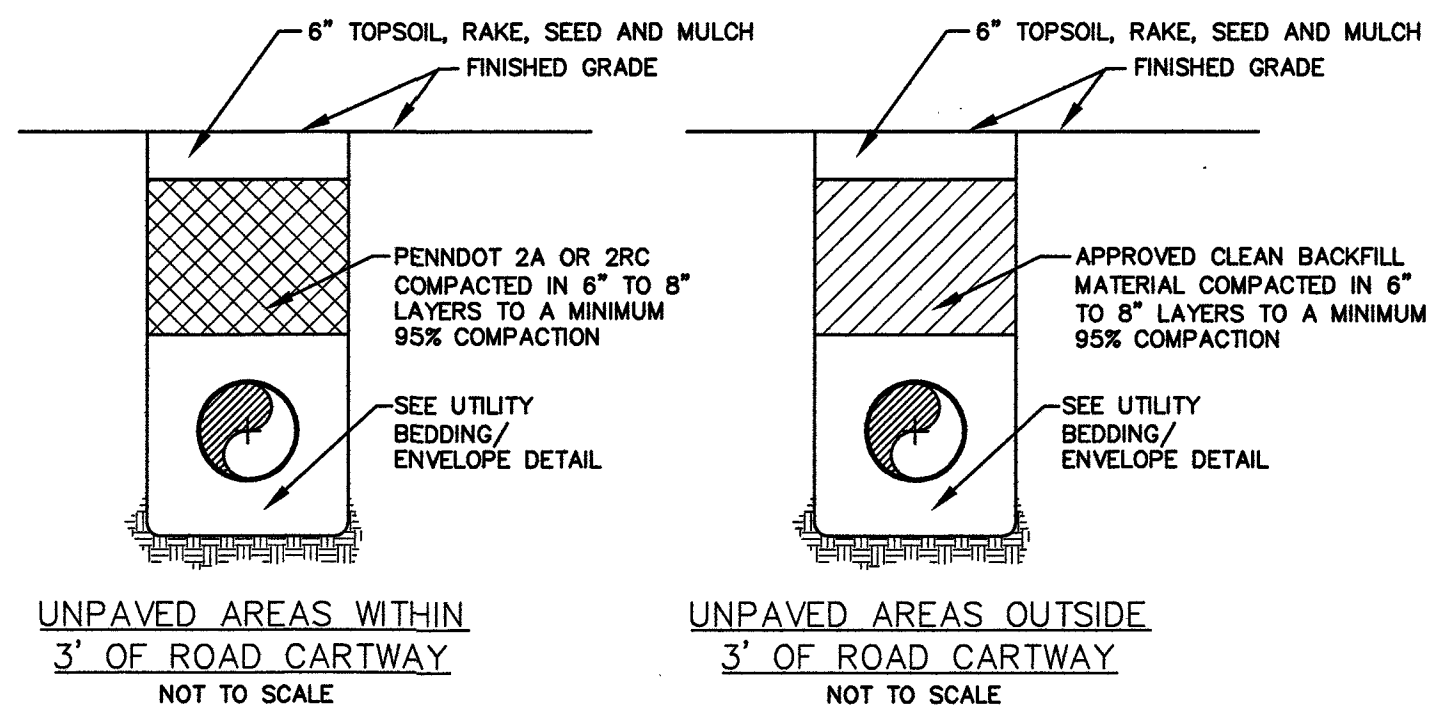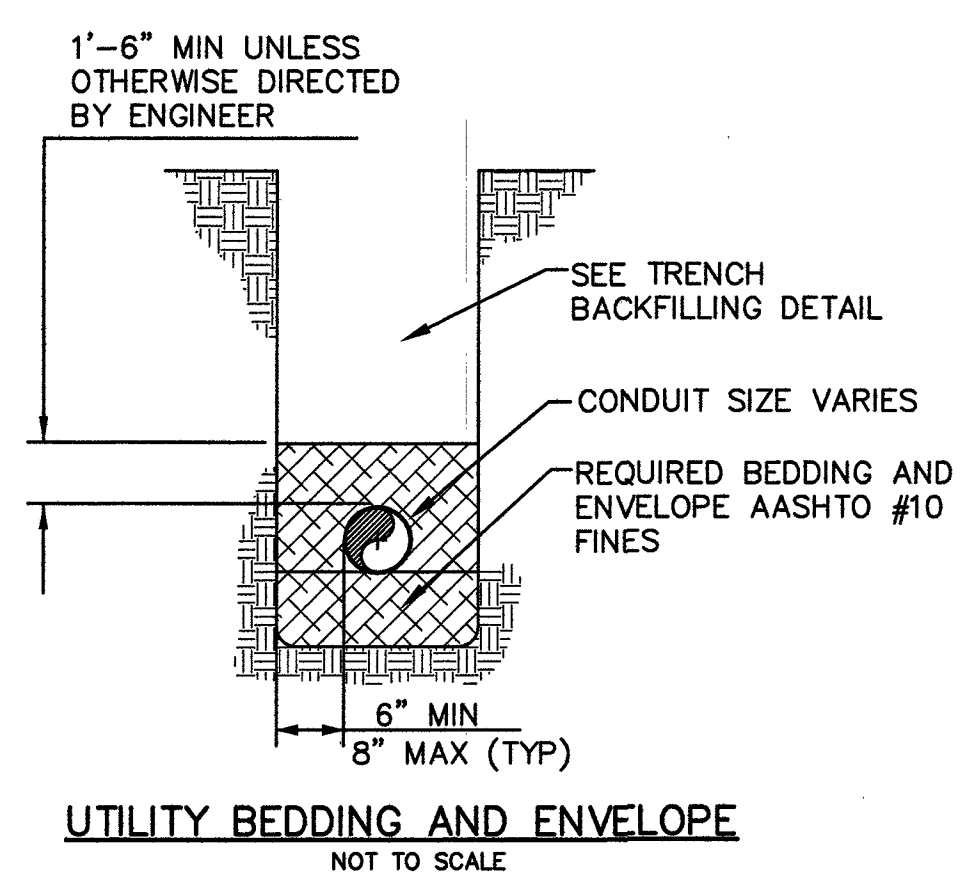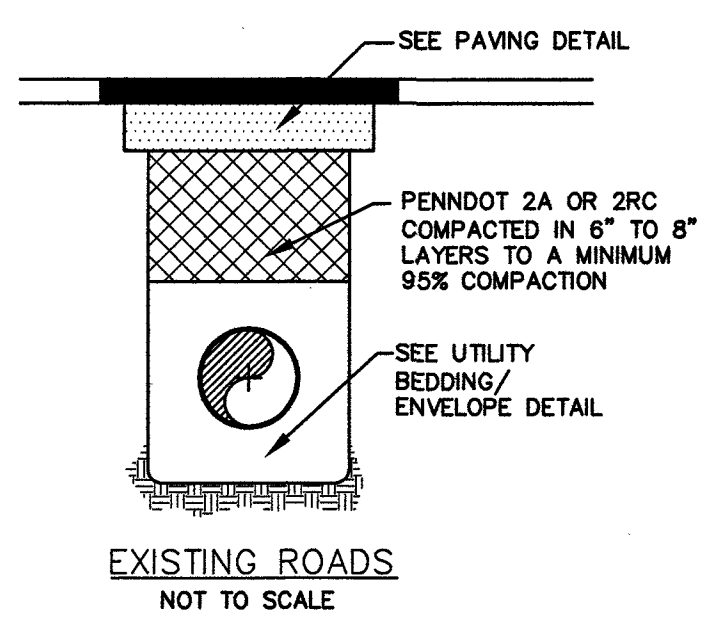

- NOTES:**
1. TRENCH COMPACTION TO BE TESTED, AT THE CONTRACTOR'S EXPENSE, IN ACCORDANCE WITH PENNDOT PUB 408, AS REQUIRED BY THE ENGINEER.
 2. FILL MUST BE APPROVED BY THE ENGINEER PRIOR TO PLACEMENT IN THE TRENCH.
 3. AREAS AROUND MANHOLES AND OTHER APPURTENANCES SHALL BE HAND COMPACTED AS DIRECTED BY THE ENGINEER.
 4. SPECIAL CONDITIONS OF HIGHWAY OCCUPANCY PERMIT MAY SUPERCEDE THIS DETAIL.

UTILITY TRENCH BACKFILL
NOT TO SCALE

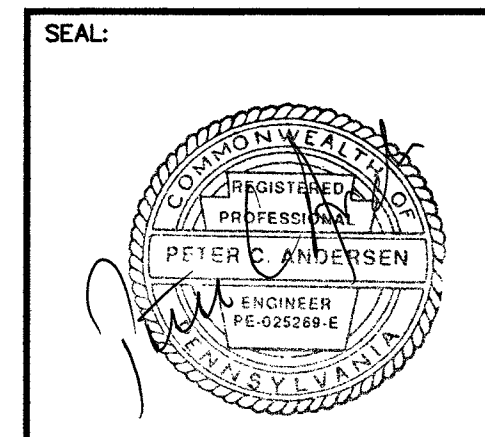

ANDERSEN ENGINEERING ASSOCIATES INCORPORATED

306 NORTH FIFTH STREET, PERKASIE, PA (215) 257-5711

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NOTES REFERENCE DRAWINGS LEGEND

PAGE No. DRAWING No. TITLE

REVISION DATE REVISED CONTROL NUMBER

KEY PLAN

gsk do more feel better live longer

UPPER MERION R&D FACILITIES CAPITAL PROJECTS, ENGINEERING AND DESIGN

709 SWEDELAND ROAD KING-OF-PRUSSIA, PA 19406 (610) 270-5261

PROJECT: UPPER MERION BUILDING: CENTRAL UTILITIES PLANT FLOOR:

DATE: 10/27/16 FILE REFERENCE: 5365SITE

DESIGNED BY: T.L.C. CHECKED BY: P.C.A. DRAWING STATUS: P.C.A.

PROJECT REF: ORIGINAL CONTRACTOR DRAWING NO.(SEE NOTE ABOVE) NOT TO SCALE LEGACY GSK DRAWING DWG NO.(SEE NOTE ABOVE) SHEET NO. 15 OF 21

SCALE @ E1

FIELD BK/PG: AEA JOB NO.: 5365 AEA FILE NO.: 5365SITE

GSK DRAWING NO.: 00-00-015

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KEY PLAN

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UPPER MERION R&D FACILITIES
CAPITAL PROJECTS, ENGINEERING AND DESIGN
709 SWEDENLAND ROAD
KING-OF-PRUSSIA, PA 19406
(610) 270-5281

PROJECT REF: UPPER MERION
BUILDING: CENTRAL UTILITIES PLANT
FLOOR:
Note: Previous Drawing Reference can be used for old drawing numbers or any previous reference that needs to be retained.

TITLE: PROPOSED CENTRAL UTILITIES PLANT (CUP) BUILDING
SHEET TITLE: RAINGARDEN POST CONSTRUCTION STORMWATER MANAGEMENT PLAN




DATE: 10/27/16
FILE REFERENCE: 5365SITE
DRAWING STATUS: P.C.A.

SCALE @ E1
1" = 40'

ORIGINAL CONTRACTOR DRAWING NO.(SEE NOTE ABOVE)
LEGACY GSK DRAWING DWG NO.(SEE NOTE ABOVE)
SHEET NO. 18 OF 21

FIELD BK/PG: 5365 SITE
AEA JOB NO.: 5365 SITE
AEA FILE NO.: 5365 SITE
GSK DRAWING NO.: 00-00-018

- LEGEND:**
- 3/10 --- EXISTING CONTOURS
 - EXISTING WOODS
 - EXISTING BRUSH
 - EXISTING RIGHT-OF-WAY LINE
 - EXISTING FENCE
 - X --- PROPOSED FENCE
 - EXISTING EDGE OF PAVEMENT
 - EXISTING LIGHT
 - EXISTING UNDERGROUND COMMUNICATIONS
 - EXISTING UNDERGROUND ELECTRIC
 - EXISTING UNDERGROUND GAS LINE
 - EXISTING WATER LINE
 - PROPOSED CONTOUR
 - EXISTING CURB
 - PROPOSED CURB
 - PROPOSED FLUSH CURB
 - EXISTING PAINT STRIPING
 - PROPOSED PAINT STRIPING
 - S --- EXISTING SANITARY SEWER, MANHOLE AND INLET
 - M.H. --- EXISTING STORM SEWER, MANHOLE AND INLET
 - M.H. --- PROPOSED STORM SEWER, MANHOLE AND INLET
 - EXISTING SIDEWALK
 - PROPOSED SIDEWALK
 - 12" SS --- COMPOST SILT SOCK WITH SIZE
 - WATERSHED/STORMWATER MANAGEMENT LINE
 - LIMIT OF DISTURBANCE
 - NPDES BOUNDARY LINE
 - SOILS BOUNDARY LINE
 - EXISTING PAVEMENT TO BE REPLACED
 - PROPOSED PAVEMENT
 - EXISTING PAVEMENT CONVERTED TO LANDSCAPING

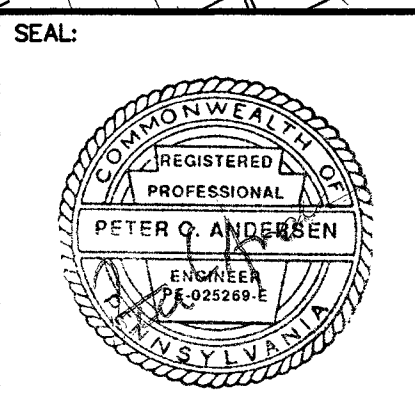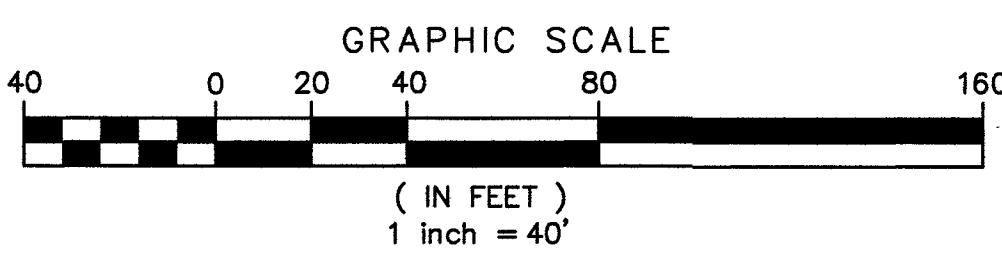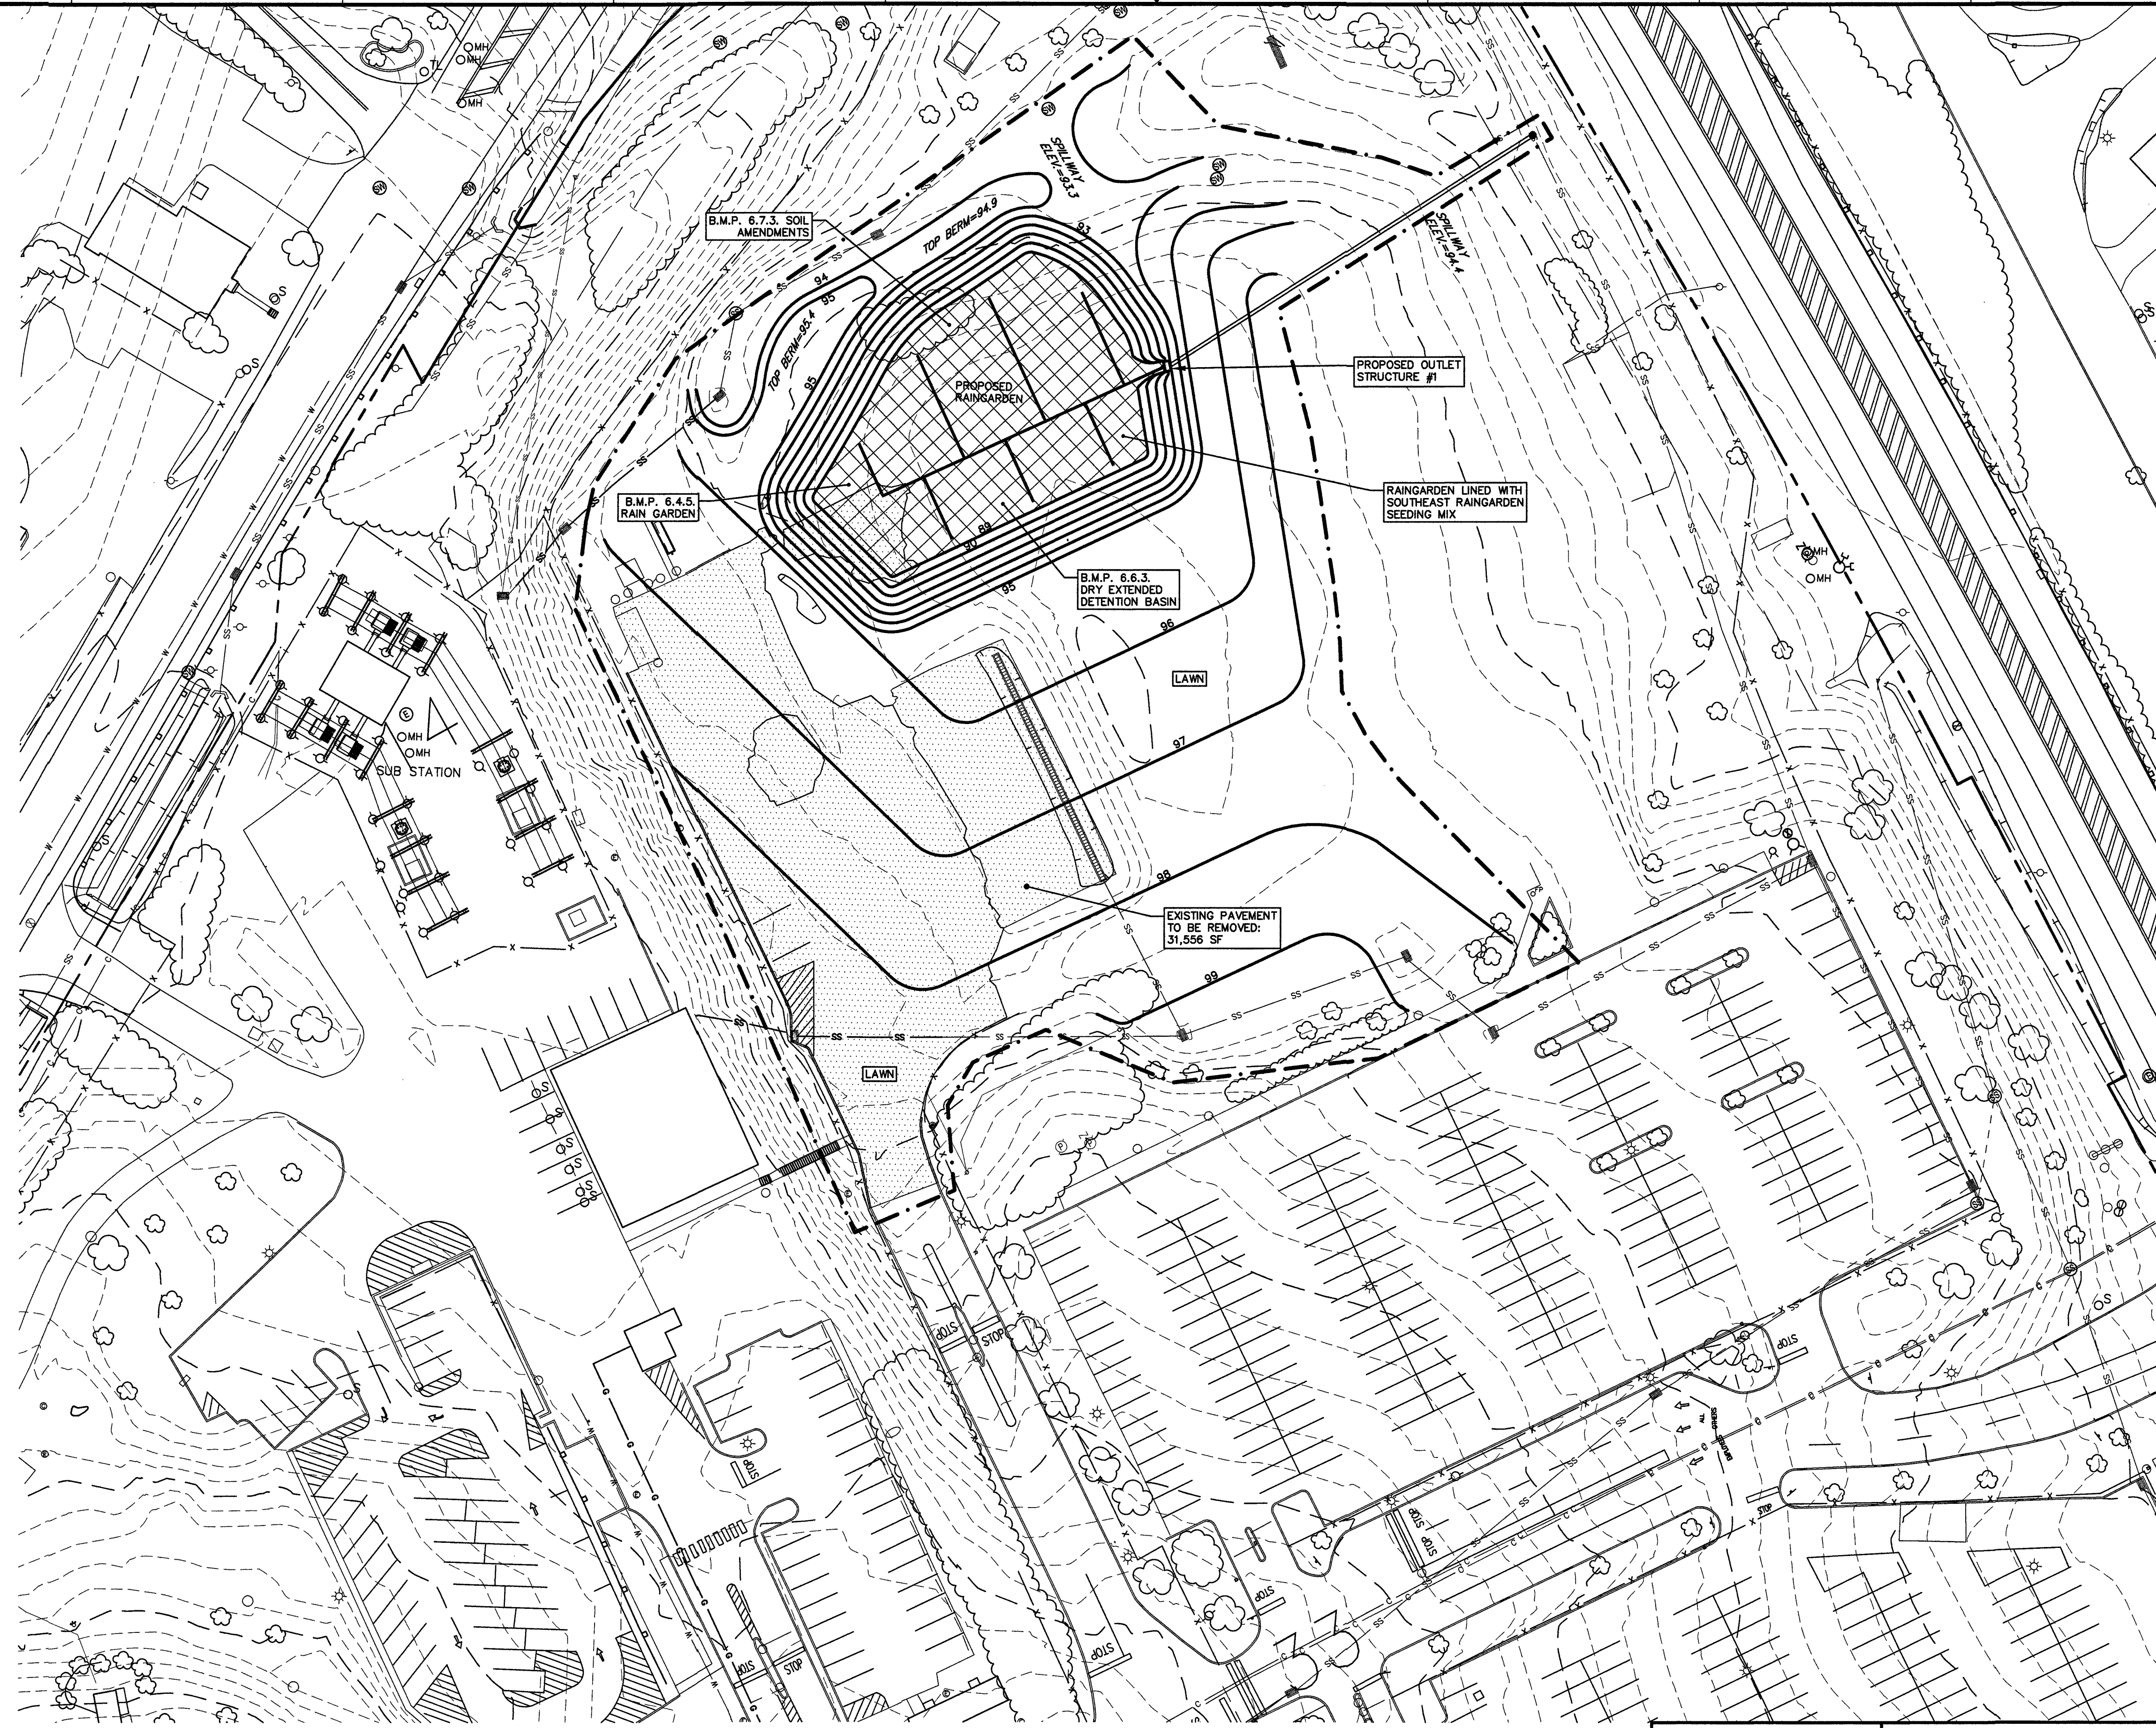

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FIELD BK/PG: 5365 SITE
AEA JOB NO.: 5365 SITE
AEA FILE NO.: 5365 SITE

GSK DRAWING NO.: 00-00-018

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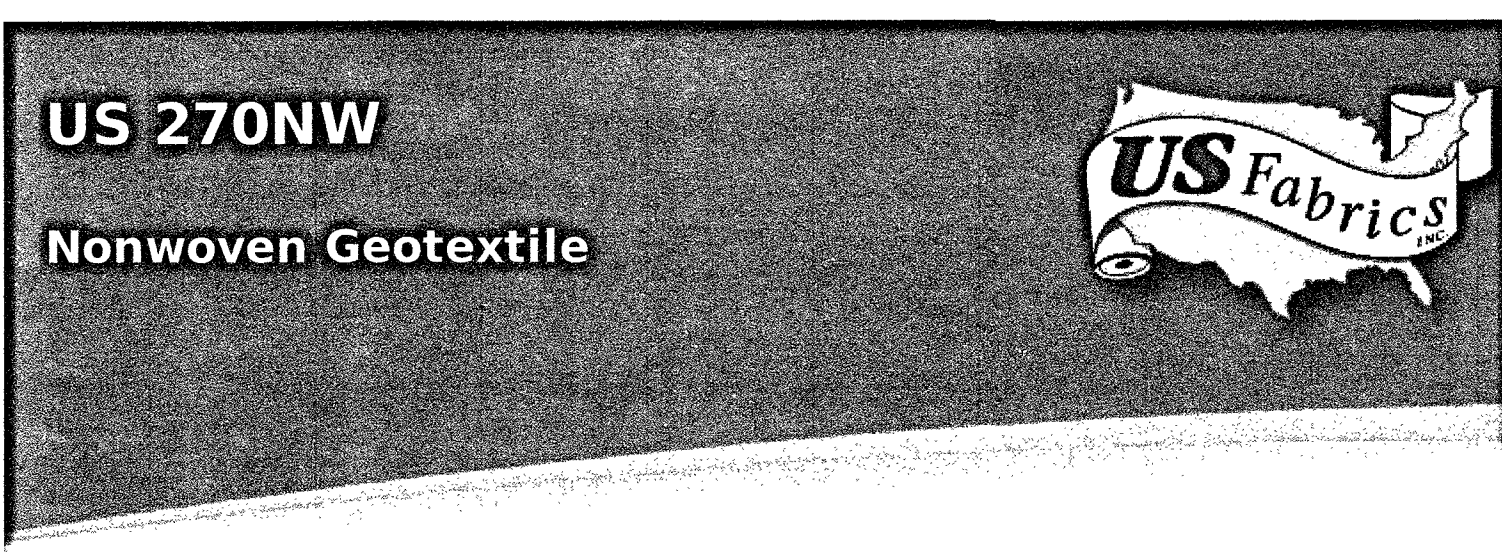
F&S CONSTRUCTION SEQUENCE

NOTE: ALL EARTH DISTURBANCE ACTIVITIES SHALL PROCEED IN ACCORDANCE WITH THE FOLLOWING SEQUENCE. EACH STAGE SHALL BE COMPLETED BEFORE ANY FOLLOWING STAGE IS INITIATED. CLEARING AND GRUBBING SHALL BE LIMITED ONLY THOSE AREAS DESCRIBED IN EACH STAGE. A PROFESSIONAL OR DESIGNEE WILL BE PRESENT ON SITE DURING INSTALLATION OF STORMWATER BMPs THAT ARE LISTED AS CRITICAL STAGES.

- 1. DELINEATE THE LIMIT OF DISTURBANCE WITH CONSTRUCTION FENCE. (TOTAL 1 DAY)
2. INSTALL EROSION AND SEDIMENT CONTROL BMPs IN THE FOLLOWING ORDER:
1. CONSTRUCTION ENTRANCE
2. COMPOST FILTER SOCK (TOTAL 2 DAYS)
3. CONSTRUCT SEDIMENTATION TRAP. (4 DAYS) - CRITICAL STAGE
4. DEMOLISH EXISTING STRUCTURES AS NECESSARY.
5. CLEAR AND GRUB AREA TO BE GRADED FOR PROPOSED IMPROVEMENTS (2 DAYS).
6. ROUGH GRADE AREA FOR PROPOSED IMPROVEMENTS.
7. TEMPORARILY STABILIZE DISTURBED AREA.
8. INSTALL STORM SEWER, SANITARY SEWER (10 DAYS) - CRITICAL STAGE
9. CONSTRUCT PROPOSED PARKING AND BUILDING. STABILIZE DISTURBED AREAS OF EACH AS THEY ARE COMPLETED (180 DAYS)
10. CONVERT SEDIMENTATION TRAP TO RAIN GARDEN/DETENTION BASIN (5 DAYS)
11. INSTALL OUTLET STRUCTURE, UNDER DRAIN AND OUTLET PIPE. (5 DAYS)
12. FINE GRADE. (2 DAYS)
13. PERMANENTLY STABILIZE DISTURBED AREAS. (2 DAYS)
14. ONCE PERMANENT STABILIZATION HAS BEEN ACHIEVED, REMOVE ALL EROSION AND SEDIMENT CONTROL BMP'S AND RE-STABILIZE AFFECTED AREAS.

CRITICAL STAGE TO BE INSPECTED:

- 1. CONSTRUCT INFILTRATION BASIN/DETENTION BASIN WITH OUTLET PIPE, OUTLET STRUCTURE, RIP RAP APRON.
2. INSTALL ALL REMAINING STORM SEWER INCLUDING.
3. PREPARATION AND INSTALLATION OF THE PERVIOUS PAVING AND SUBBASE, EXCAVATE POROUS PAVEMENT AREA AS SHOWN ON THE PLANS. PLACE NON-WOVEN GEOTEXTILE, STONE INFILTRATION BED, 8" PAVEMENT UNDER DRAINS AND CURB TRENCH DRAINS.
4. COMPLETE INFILTRATION BASIN/DETENTION BASIN GRADING, FERTILIZE SEED AND MULCH.
5. REPLACE TOPSOIL AND SOIL AMENDMENTS WITHIN INFILTRATION BASIN/DETENTION BASIN.



NTEP APPROVED - GTX-2013-01-031. US 270NW is a 10 OZ MARV WEIGHT nonwoven needlepunched geotextile made of 100% polypropylene staple filaments. US 270NW is resistant to ultraviolet deterioration, rotting, biological degradation, naturally encountered bases and acids. Polypropylene is stable within a pH range of 2 to 13. US 270NW meets the following M.A.R.V. values:

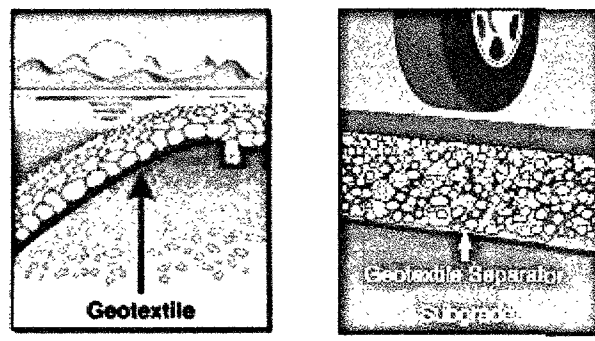


Table with 4 columns: PROPERTY, TEST METHOD, ENGLISH, METRIC. Lists properties like Weight, Tensile Strength, Elongation, Thickness, Mullen Burst*, Puncture Strength*, CBR Puncture, Trapezoidal Tear, Apparent Opening Size, Permittivity, Permeability, Water Flow Rate, UV Resistance @ 500 Hours.

Table with 4 columns: ROLL SIZE, ROLL DIAMETER, AREA, WEIGHT. Shows 15' x 300', 18.0 in, 500 sqy, 350 lbs.

* Historical averages (current values not available): Mullen Burst Strength ASTM D3786 is no longer recognized by ASTM D-35 on Geosynthetics as an acceptable test method. Puncture Strength ASTM D4833 is not recognized by ASTM D3088 and has been replaced with CBR Puncture ASTM D6241.

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E&S BMP's INSPECTION, REPORTING, AND MONITORING:

- A. EXCEPT FOR DATA DETERMINED TO BE CONFIDENTIAL UNDER SECTION 607 OF THE CLEAN STREAMS LAW (35 P.S. §691.607), ALL REPORTS PREPARED IN ACCORDANCE WITH THE TERMS OF THIS PERMIT SHALL BE AVAILABLE FOR PUBLIC INSPECTION AT THE OFFICES OF THE DEPARTMENT OR AUTHORIZED CONSERVATION DISTRICT...
B. THE PERMITTEE AND CO-PERMITTEE(S) SHALL RETAIN RECORDS OF ALL MONITORING INFORMATION INCLUDING COPIES OF ALL MONITORING AND INSPECTION REPORTS...
C. THE PERMITTEE AND CO-PERMITTEE(S) MUST ENSURE THAT VISUAL SITE INSPECTIONS ARE CONDUCTED WEEKLY...
D. WHERE E&S OR PCSM BMPs ARE FOUND TO BE INOPERATIVE OR INEFFECTIVE DURING AN INSPECTION...

RESPONSIBILITIES FOR FILL MATERIAL

THE CONTRACTOR SHALL BE RESPONSIBLE TO PERFORM ENVIRONMENTAL DUE DILIGENCE AND DETERMINE THAT ALL FILL IMPORTED TO THE SITE MEETS THE DEP DEFINITION OF CLEAN FILL... THE RESPONSIBILITIES OF DUE DILIGENCE INVOLVES INVESTIGATIVE TECHNIQUES, INCLUDING, BUT NOT LIMITED TO, VISUAL PROPERTY INSPECTIONS, ELECTRONIC DATA BASE SEARCHES, REVIEW OF OWNERSHIP AND USE HISTORY OF PROPERTY, SANBORN MAPS, ENVIRONMENTAL QUESTIONNAIRES, TRANSACTION SCREENS, ANALYTICAL TESTING, ENVIRONMENTAL ASSESSMENTS OR AUDITS.

RECEIVING WATERS CLASSIFICATION

THE RECEIVING WATERS FOR ALL DRAINAGE AREAS OF THE PROPOSED PROJECT ARE TO A TRIBUTARY TO THE DOE RUN. THE PA DEP CHAPTER 93 CLASSIFICATION IS T5F.

NOTIFICATION REGARDING MAINTENANCE OF PUBLIC STREETS DURING CONSTRUCTION ACTIVITY

MUD SEDIMENT AND/OR DEBRIS TRACKED FROM THE SITE ONTO PUBLIC CARTWAY SHALL BE IMMEDIATELY REMOVED BY BROOMING AND/OR MECHANICAL MEANS TO THE SATISFACTION OF THE TOWNSHIP... WHERE MUD AND/OR SEDIMENT IS CAUSING SLICK AND/OR HAZARDOUS CONDITIONS, ROADWAY SURFACE SHALL BE IMMEDIATELY PRESSURE WASHED TO REMOVE CONTAMINATION...

SEEDING SPECIFICATIONS:

TEMPORARY SEEDING AND MULCHING SPECIFICATIONS

- A) LIME: PULVERIZED AGRICULTURAL LIMESTONE. APPLICATION RATE: 80 LBS. PER 1000 S.F. (DETERMINE ACTUAL NEED FOR LIME WITH SOIL TEST)
B) FERTILIZER: 10-20-20 ANALYSIS COMMERCIAL FERTILIZER APPLICATION RATE: 192 LBS. PER 1000 S.F.
C) SEED: ANNUAL RYE GRASS APPLICATION RATE: 3 LBS. PER 1000 S.F.
D) MULCH: STRAW OR UNROTTED SALT HAY TO BE APPLIED AFTER SEEDING APPLICATION RATE: 3 TONS PER ACRE OR 138 LBS. PER 1000 S.F.

PERMANENT SEEDING AND MULCHING SPECIFICATIONS

- A) LIME: PULVERIZED AGRICULTURAL LIMESTONE. APPLICATION RATE: 50 LBS. PER 1000 S.F. (DETERMINE ACTUAL NEED FOR LIME WITH SOIL TEST)
B) FERTILIZER: 10-6-4 ANALYSIS COMMERCIAL FERTILIZER APPLICATION RATE: 35 LBS. PER 1000 S.F.
C) SEED: 60% KENTUCKY BLUEGRASS 30% CREEPING RED FESCUE 10% FINE LEAF RYE APPLICATION RATE: 6 LBS. PER 1000 S.F.
D) MULCH: STRAW OR UNROTTED SALT HAY TO BE APPLIED AFTER SEEDING APPLICATION RATE: 3 TONS PER ACRE OR 138 LBS. PER 1000 S.F.

NPDES GENERAL SITE NOTES

- 1. THIS PROJECT WAS DESIGNED TO MINIMIZE EXTENT AND DURATION OF EARTH DISTURBANCE, BY STABILIZING ANY DISTURBED AREAS AS SOON AS POSSIBLE.
2. THIS PROJECT WAS DESIGNED TO PROTECT EXISTING DRAINAGE FEATURES AND EXISTING VEGETATION BY LIMITING LAND CLEARING AND GRADING.
3. THIS PROJECT WAS DESIGNED TO MINIMIZE SOIL COMPACTION, BY LIMITING THE USE OF EQUIPMENT IN AREAS OF DISTURBANCE AND AREAS THAT ARE OUTSIDE OF THE DISTURBED AREA.
4. THIS PROJECT UTILIZES SOIL AMENDMENTS, INFILTRATION, LANDSCAPING, INFILTRATION BASIN AND DETENTION FACILITIES TO MINIMIZE CHANGES IN STORMWATER RUNOFF.
5. THERE ARE NO KNOWN GEOLOGIC OR SOIL CONDITIONS THAT MAY HAVE THE POTENTIAL TO CAUSE POLLUTION.
6. IT IS NOT ANTICIPATED THAT ANY MATERIAL THAT COULD CAUSE POLLUTION WILL BE ENCOUNTERED.
7. THERE AREN'T ANY EXISTING OR PROPOSED RIPARIAN BUFFERS OR PROPOSED INFILTRATION BMP'S LOCATED OUTSIDE OF THE LIMITS OF DISTURBANCE OR OUTSIDE OF THE PROPOSED GRADING AREAS.
8. THERE AREN'T ANY RIPARIAN FOREST BUFFERS INSIDE OR OUTSIDE OF THE LIMIT OF DISTURBANCE.
9. THERE AREN'T ANY RIPARIAN BUFFERS OFFSET.
10. NO RIPARIAN BUFFER IS PROPOSED AS PART OF THIS PROJECT.
11. NO NON-DISCHARGE AND/OR ABACT BMP'S PROPOSED.
12. THIS PLAN PRESERVES THE INTEGRITY OF STREAM CHANNELS AND MAINTAINS AND PROTECTS THE PHYSICAL, BIOLOGICAL AND CHEMICAL QUALITIES OF THE RECEIVING STREAM, BY MAINTAINING THE WATER QUALITY FROM THE AREAS OF CONSTRUCTION.
13. THIS PROJECT WAS DESIGNED TO MINIMIZE GENERATION OF INCREASED STORMWATER RUNOFF, BY LIMITING THE AMOUNT OF IMPERVIOUS SURFACE.
14. THIS PROJECT WAS DESIGNED TO MINIMIZE NEW IMPERVIOUS AREAS, BY LIMITING THE NUMBER OF PARKING SPACES TO BE MINIMUM REQUIRED BY THE BOROUGH ZONING ORDINANCE. FURTHERMORE, SOME OF THE PARKING WILL NOT BE INSTALLED UNTIL IT IS REQUIRED.
15. THIS PROJECT WAS DESIGNED TO PROTECT EXISTING DRAINAGE FEATURES BY RESTRICTING THE AMOUNT OF DISTURBANCE.
16. THIS PROJECT IS NOT IN A HQ OR EV WATERSHED.
17. NO WETLANDS WILL BE DISTURBED. THERE ARE NO WETLANDS ON THIS SITE.
18. NO PROPRIETARY BMP SYSTEMS ARE PROPOSED.
19. ALL SEDIMENT REMOVED FROM BMPs SHALL BE DISPOSED OF IN THE MANNER DESCRIBED ON THE PLANS. SEDIMENT REMOVED FROM BMPs SHALL BE DISPOSED OF IN LANDSCAPED AREAS OUTSIDE OF STEEP SLOPES, WETLANDS, FLOODPLAINS, OR DRAINAGE SWALES AND IMMEDIATELY STABILIZED, OR PLACED IN TOPSOIL STOCKPILES

RESPONSES TO SOIL LIMITATIONS:

- *USE SUFFICIENT AND PROPER BEST MANAGEMENT PRACTICES TO MINIMIZE EROSION.
*DO NOT PERFORM TRENCHING, BACKFILLING OR COMPACTING WHEN WEATHER CONDITIONS OR THE CONDITION OF MATERIAL IS SUCH, IN THE OPINION OF THE ENGINEER, THAT WORK CANNOT BE PERFORMED SATISFACTORILY.
*DO NOT USE BACKFILL MATERIALS CONTAINING MOISTURE IN EXCESS OF THE AMOUNT NECESSARY FOR COMPACTION.
*PLAN WORK SO AS TO PROVIDE ADEQUATE PROTECTION DURING STORMS WITH PROVISIONS AVAILABLE FOR PREVENTING FLOOD DAMAGE.
*KEEP EXCAVATIONS FREE FROM WATER DURING THE PERFORMANCE OF WORK. PROVIDE AND OPERATE PUMPS WITH SUFFICIENT CAPACITY FOR DEWATERING THE EXCAVATIONS. PONDED WATER TO BE PUMPED THROUGH A FILTER BAG.
*USE SEED SUITED FOR SITE CONDITIONS; PROVIDE SUFFICIENT TOPSOIL PREPARATION AND MULCHING.
*WORK DURING WARM WEATHER MONTHS TO ACHIEVE THESE ENDS.

Table with 7 columns: SOIL SYMBOL, SOIL NAME, SLOPE (%), DEPTH TO BEDROCK, DEPTH TO SEASONAL HIGH WATER TABLE, DRAINAGE CLASS RATING, LAND CAPABILITY, HYDROLOGIC SOIL GROUP, HYDRIC SOIL. Shows Ugd URBAN LAND with slope 8 to 25, depth to bedrock -, drainage class -, land capability 8s, hydrologic soil group C, hydric soil NONHYDRIC.

SOURCE: UNITED STATES DEPARTMENT OF AGRICULTURE, NATURAL RESOURCES CONSERVATION SERVICE "WEB SOIL SURVEY"

SEEDING NOTES:

- 1. ANY DISTURBED AREA ON WHICH ACTIVITY HAS CEASED AND WHICH WILL REMAIN EXPOSED MUST BE SEEDED AND MULCHED IMMEDIATELY. DURING NON-GERMINATING PERIODS, MULCH MUST BE APPLIED AT THE RECOMMENDED RATES. DISTURBED AREAS WHICH ARE NOT AT FINISHED GRADE AND WHICH WILL BE REDISTURBED WITHIN 1 YEAR MAY BE SEEDED AND MULCHED WITH A QUICK GROWING TEMPORARY SEEDING MIXTURE AND MULCH. DISTURBED AREAS WHICH ARE EITHER AT FINISHED GRADE OF WILL NOT BE REDISTURBED WITHIN 1 YEAR MUST BE SEEDED AND MULCHED WITH A PERMANENT SEED MIXTURE AND MULCH.
2. SWALES, DETENTION BASINS, SEDIMENT TRAPS, STOCKPILES AND OTHER STRUCTURAL EROSION CONTROL DEVICES MUST BE SEEDED AND MULCHED IMMEDIATELY.

SOUTHEAST RAIN GARDEN MIX ERNMX # ERNMX-180-2 SEEDING RATE 20 LB PER ACRE MIX TYPE Storm Water Management Facility Sites

- 21% Beaked Panicgrass, SC Ecotype (Panicum anceps, SC Ecotype)
18% Little Bluestem, "Camper" (Schizachyrium scoparium, "Camper")
16% Virginia Wildrye, GA Ecotype (Elymus virginicus, GA Ecotype)
15% River Oats, Coastal Plain NC Ecotype (Chasmanthium latifolium (Uniola latifolia), Coastal Plain NC Ecotype)
4% Purple Coneflower (Echinacea purpurea)
4% Partridge Pea, FL Ecotype (Chamaecrista fasciculata (Cassia f.), FL Ecotype)
3% Blackeye Susan, Coastal Plain NC Ecotype (Rudbeckia hirta, Coastal Plain NC Ecotype)
2% Greenwhite Sedge, Coastal Plain NC Ecotype (Carex abalutescens (C. longii), Coastal Plain NC Ecotype)
2% Mistflower, FL Ecotype (Eupatorium coelestinum (Conoclinium c.), FL Ecotype)
2% Slender Woodoats, NC Ecotype (Chasmanthium laxum (Uniola laxa), NC Ecotype)
1.5% Lanceleaf Coreopsis, Coastal Plain NC Ecotype (Coreopsis lanceolata, Coastal Plain NC Ecotype)
1.5% Largeflower Tickseed, Piedmont GA Ecotype (Coreopsis grandiflora, Piedmont GA Ecotype)
1% Tall Ironweed, SC Ecotype (Vernonia angustifolia, SC Ecotype)
1% Showy Aster, NC Ecotype (Aster spectabilis, NC Ecotype)
1% Spotted Beebalm, Coastal Plain SC Ecotype (Monarda punctata, Coastal Plain SC Ecotype)
1% Scaly Blazing Star, VA Ecotype (Liatris squarrosa, VA Ecotype)
1% White Wild Indigo, SC Ecotype (Baptisia albenscens, SC Ecotype)
1% Leatherly Rush, Coastal Plain NC Ecotype (Juncus coriaceous, Coastal Plain NC Ecotype)
1% Slender Bushclover, VA Ecotype (Lespedeza virginica, VA Ecotype)
1% Rattlesnakeaster, FL Ecotype (Eryngium yuccifolium, FL Ecotype)
1% Equisetum Lokea Bierdroogje, "Suther"-NC Ecotype (Penstemon australis, "Suther"-NC Ecotype)
0.5% Gray Goldenrod, VA Ecotype (Solidago nemoralis, VA Ecotype)
0.5% Anise Goldenrod, GA Ecotype (Solidago odora, GA Ecotype)

Total: 100%

MEASURES FOR RECYCLING OR DISPOSAL OF MATERIALS

BEFORE DISPOSING OF SOIL OR RECEIVING BORROW FOR THE SITE, THE OPERATOR MUST ASSURE THAT EACH SUCH BORROW OR RECEIVING AREA HAS AN EROSION AND SEDIMENT CONTROL PLAN APPROVED BY THE COUNTY CONSERVATION DISTRICT AND WHICH IS BEING IMPLEMENTED AND MAINTAINED ACCORDING TO CHAPTER 102 REGULATIONS. ALL PAVING DEBRIS AND ROCKS REMOVE DURING FINAL LANDSCAPE RESTORATION SHALL BE COMPLETELY REMOVED FROM SITE AND DISPOSED OF IN THE PROPER MANNER. THERE SHALL BE NO ON-SITE BURIAL OR BURNING OF ANY MATERIAL.

LAND USE

EXISTING LAND USE IS INDUSTRIAL - RESEARCH AND DEVELOPMENT. THE LAND USE IN THE PAST 50 YEARS WAS AGRICULTURAL.

CRITICAL STAGES

A CRITICAL STAGE OF IMPLEMENTATION FOR WHICH A LICENSED PROFESSIONAL OR DESIGNEE WILL BE PRESENT ON SITE WILL BE FOR THE CONSTRUCTION OF THE DETENTION AND INFILTRATION BASINS AND THE UNDERGROUND INFILTRATION BASIN.

THERMAL IMPACTS

IT IS ANTICIPATED THAT THE INFILTRATION BMP'S WILL ACT TO ATTENUATE THERMAL IMPACTS.

GEOLOGIC FORMATIONS/SOIL CONDITIONS

THE SITE DOES NOT APPEAR TO HAVE NATURAL OCCURRING GEOLOGIC FORMATIONS OR SOIL CONDITIONS THAT MAY HAVE THE POTENTIAL TO CAUSE POLLUTION.

MEASURES FOR RECYCLING/DISPOSAL OF WASTES

BEFORE DISPOSING OF SOIL OR RECEIVING BORROW FOR THE SITE, THE OPERATOR MUST ASSURE THAT EACH SUCH BORROW OR RECEIVING AREA HAS AN EROSION AND SEDIMENT CONTROL PLAN APPROVED BY THE COUNTY CONSERVATION DISTRICT AND WHICH IS BEING IMPLEMENTED AND MAINTAINED ACCORDING TO CHAPTER 102 REGULATIONS. ALL PAVING DEBRIS AND ROCKS REMOVE DURING FINAL LANDSCAPE RESTORATION SHALL BE COMPLETELY REMOVED FROM SITE AND DISPOSED OF IN THE PROPER MANNER. THERE SHALL BE NO ON-SITE BURIAL OR BURNING OF ANY MATERIAL.

CONSTRUCTION WASTES EXPECTED TO BE CREATED DURING THE PROJECT CONSIST OF WOOD DEBRIS, OLD FILL MATERIAL, VEGETATIVE MATERIAL, EXCESS CONCRETE AND BUILDING MATERIAL.


DETENTION AND INFILTRATION BASINS AND AN UNDERGROUND INFILTRATION BASIN ARE THE BEST MANAGEMENT PRACTICES PROPOSED TO CONTROL STORM WATER RUNOFF AFTER CONSTRUCTION.

SOIL TYPES AND LIMITATIONS

Table with 4 columns: MAP SYMBOL & SOIL NAME, STREETS/ROAD, LAWNS & LANDSCAPING, PONDS. Shows Ugd URBAN LAND with no limitations for lawns and ponds.

RESOLUTION TO SOIL LIMITATIONS

Table with 4 columns: MAP SYMBOL & SOIL NAME, STREETS/ROAD, LAWNS & LANDSCAPING, PONDS. Shows Ugd URBAN LAND with no limitations for lawns and ponds.

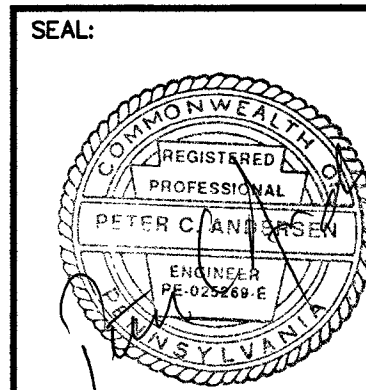

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FIELD BK/PG -/- AEA JOB NO.: 5365 AEA FILE NO.: 5365SITE

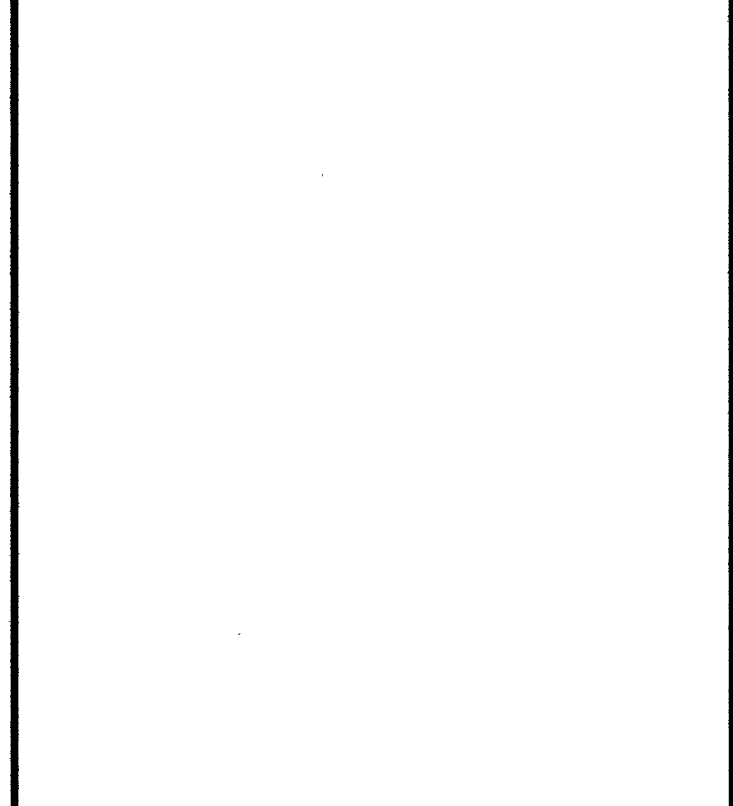
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NOTES REFERENCE DRAWINGS LEGEND

Table with 3 columns: PAGE No., DRAWING No., TITLE

Table with 3 columns: REVISION, DATE REVISED, CONTROL NUMBER. Contains multiple revision entries.

KEY PLAN



do more feel better live longer UPPER MERION R&D FACILITIES CAPITAL PROJECTS, ENGINEERING AND DESIGN 709 SWEDELAND ROAD KING-OF-PRUSSIA, PA 19406 (610) 270-5261

UPPER MERION CENTRAL UTILITIES PLANT Note: Previous Drawing Reference can be used for old drawing numbers or any previous reference that needs to be retained.

PROPOSED CENTRAL UTILITIES PLANT (CUP) BUILDING

POST CONSTRUCTION STORMWATER MANAGEMENT NOTES AND DETAILS SHEET NO. 20 OF 21

00-00-020

